

LIAQUAT UNIVERSITY OF MEDICIAL & HEALTH SCIENCE JAMSHORO

UPGRADATION AND IMPROVEMENT OF PEOPLE NURSING SCHOOL, LIAQUAT UNIVERSITY OF MEDICIAL & HEALTH SCIENCE JAMSHORO

LHUMS LIBRARY BLOCK TENDER DRAWINGS FEB 2024

DESIGN BY



NEW VISION ENGINEERING CONSULTANT

HEAD OFFICE:

Office No.B-6 Second Floor Masood Arcade IJP Road Islamabad.

Ph: +92-51-4848375, Fax: +92-51-4848375 Email: newvisionec@yahoo.com **REGIONAL OFFICE:**


287-A Street # 6, Cavalry Ground ,Lahore Ph: +92-42-37250130

	LIST OF DRAWINGS					
S.NO.	DRAWING TITLE	DRG. NO				
	ARCHITECTURE DRAWINGS					
1	LIST OF DRAWING	LS-00				
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		ADDITION & REVISION					NEW VISION ENGINEERING CONSULTANT Head Office: Office No.B-6 Second Floor Masood Arcade	PROJECT:	UPGRADATION AND IMPROVEMENT OF PEOPLE NURSING SCHOOL, LIAQUAT UNIVERSITY OF MEDICIAL & HEALTH		AT UNIVERSITY OF ME	
						NVEC	IJP Road Islamabad. Ph: +92-51-4848375, Fax: +92-51-4848375	TITLE:	SCIENCE JAMSHORO	DESIGNED BY: AR.SALMAN	APPROVED BY: A.S	DATE : FEB-2024
							Email: newvisionec@yahoo.com Regional Office: 287-A Street # 6, Cavalry Ground ,Lahore		LIST OF DRAWINGS	DRAWN BY: RANA ALI HAIDER	JOB NO.	SCALE: N.T.S
ADD./REV. NO	. DATE	DESCRIPTION	DES. BY	CHK. E	BY APP. BY	r.	Ph: +92-42-37250130	CAD filenar	ne:	DRG. NO.	LS-00	

MASTER PLAN





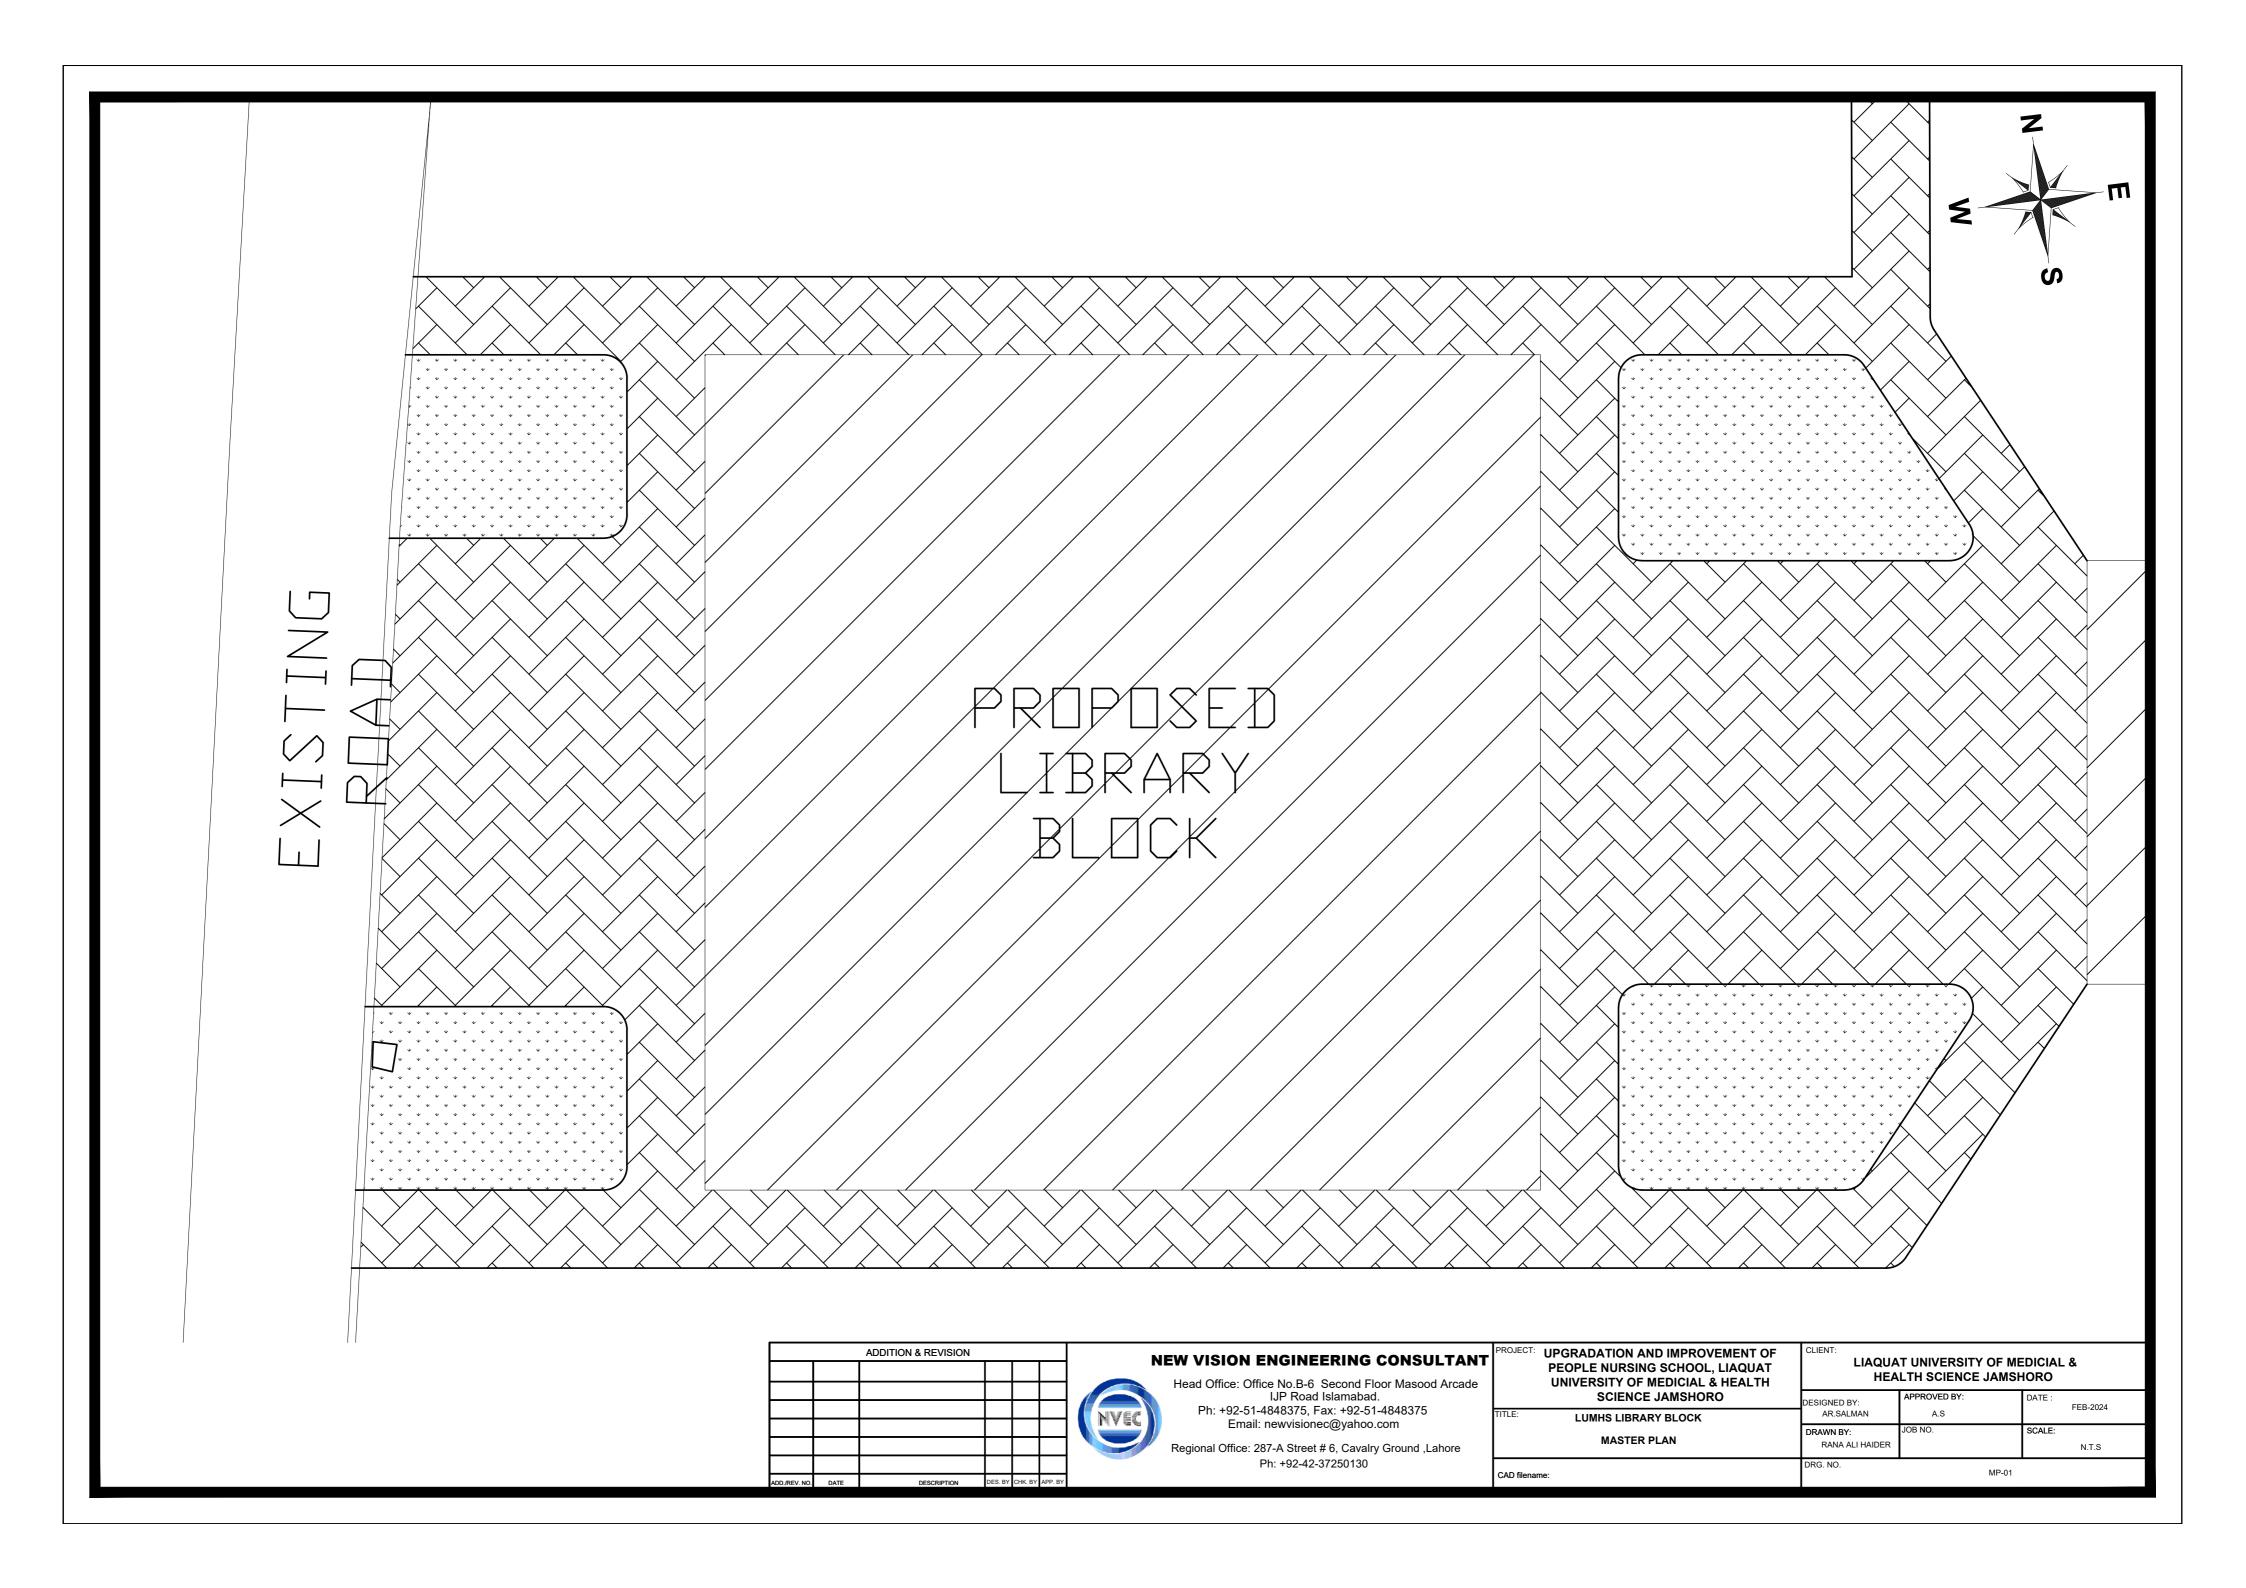








		ADDITION & REVISION				NEW VISION ENGINEERING		PEOPLE NURSING SCHOOL, LIAQUAT		T UNIVERSITY OF ME	
						Head Office: Office No.B-6 Second F IJP Road Islamaba	d.	UNIVERSITY OF MEDICIAL & HEALTH SCIENCE JAMSHORO	DESIGNED BY:		DATE : FEB-2024
						Ph: +92-51-4848375, Fax: +92-5 Email: newvisionec@yaho		LUMHS LIBRARY BLOCK	AR.SALMAN	A.S JOB NO.	SCALE:
						Regional Office: 287-A Street # 6, Cava	y Ground ,Lahore	3D VIEW	RANA ALI HAIDER		N.T.S
						Ph: +92-42-37250130	CAD filen		DRG. NO.	3D-01	
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ARCHITECTURAL PLAN



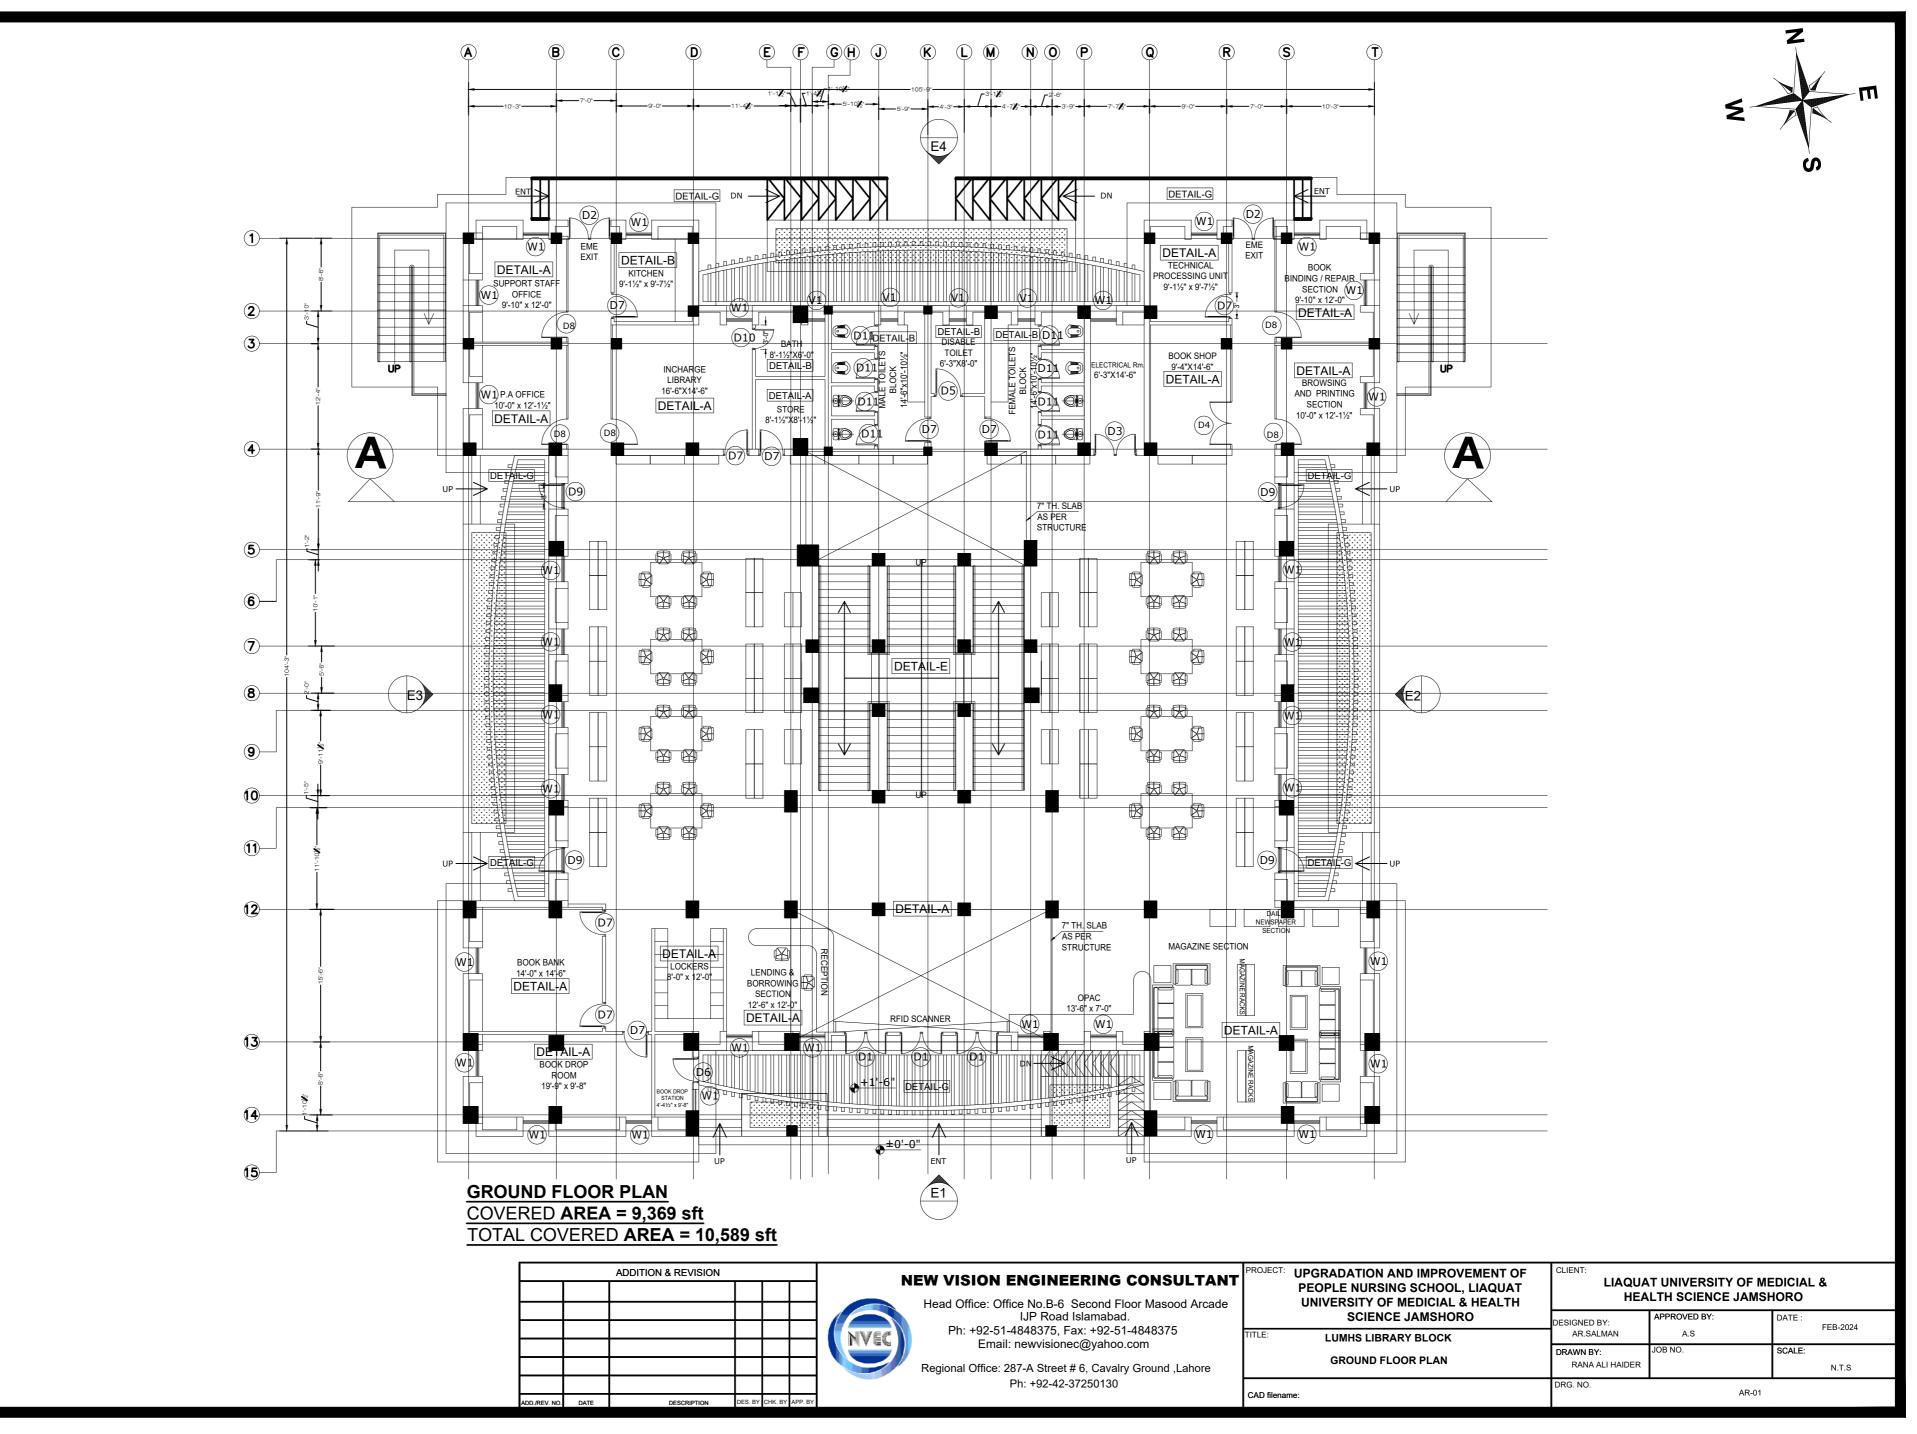

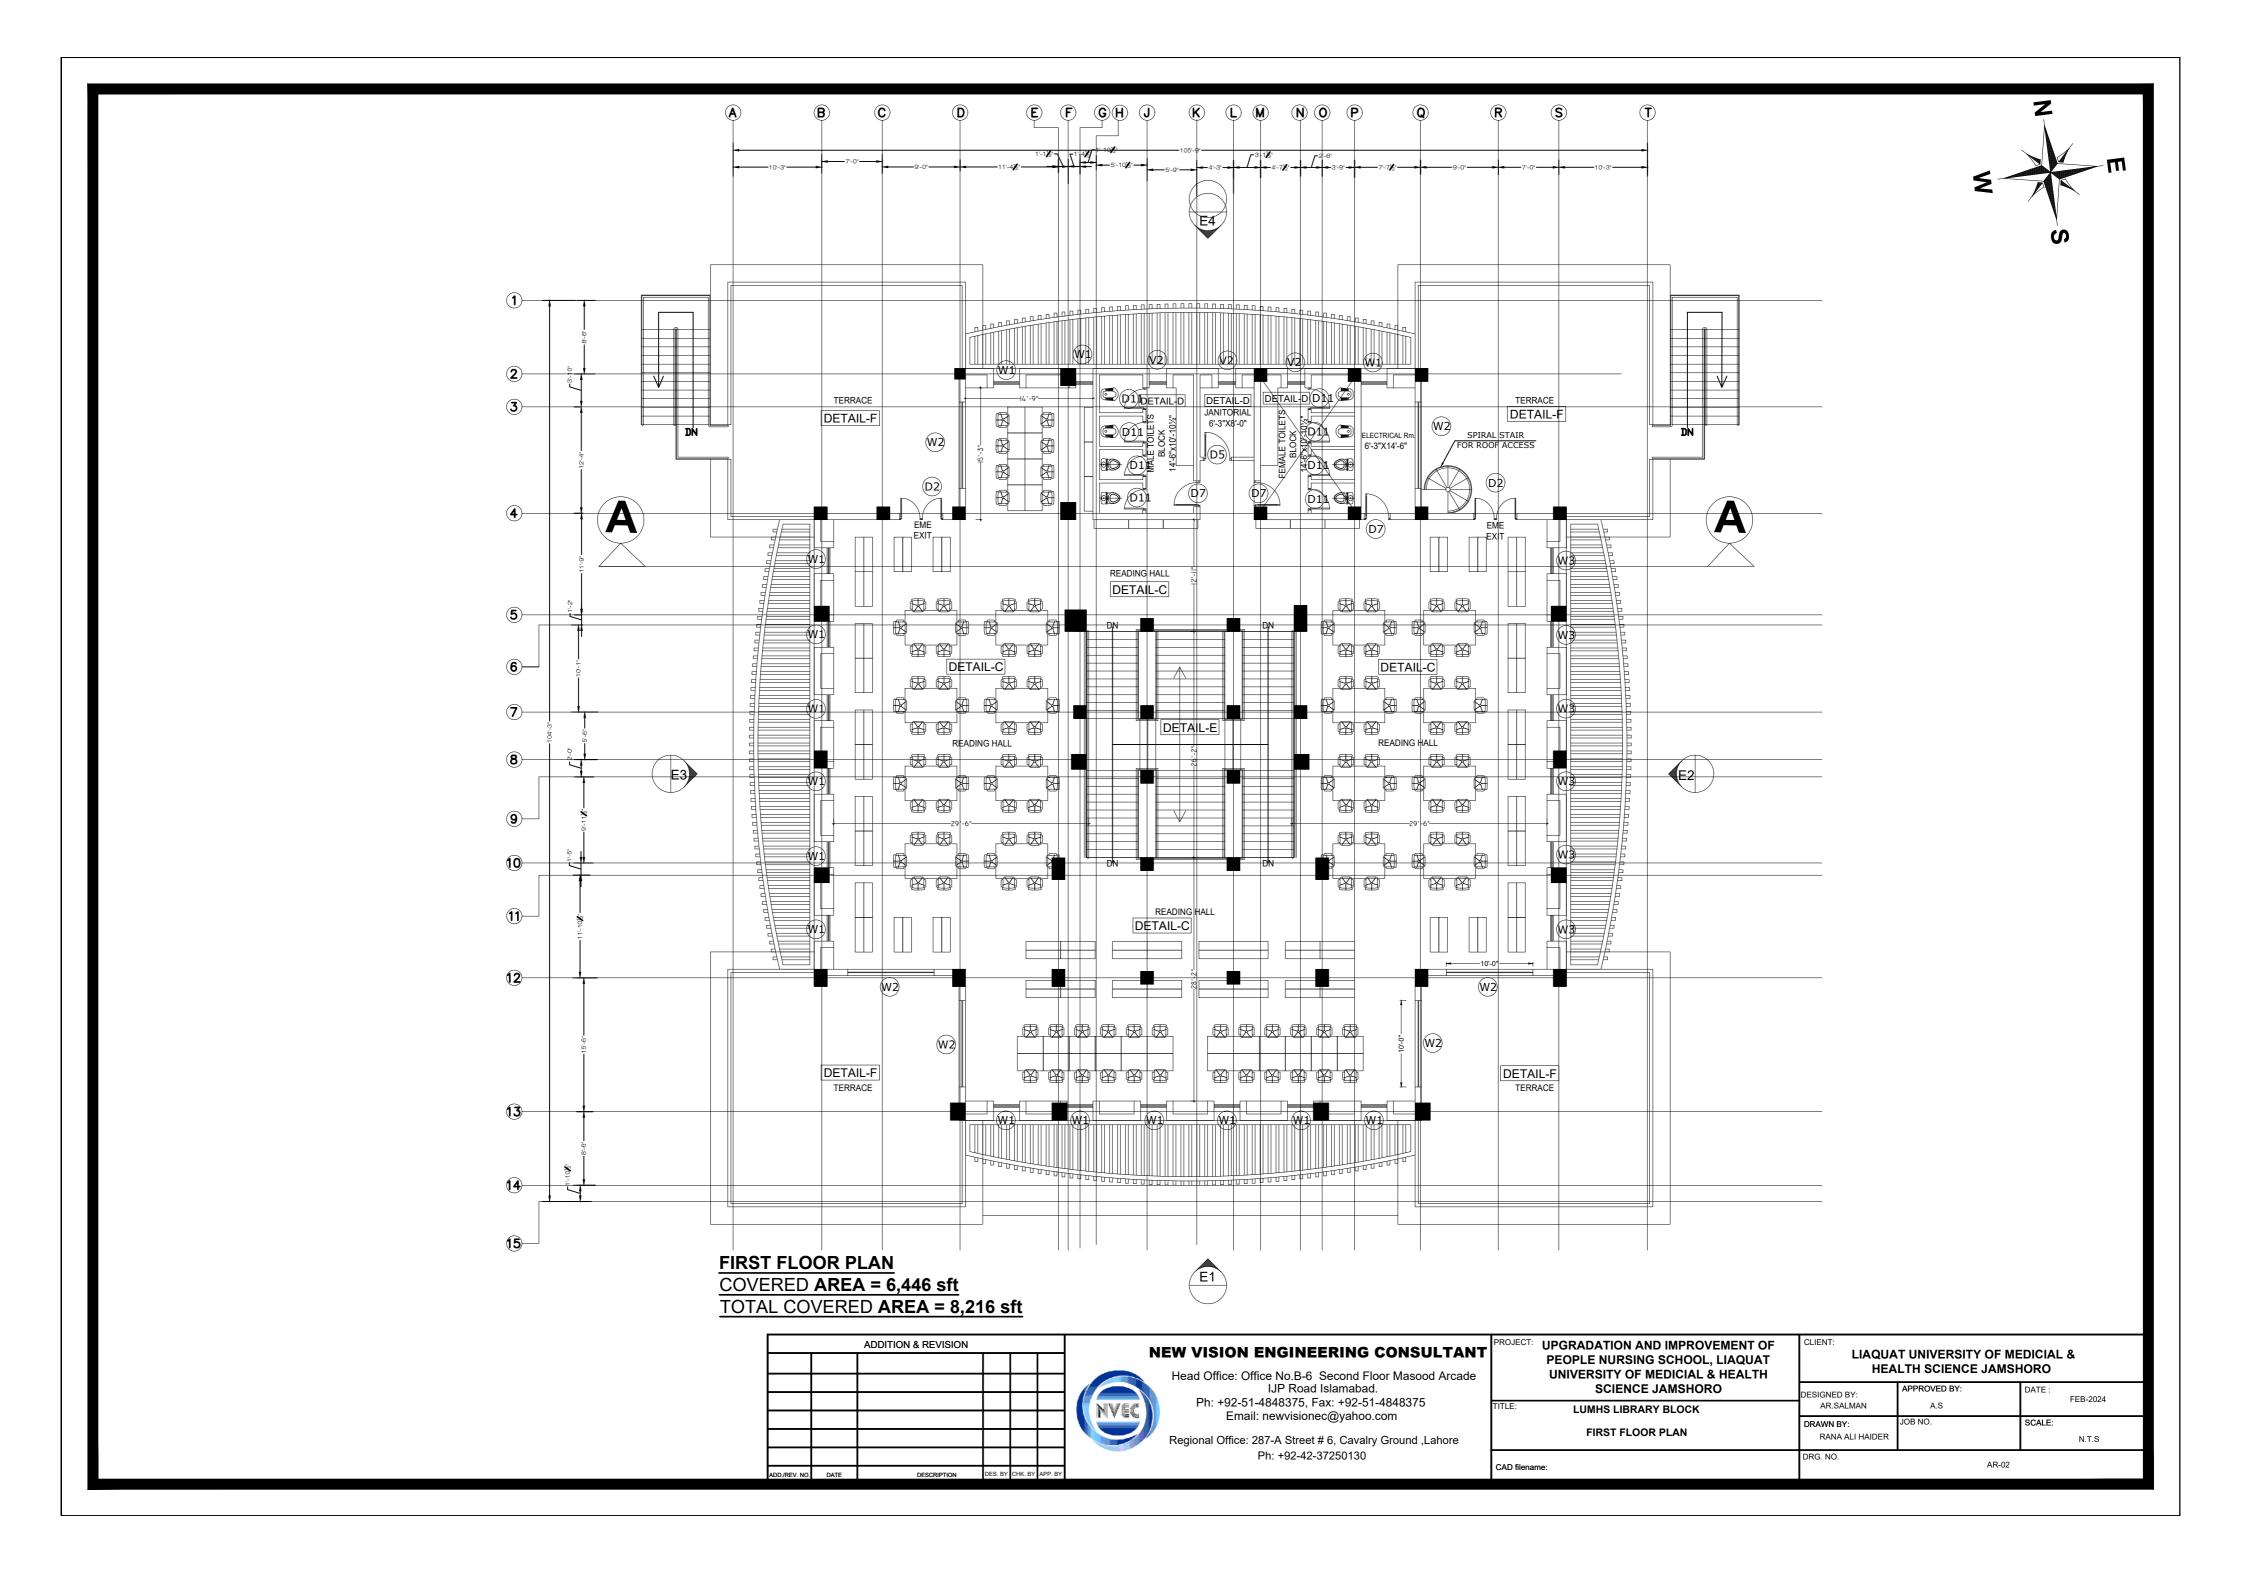

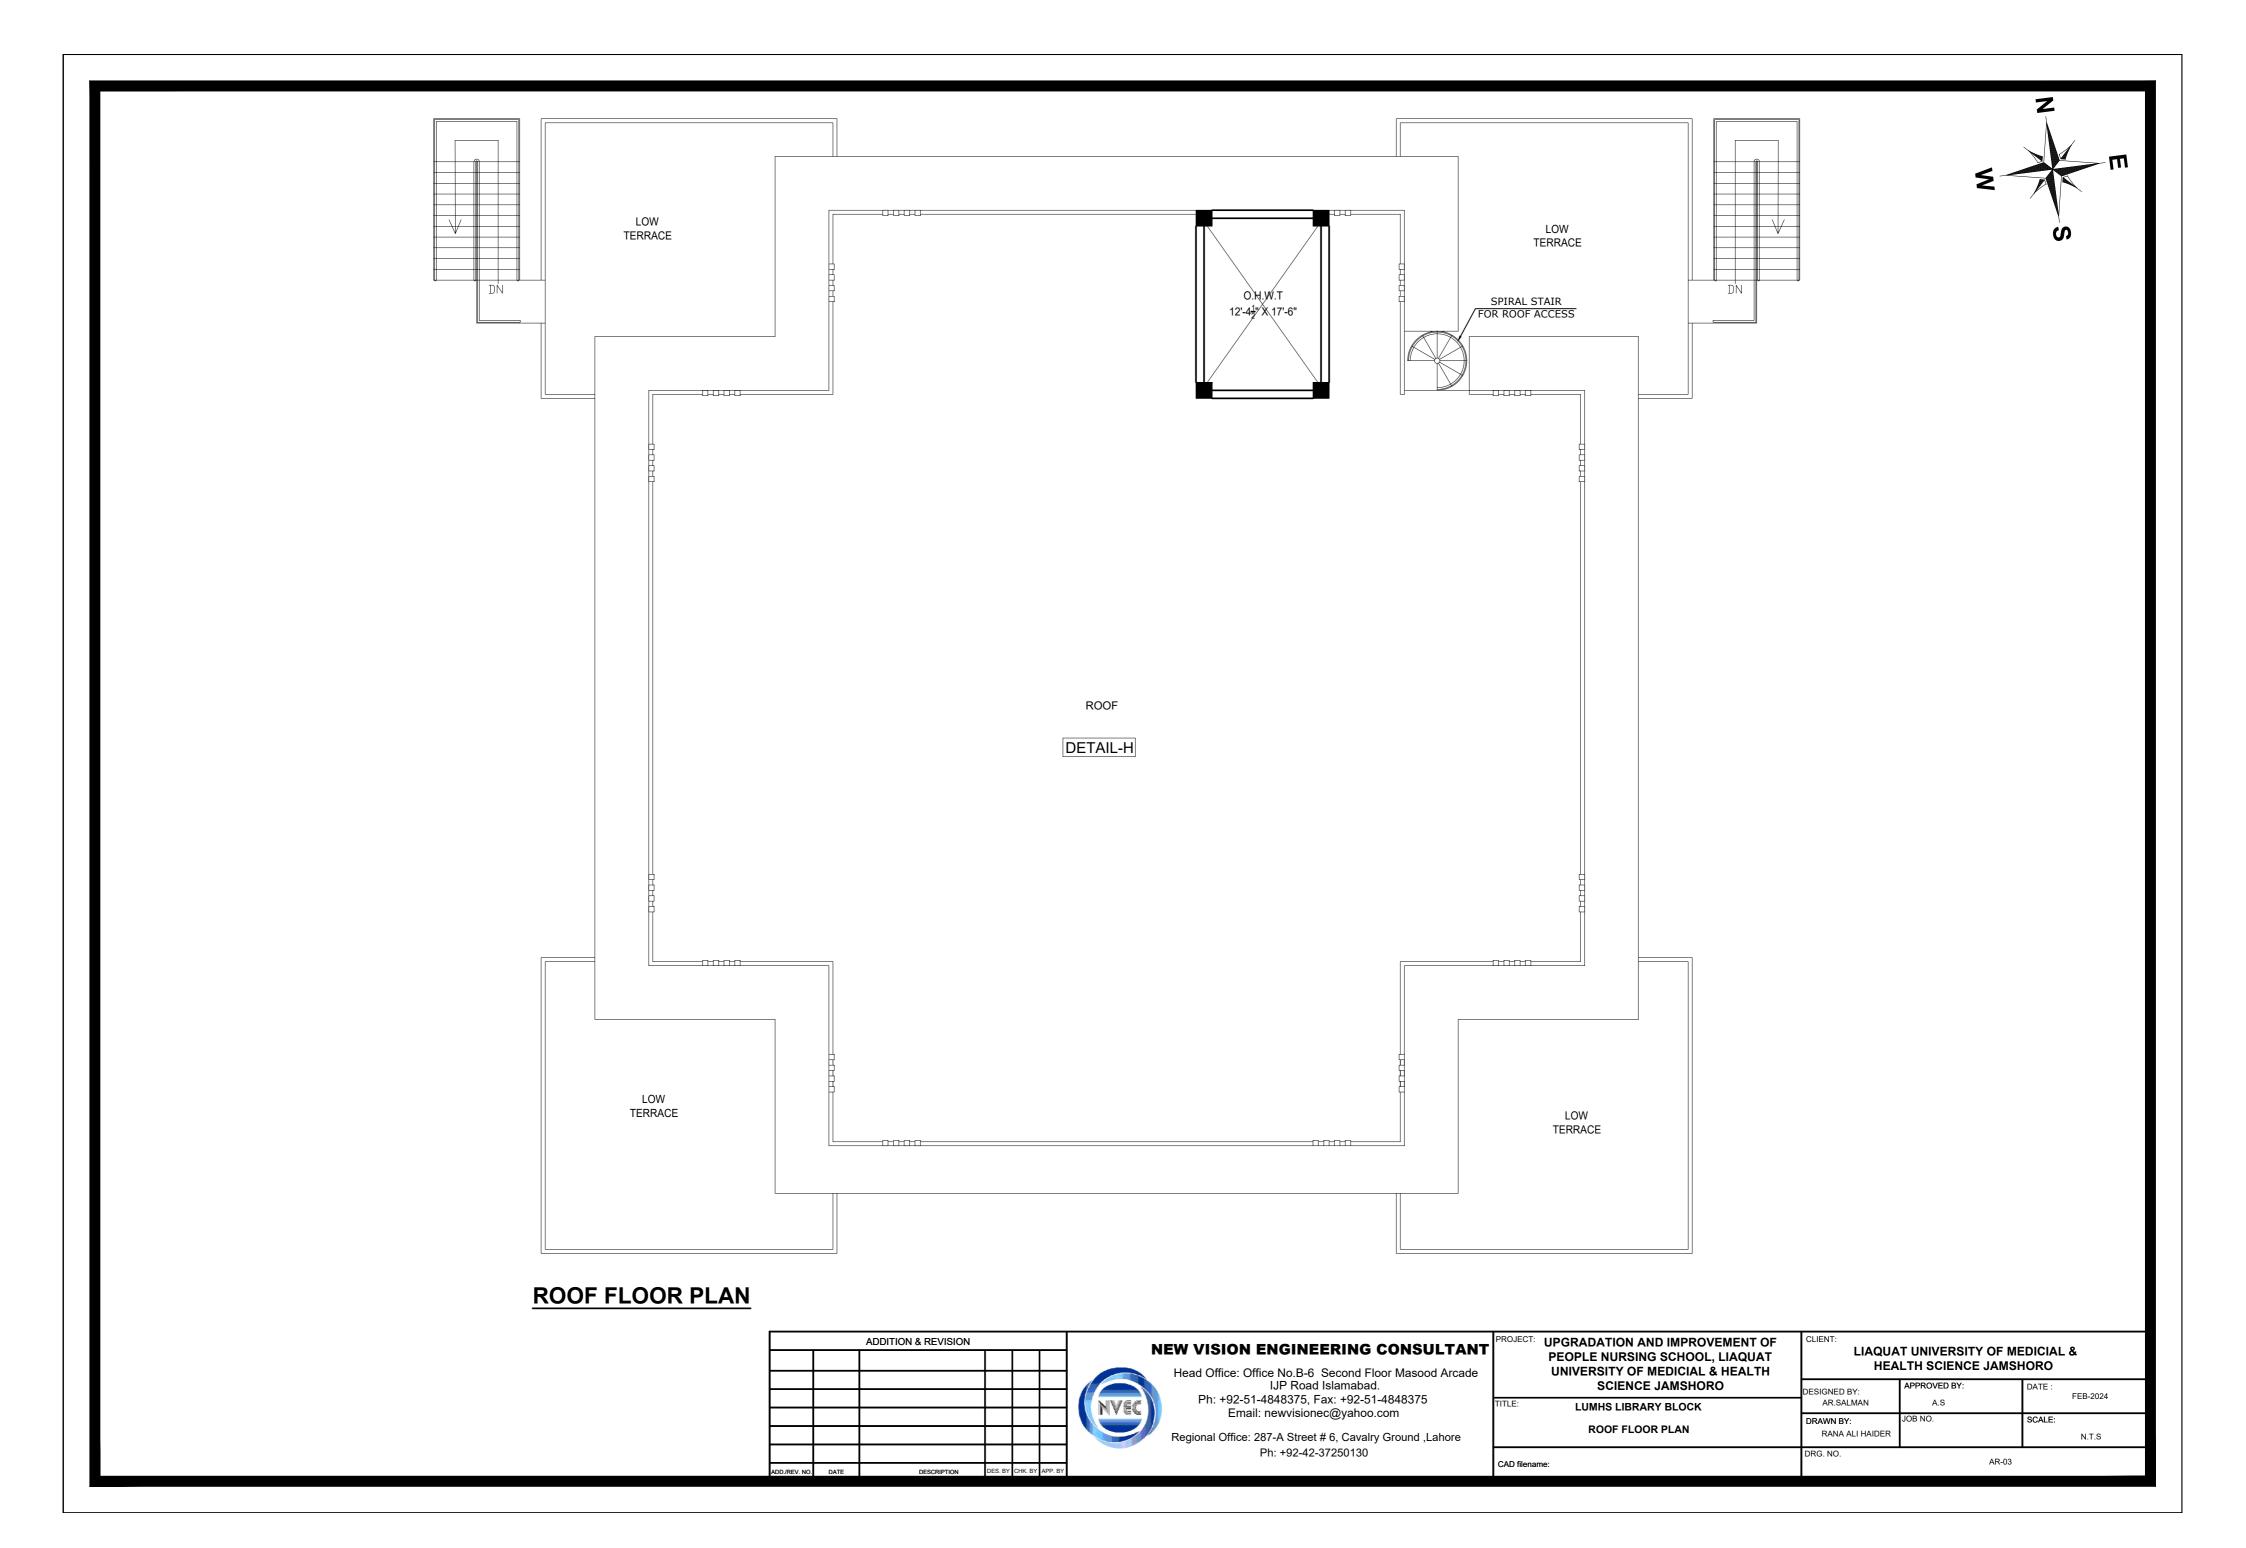AREAS DET

GROUND FLOOR COVER

COVERED AREA SLAB 1

COVERED AREA SLAB 2

COVERED AREA OF SHEDS

TOTAL COVERED AREA

FIRST FLOOR COVERED


COVERED AREA

COVERED AREA OF SHEDS


TOTAL COVERED AREA


TOTAL COVERED AF

GRAND TOTAL OF COVERED AREA

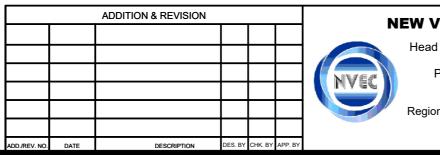


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ERED AREA						
	9,369 SF	Γ				
	572 SFT		_			
	648 SFT					
	10,589 SI	-T				
D AREA						
	6,446 SF	Γ				
	1,770 SF	Γ				
	8,216 SF	Γ				
AREA						
	18,805 SI	-T				
VISION ENGINEERIN ead Office: Office No.B-6 Second IJP Road Islama	d Floor Masood Arcade bad.	PEOPLE NU UNIVERSIT	ON AND IMPROVEMENT OF RSING SCHOOL, LIAQUAT Y OF MEDICIAL & HEALTH ENCE JAMSHORO		AT UNIVERSITY OF M ALTH SCIENCE JAMS APPROVED BY:	DATE :
Ph: +92-51-4848375, Fax: +92 Email: newvisionec@yah	2-51-4848375 100.com		LIBRARY BLOCK EAS DETAIL	AR.SALMAN DRAWN BY: RANA ALI HAIDER	A.S JOB NO.	FEB-2024 SCALE:
gional Office: 287-A Street # 6, Cav Ph: +92-42-3725013		CAD filename:		DRG. NO.	AR-04	N.T.S

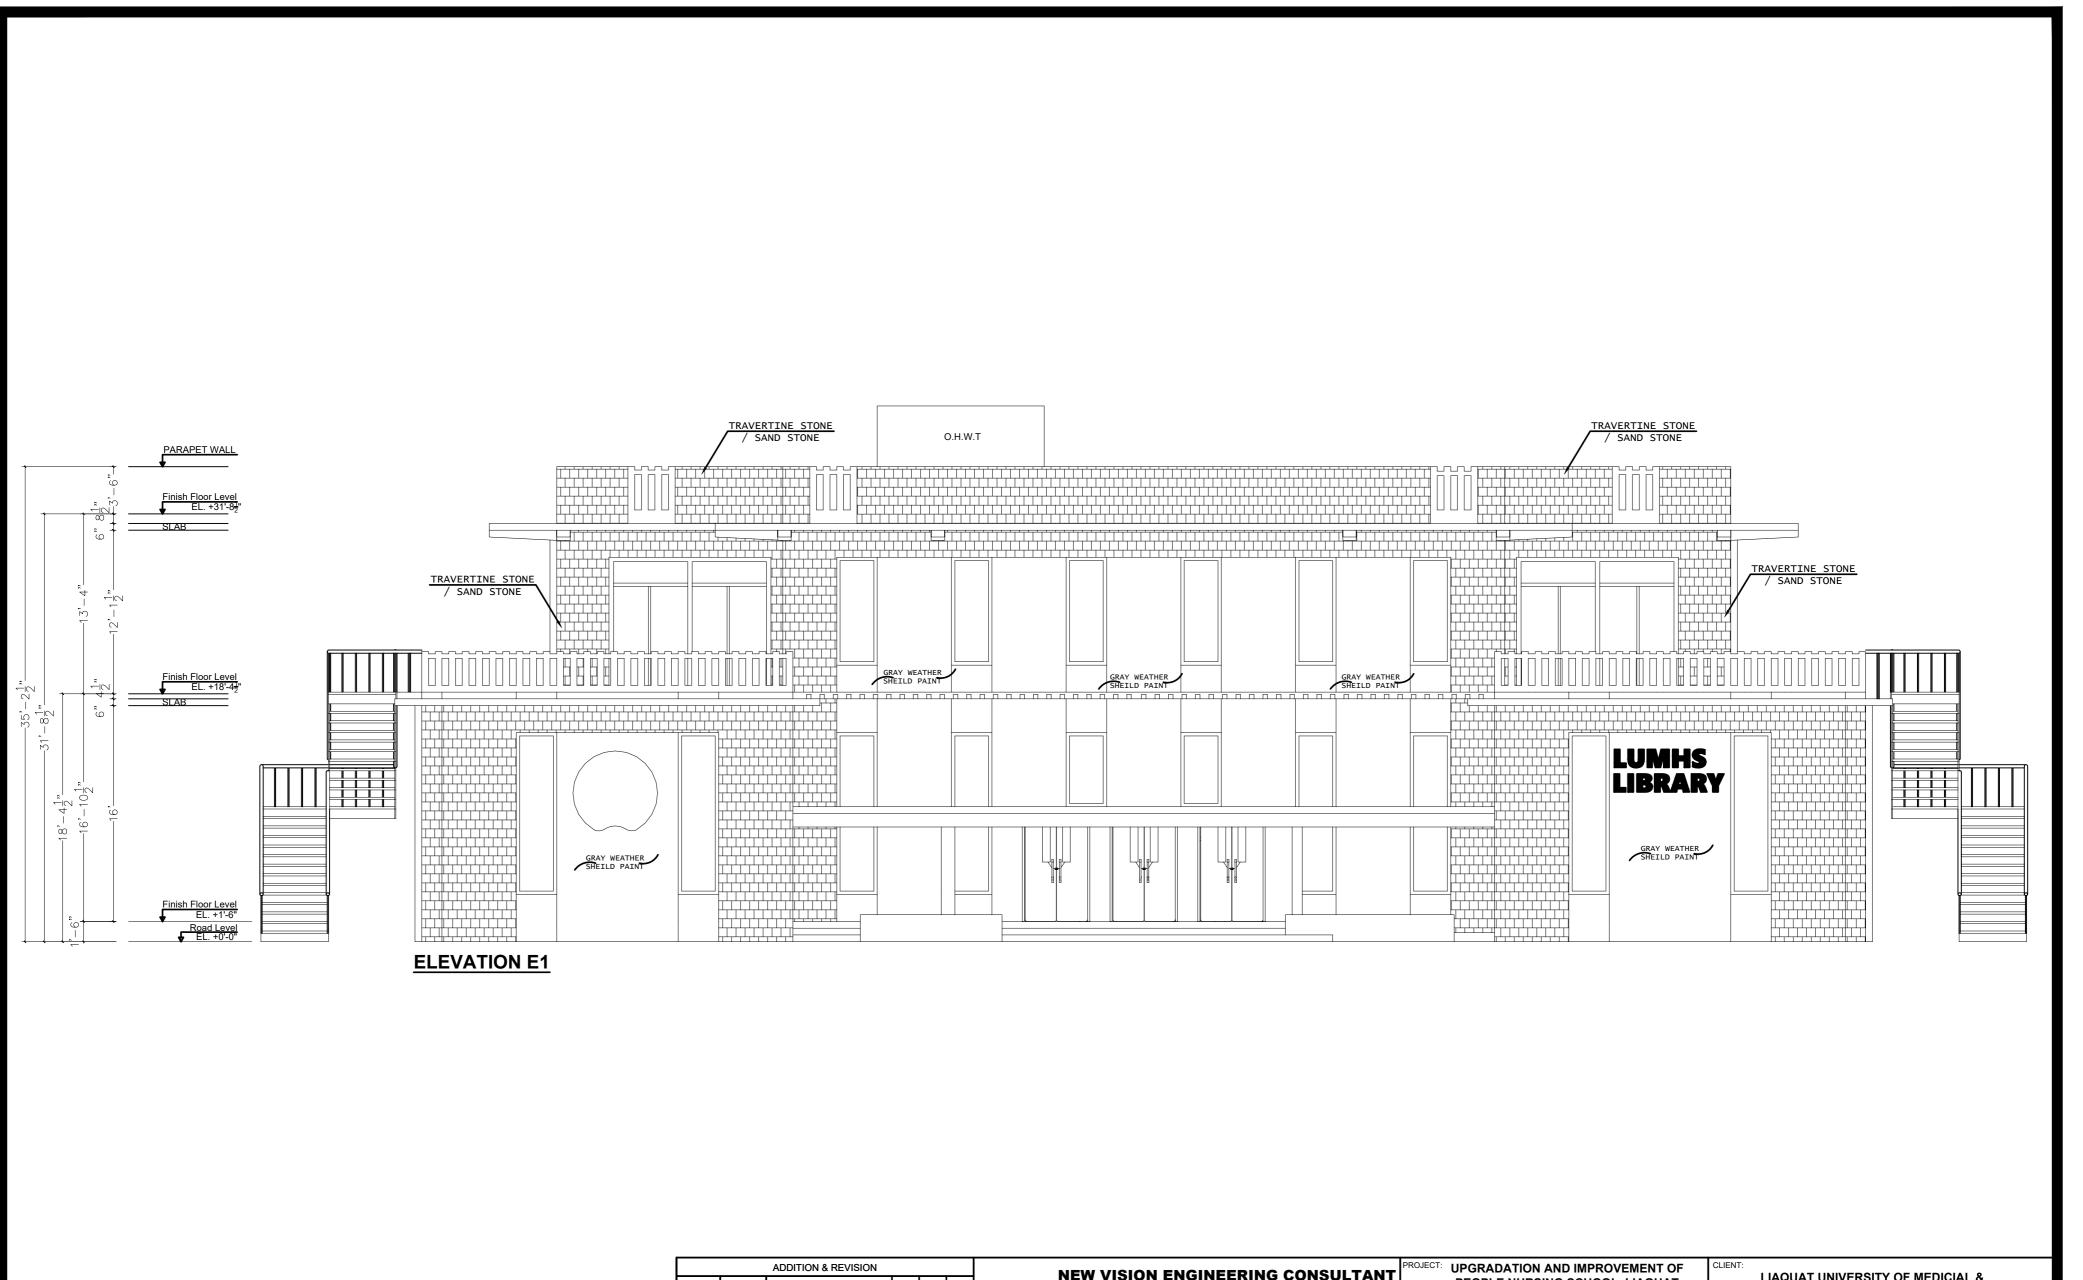

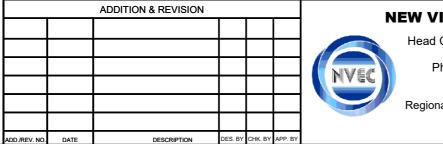



VISION ENGINEERING CONSULTANT d Office: Office No.B-6 Second Floor Masood Arcade	PROJECT: UPGRADATION AND IMPROVEMENT OF PEOPLE NURSING SCHOOL, LIAQUAT UNIVERSITY OF MEDICIAL & HEALTH	CLIENT: LIAQUAT UNIVERSITY OF MEDICIAL & HEALTH SCIENCE JAMSHORO			
IJP Road Islamabad.	SCIENCE JAMSHORO	DESIGNED BY:	APPROVED BY:	DATE : FEB-2024	
Ph: +92-51-4848375, Fax: +92-51-4848375 Email: newvisionec@yahoo.com	TITLE: LUMHS LIBRARY BLOCK	AR.SALMAN	A.S	1 25-2024	
	ELEVATION 1	DIVANIN DI.	JOB NO.	SCALE:	
onal Office: 287-A Street # 6, Cavalry Ground ,Lahore		RANA ALI HAIDER		N.T.S	
Ph: +92-42-37250130	CAD filename:	DRG. NO.	AR-05		


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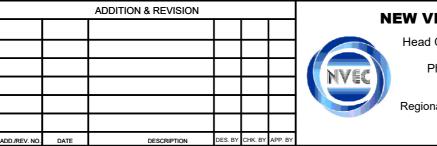


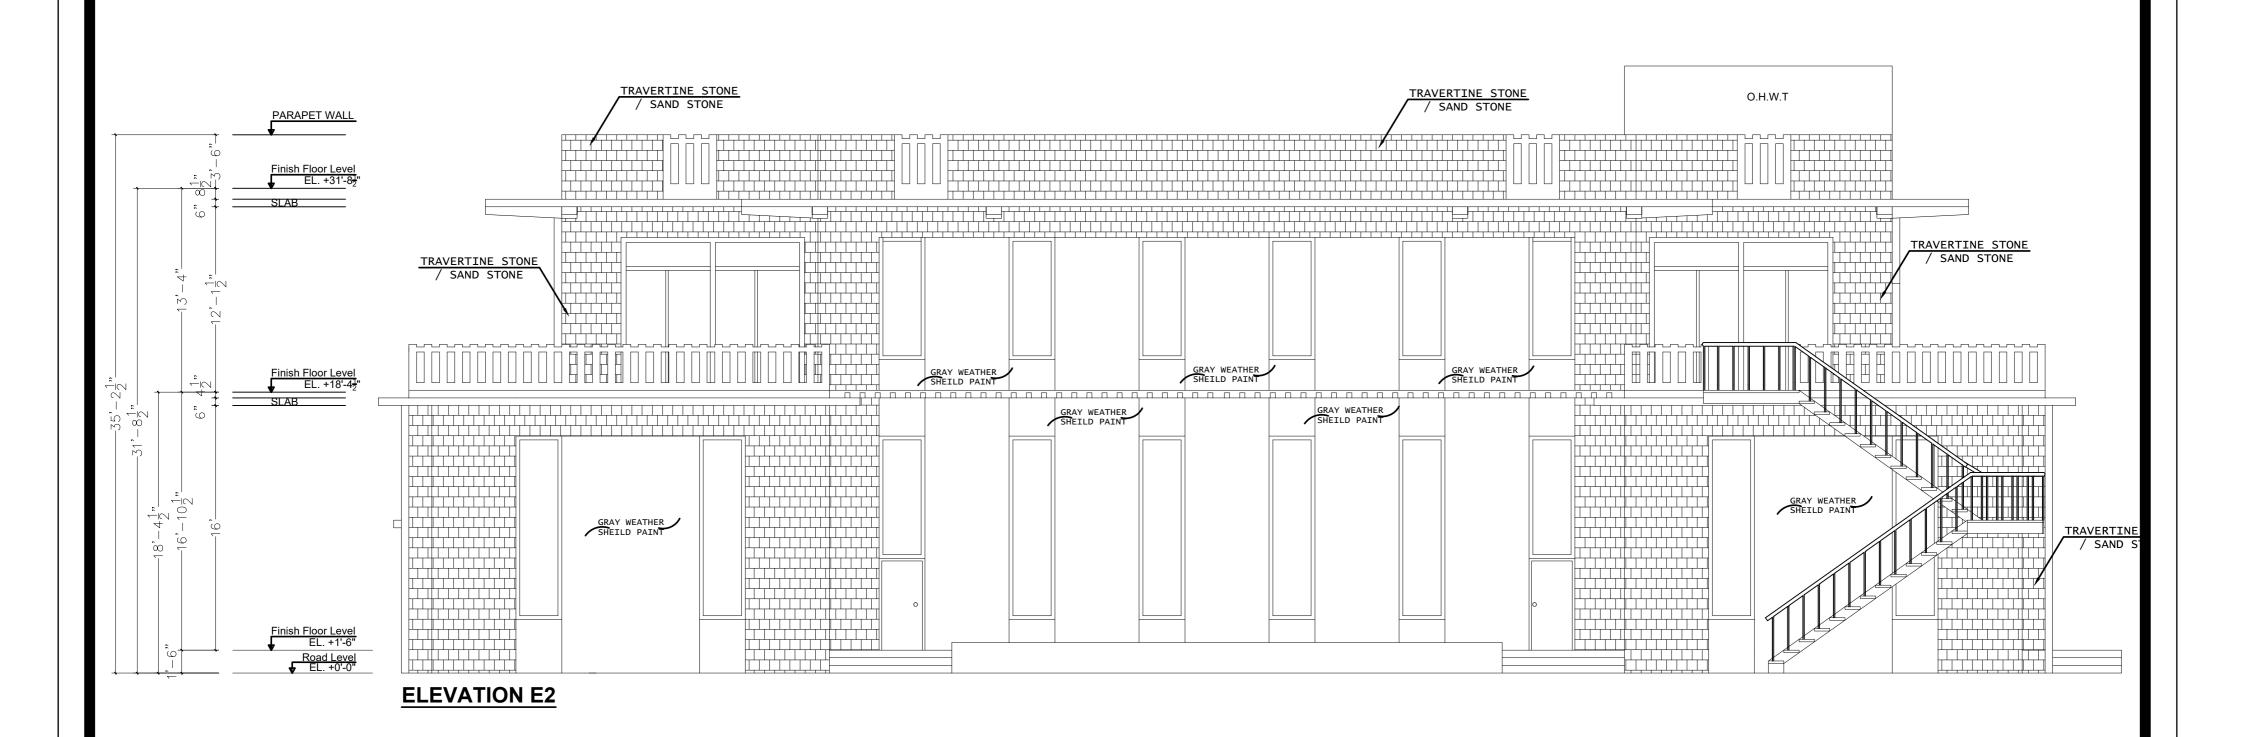VISION ENGINEERING CONSULTANT d Office: Office No.B-6 Second Floor Masood Arcade	PROJECT: UPGRADATION AND IMPROVEMENT OF PEOPLE NURSING SCHOOL, LIAQUAT UNIVERSITY OF MEDICIAL & HEALTH	CLIENT: LIAQUAT UNIVERSITY OF MEDICIAL & HEALTH SCIENCE JAMSHORO			
IJP Road Islamabad.	SCIENCE JAMSHORO	DESIGNED BY:	APPROVED BY:	DATE : FEB-2024	
Ph: +92-51-4848375, Fax: +92-51-4848375 Email: newvisionec@yahoo.com	TITLE: LUMHS LIBRARY BLOCK	AR.SALMAN	A.S		
	ELEVATION 2	DRAWN BY:	JOB NO.	SCALE:	
onal Office: 287-A Street # 6, Cavalry Ground ,Lahore		RANA ALI HAIDER		N.T.S	
Ph: +92-42-37250130	CAD filename:	DRG. NO. AR-06			




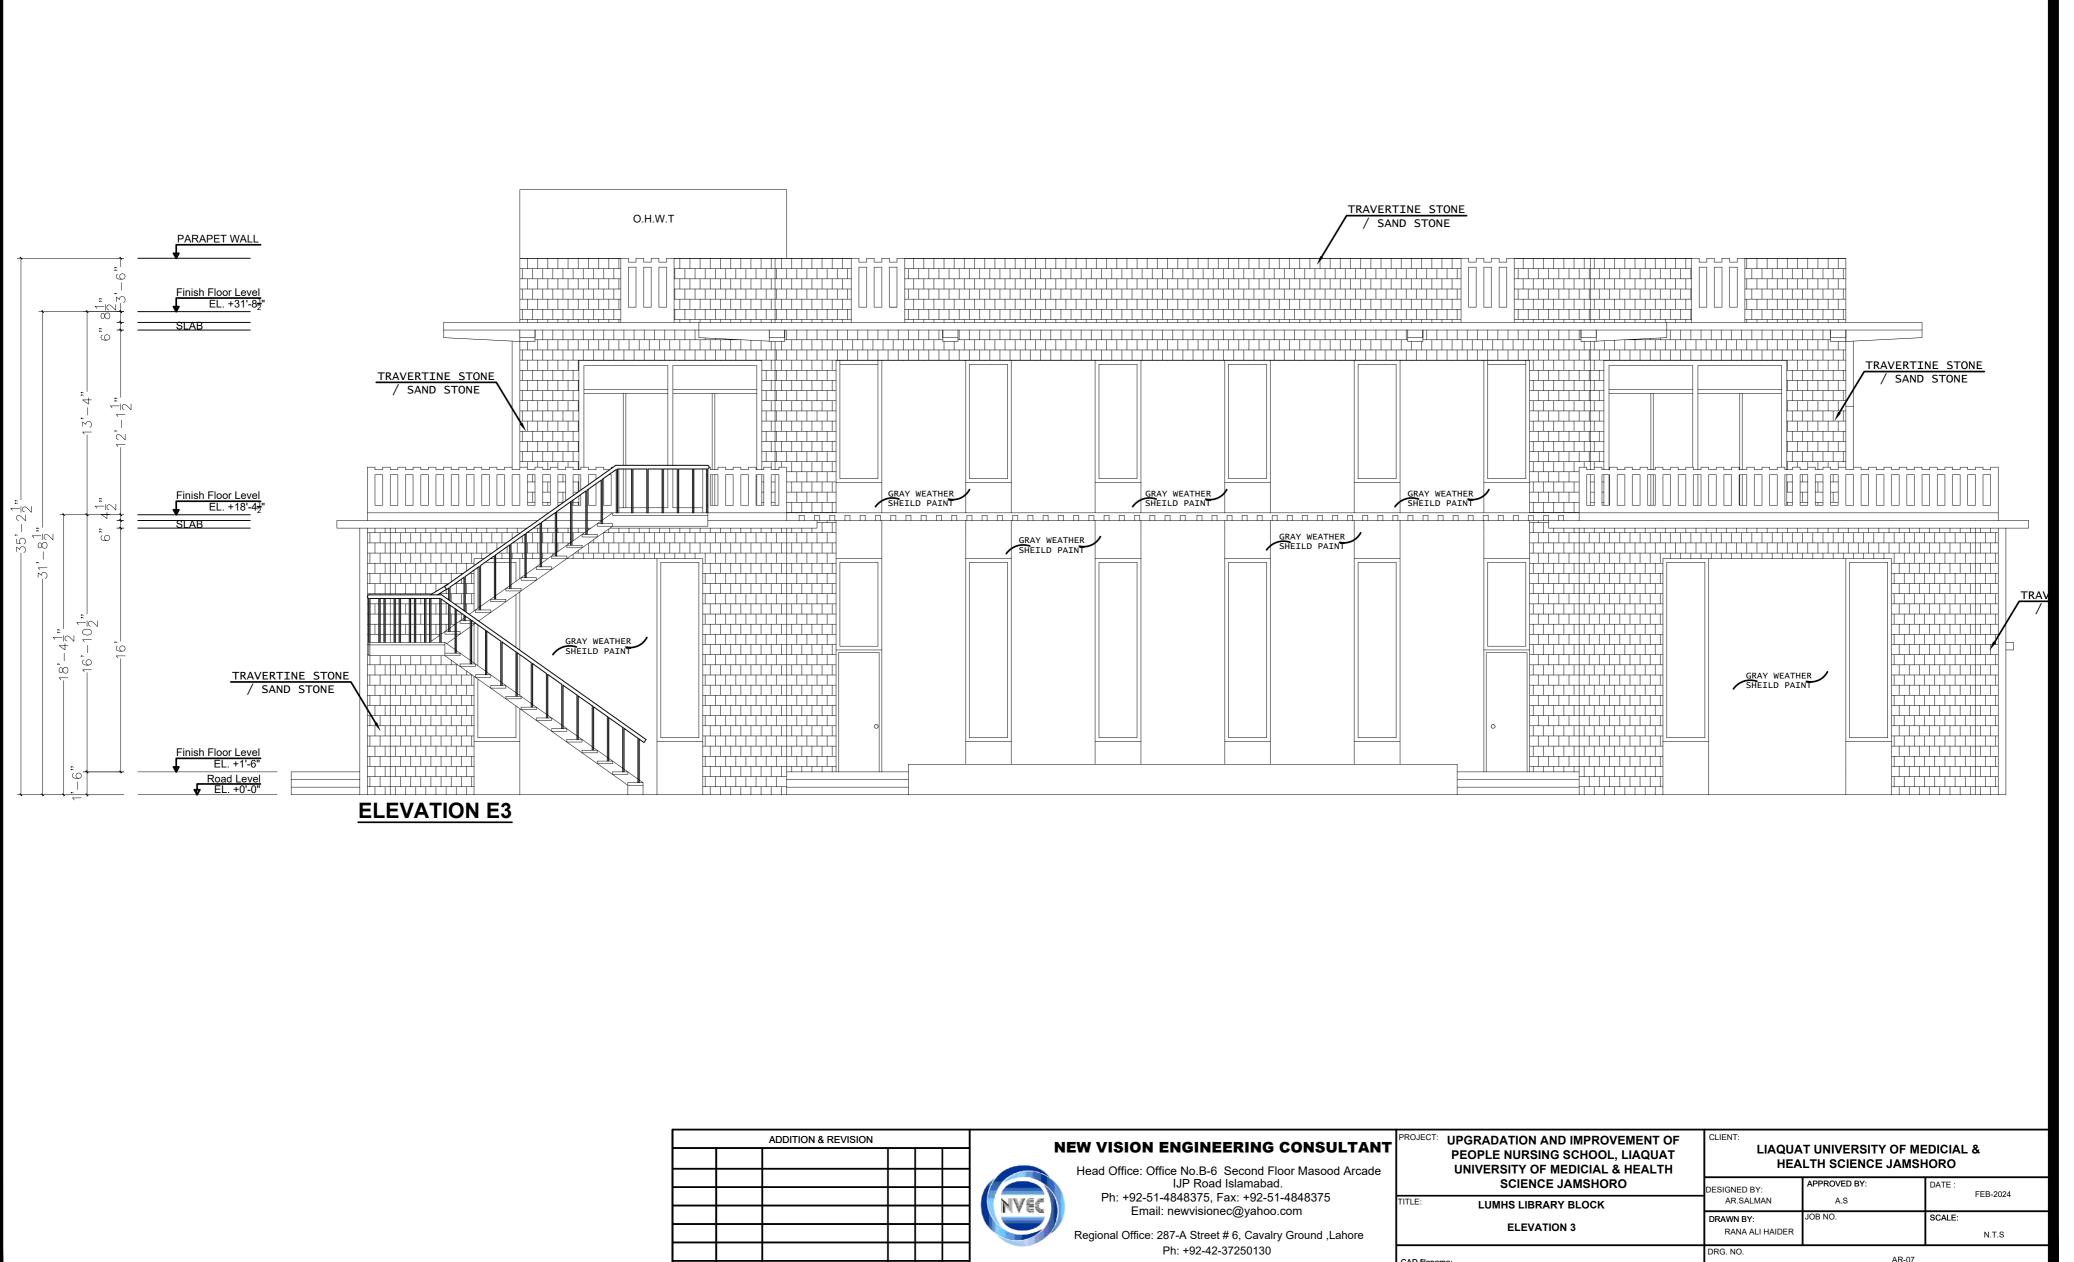


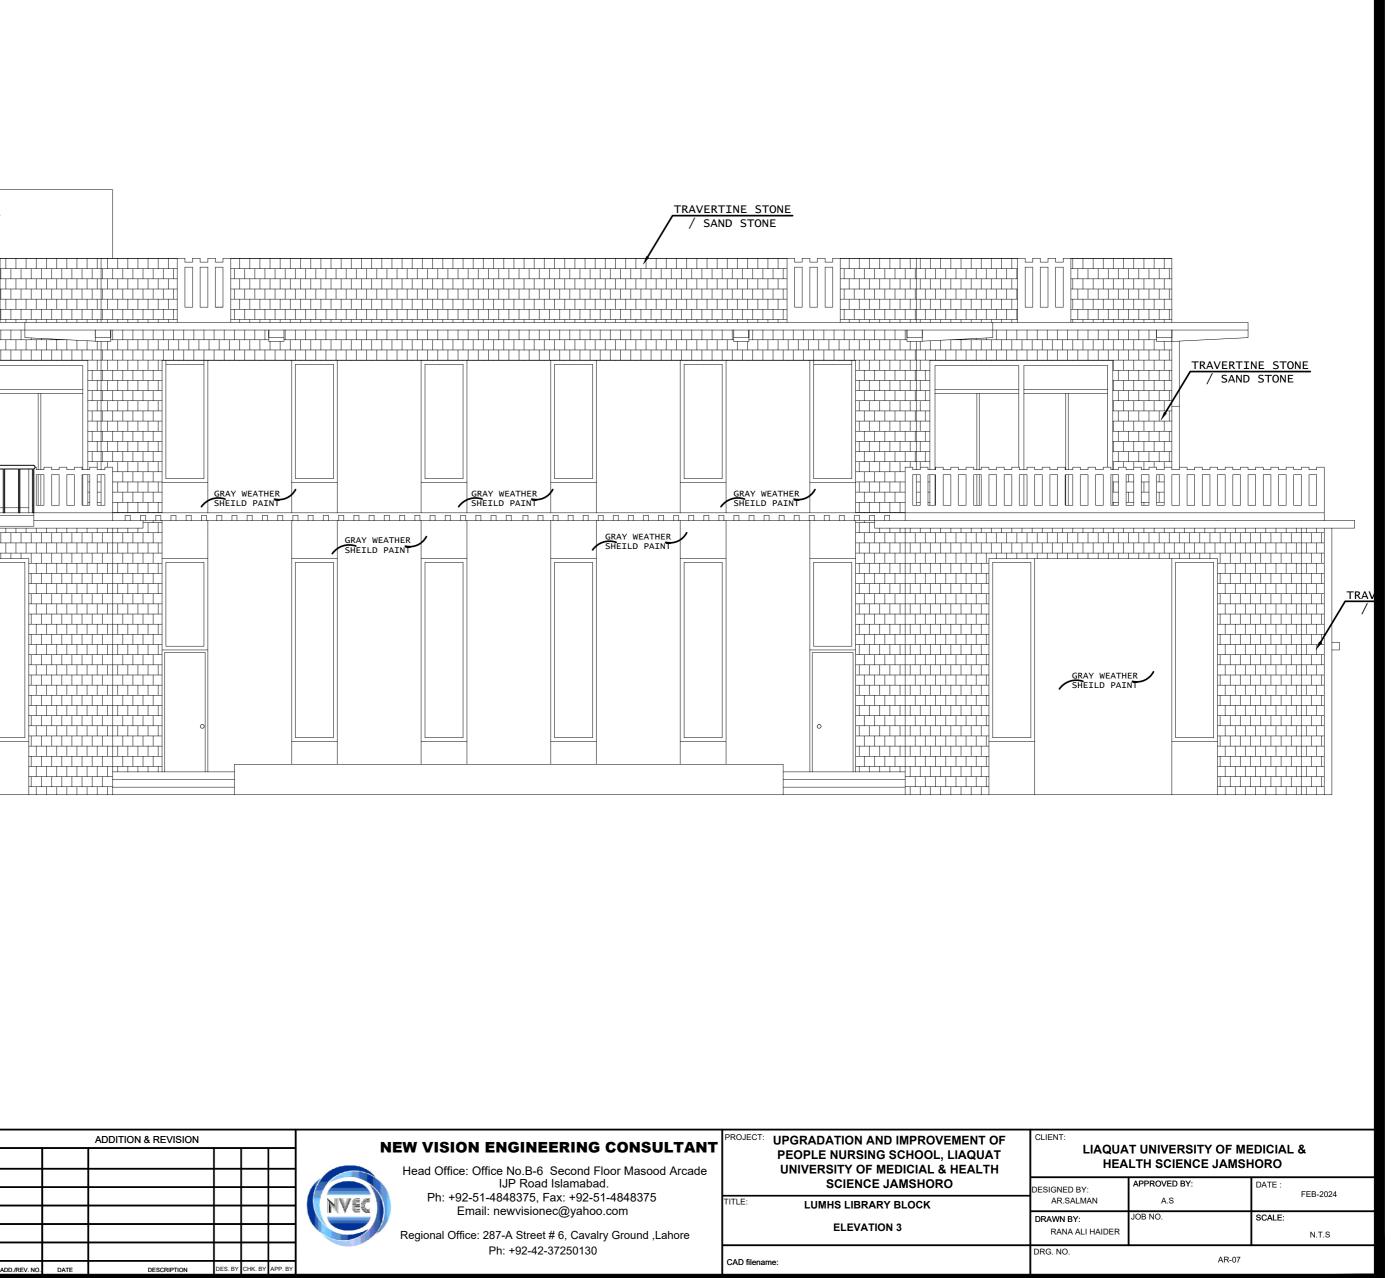

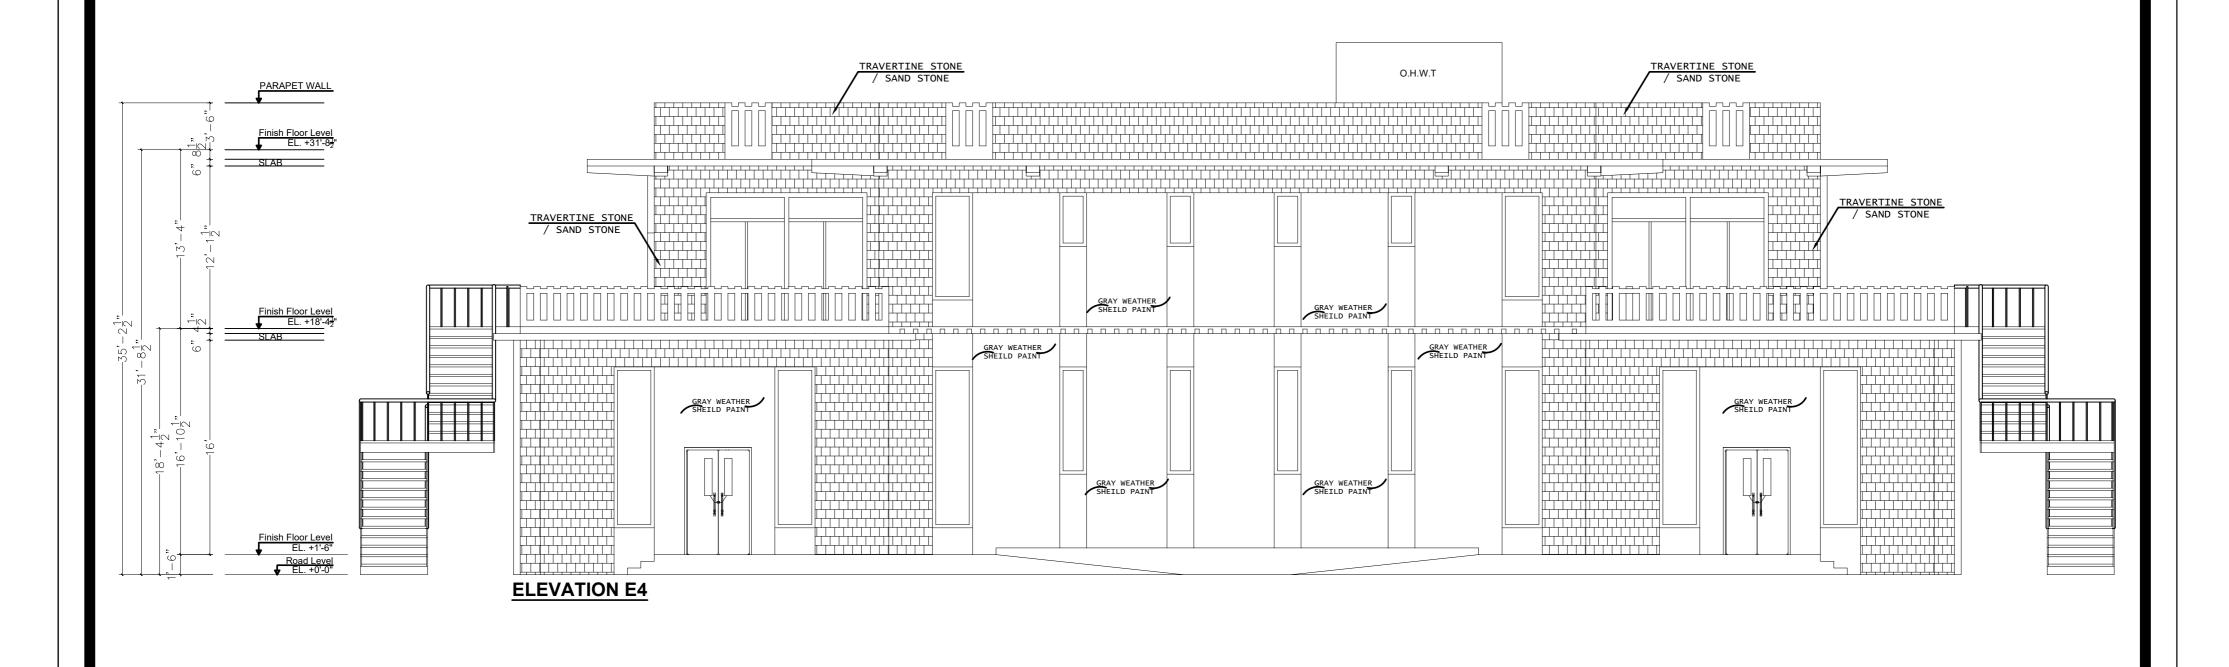


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IJP Road Islamabad.	SCIENCE JAMSHORO	DESIGNED BY:	APPROVED BY:	DATE : FEB-2024	
Ph: +92-51-4848375, Fax: +92-51-4848375 Email: newvisionec@yahoo.com	TITLE: LUMHS LIBRARY BLOCK	AR.SALMAN	A.S		
	ELEVATION 4	DIVATIN DT.	JOB NO.	SCALE:	
ional Office: 287-A Street # 6, Cavalry Ground ,Lahore		RANA ALI HAIDER		N.T.S	
Ph: +92-42-37250130	CAD filename:	DRG. NO. AR-08			

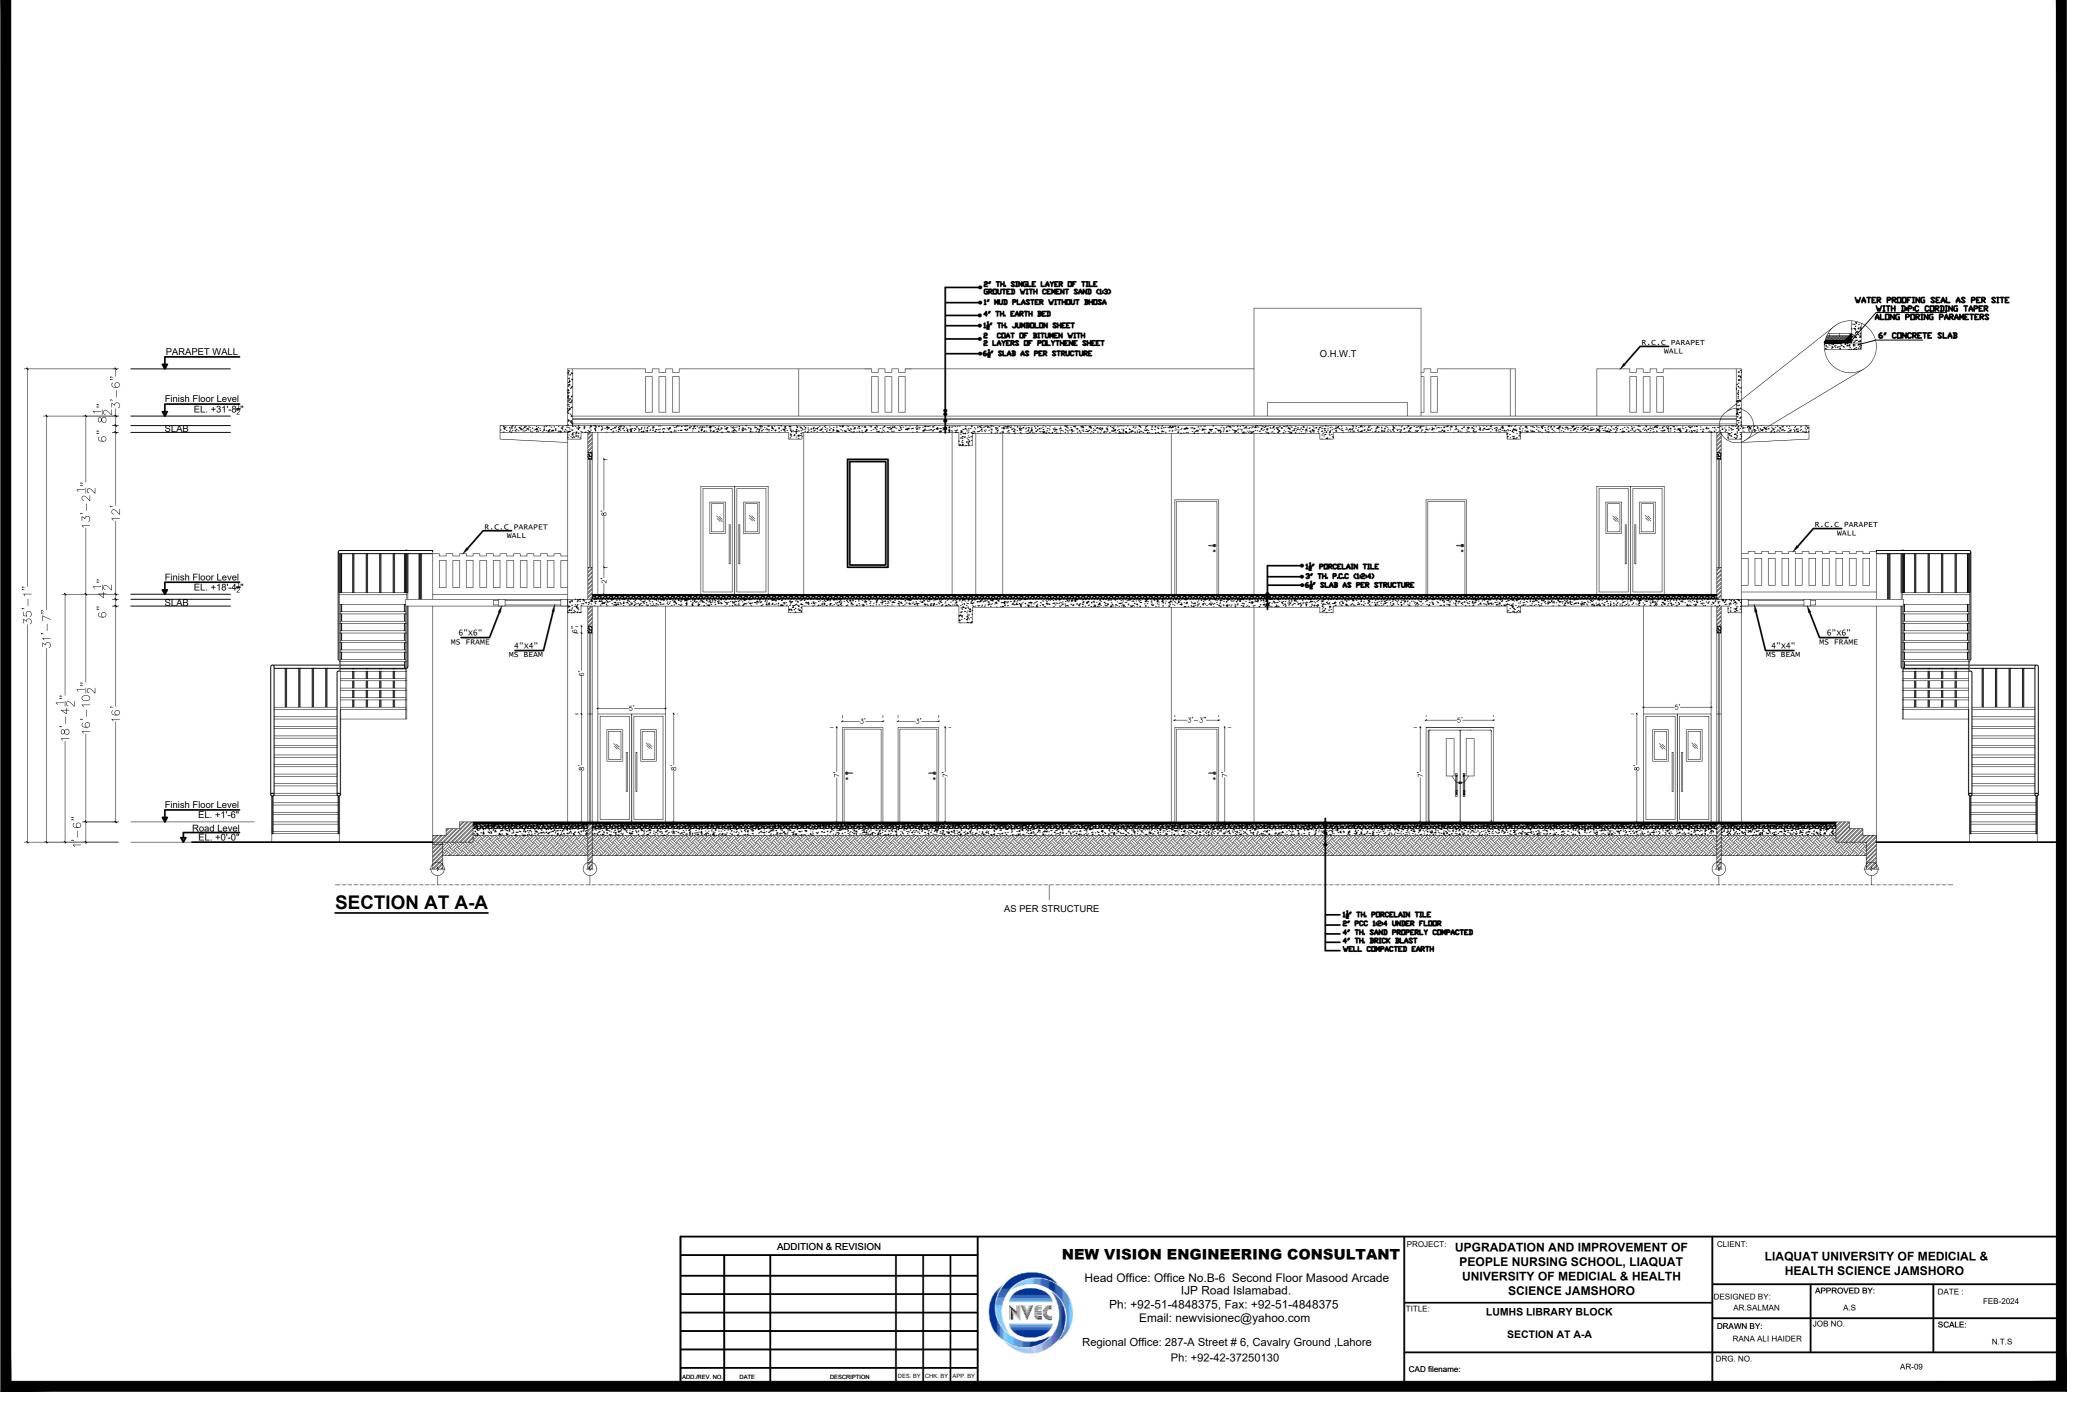


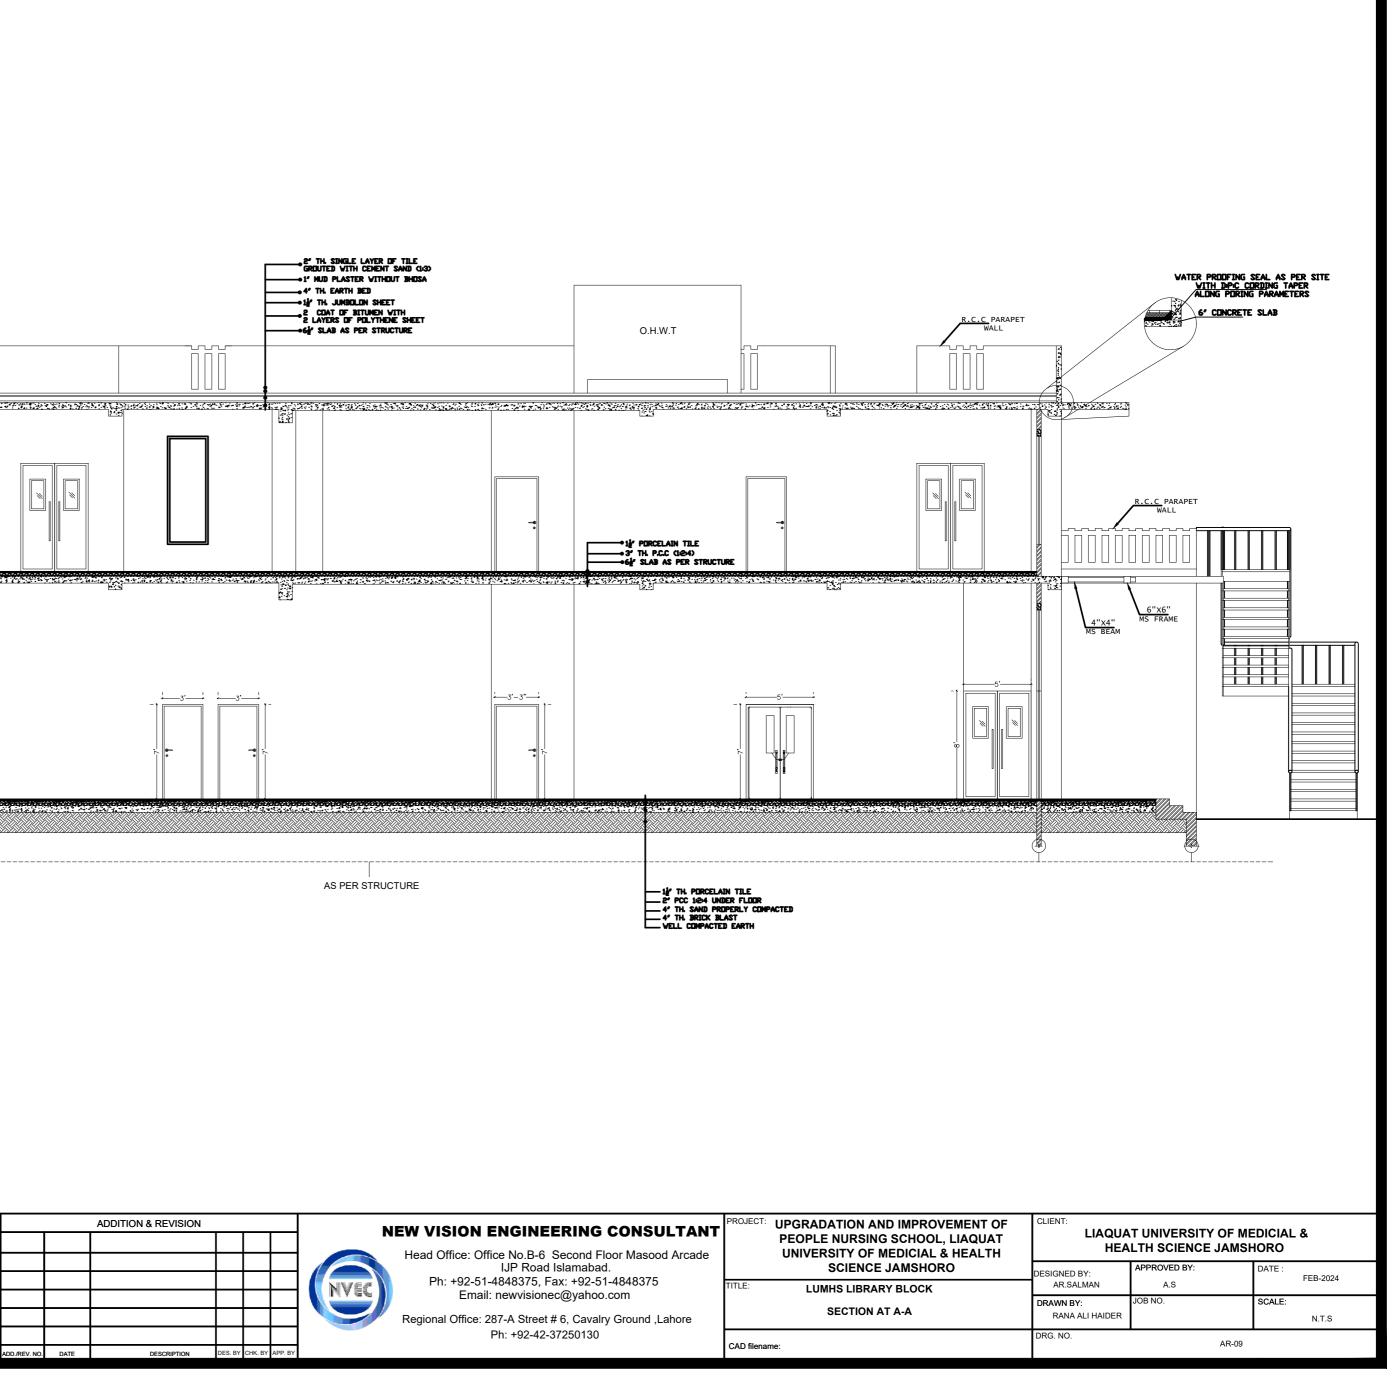


	SCH	HEDULE	of opei	NINGS			
		DOOR S	CHEDULE				
S.NO.	OPENINGS	DIMENSIONS	SILL LEVEL	DESCRIPTION			
1	D1	5'-0"x8'-0"	0'-0"	SOLID DOOR			
2	D2	5'-0"X8'-0"	0'-0"	FIRE RATED EMGERGENCY EXIT DOOR			
3	D3	5'-0"X7'-0"	0'-0"	SOLID FLUSH DOOR			
4	D4	5'-0"X7'-0"	0'-0"	ALUMINUM GLASS DOOR			
5	D5	3'-3"X7'-0"	0'-0"	UPVC			
6	D6	3'-0"X7'-0"	0'-0"	SOLID DOOR			
7	D7	3'-0"X7'-0"	0'-0"	SOLID FLUSH DOOR			
8	D8	3'-0"X8'-0"	0'-0"	ALUMINUM GLASS DOOR			
9	D9	3'-0"X8'-0"	0'-0"	SOLID FLUSH DOOR			
10	D10	3'-0"X7'-0"	0'-0"	UPVC			
11	D11	2'-6"X7'-0"	0'-0"	UPVC			
		WINDOW SO	CHEDULE				
12	W1	3'-0"X12'-0"	+2'-0"	ALUMINUM WINDOW			
13	W2	10'-0"X10'-0"	+0'-6"	ALUMINUM WINDOW			
14	W3	3'-0"X8'-0"	+2'-0"	ALUMINUM WINDOW			
15	V1	2'-0"X8'-0"	+6'-0"	ALUMINUM WINDOW			
16	V2	2'-0"X6'-0"	+4'-0"	ALUMINUM WINDOW			

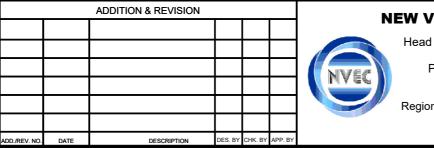



A VISION ENGINEERING CONSULTANT ead Office: Office No.B-6 Second Floor Masood Arcade	PROJECT: UPGRADATION AND IMPROVEMENT OF PEOPLE NURSING SCHOOL, LIAQUAT UNIVERSITY OF MEDICIAL & HEALTH	CLIENT: LIAQUAT UNIVERSITY OF MEDICIAL & HEALTH SCIENCE JAMSHORO		
IJP Road Islamabad.		DESIGNED BY:		DATE : FEB-2024
Ph: +92-51-4848375, Fax: +92-51-4848375 Email: newvisionec@yahoo.com	TITLE: LUMHS LIBRARY BLOCK	AR.SALMAN	A.S	
gional Office: 287-A Street # 6, Cavalry Ground ,Lahore	SCHEDULE OF OPENING	DRAWN BY: RANA ALI HAIDER	JOB NO.	SCALE: N.T.S
Ph: +92-42-37250130	CAD filename:	DRG. NO.	AR-10	

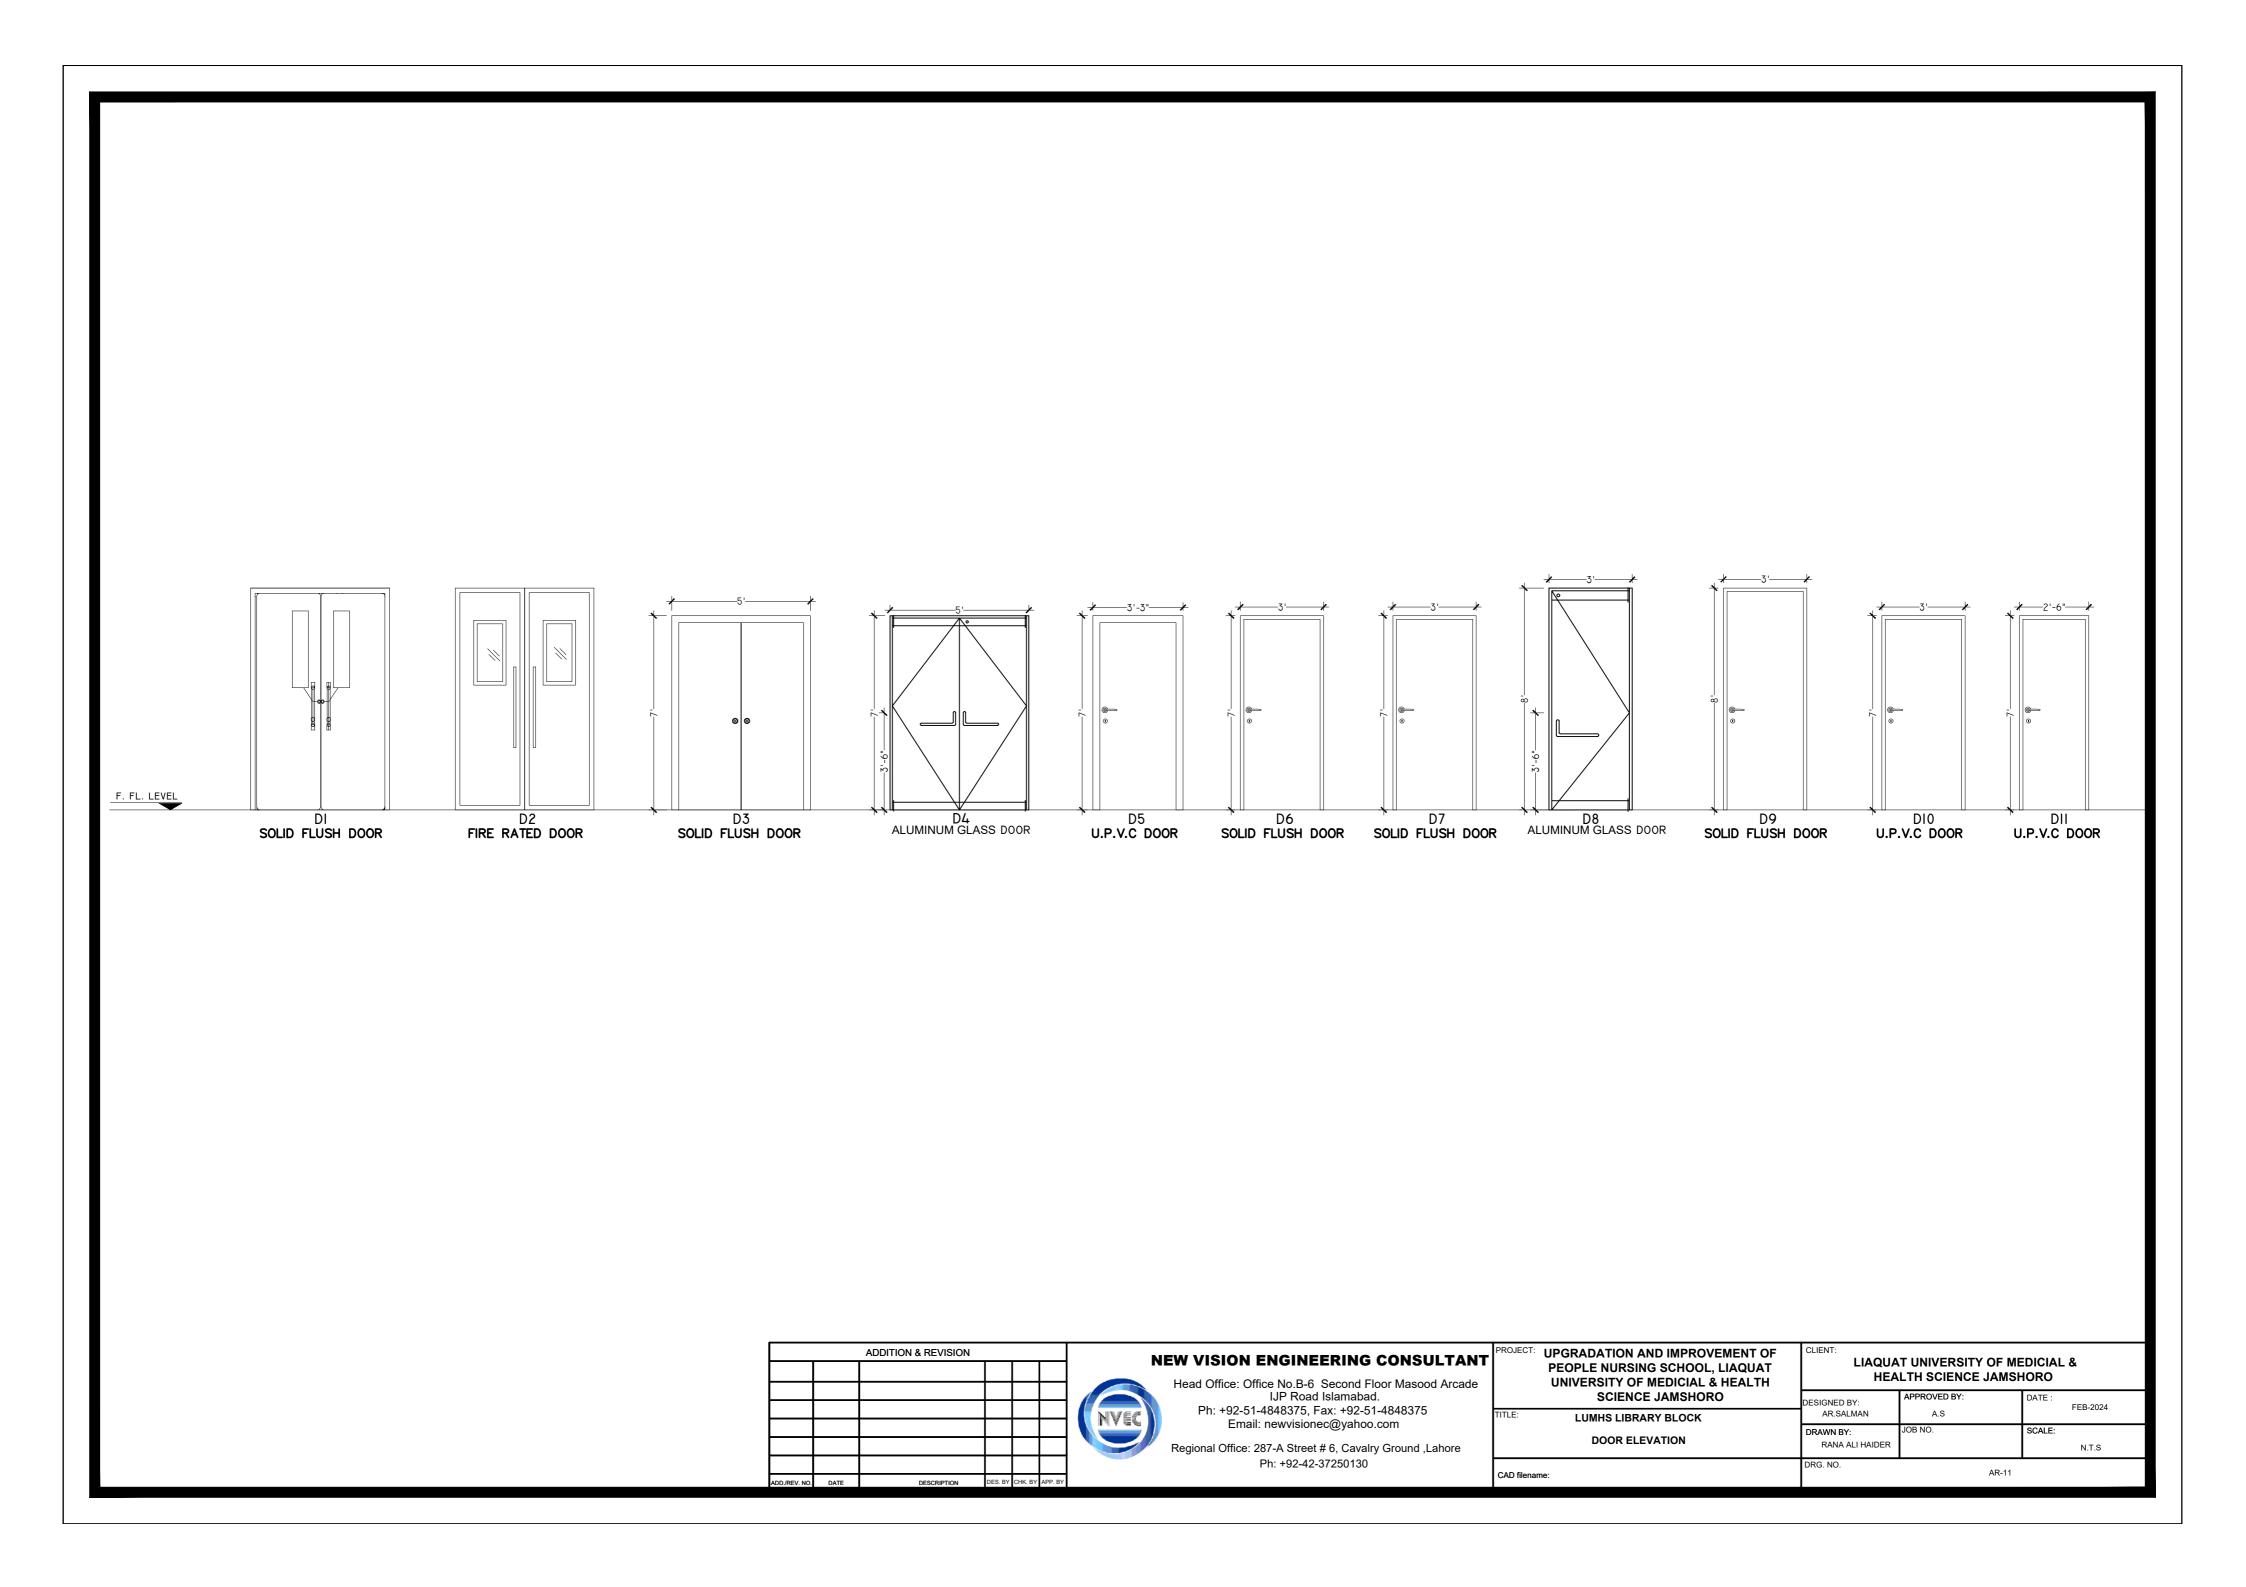


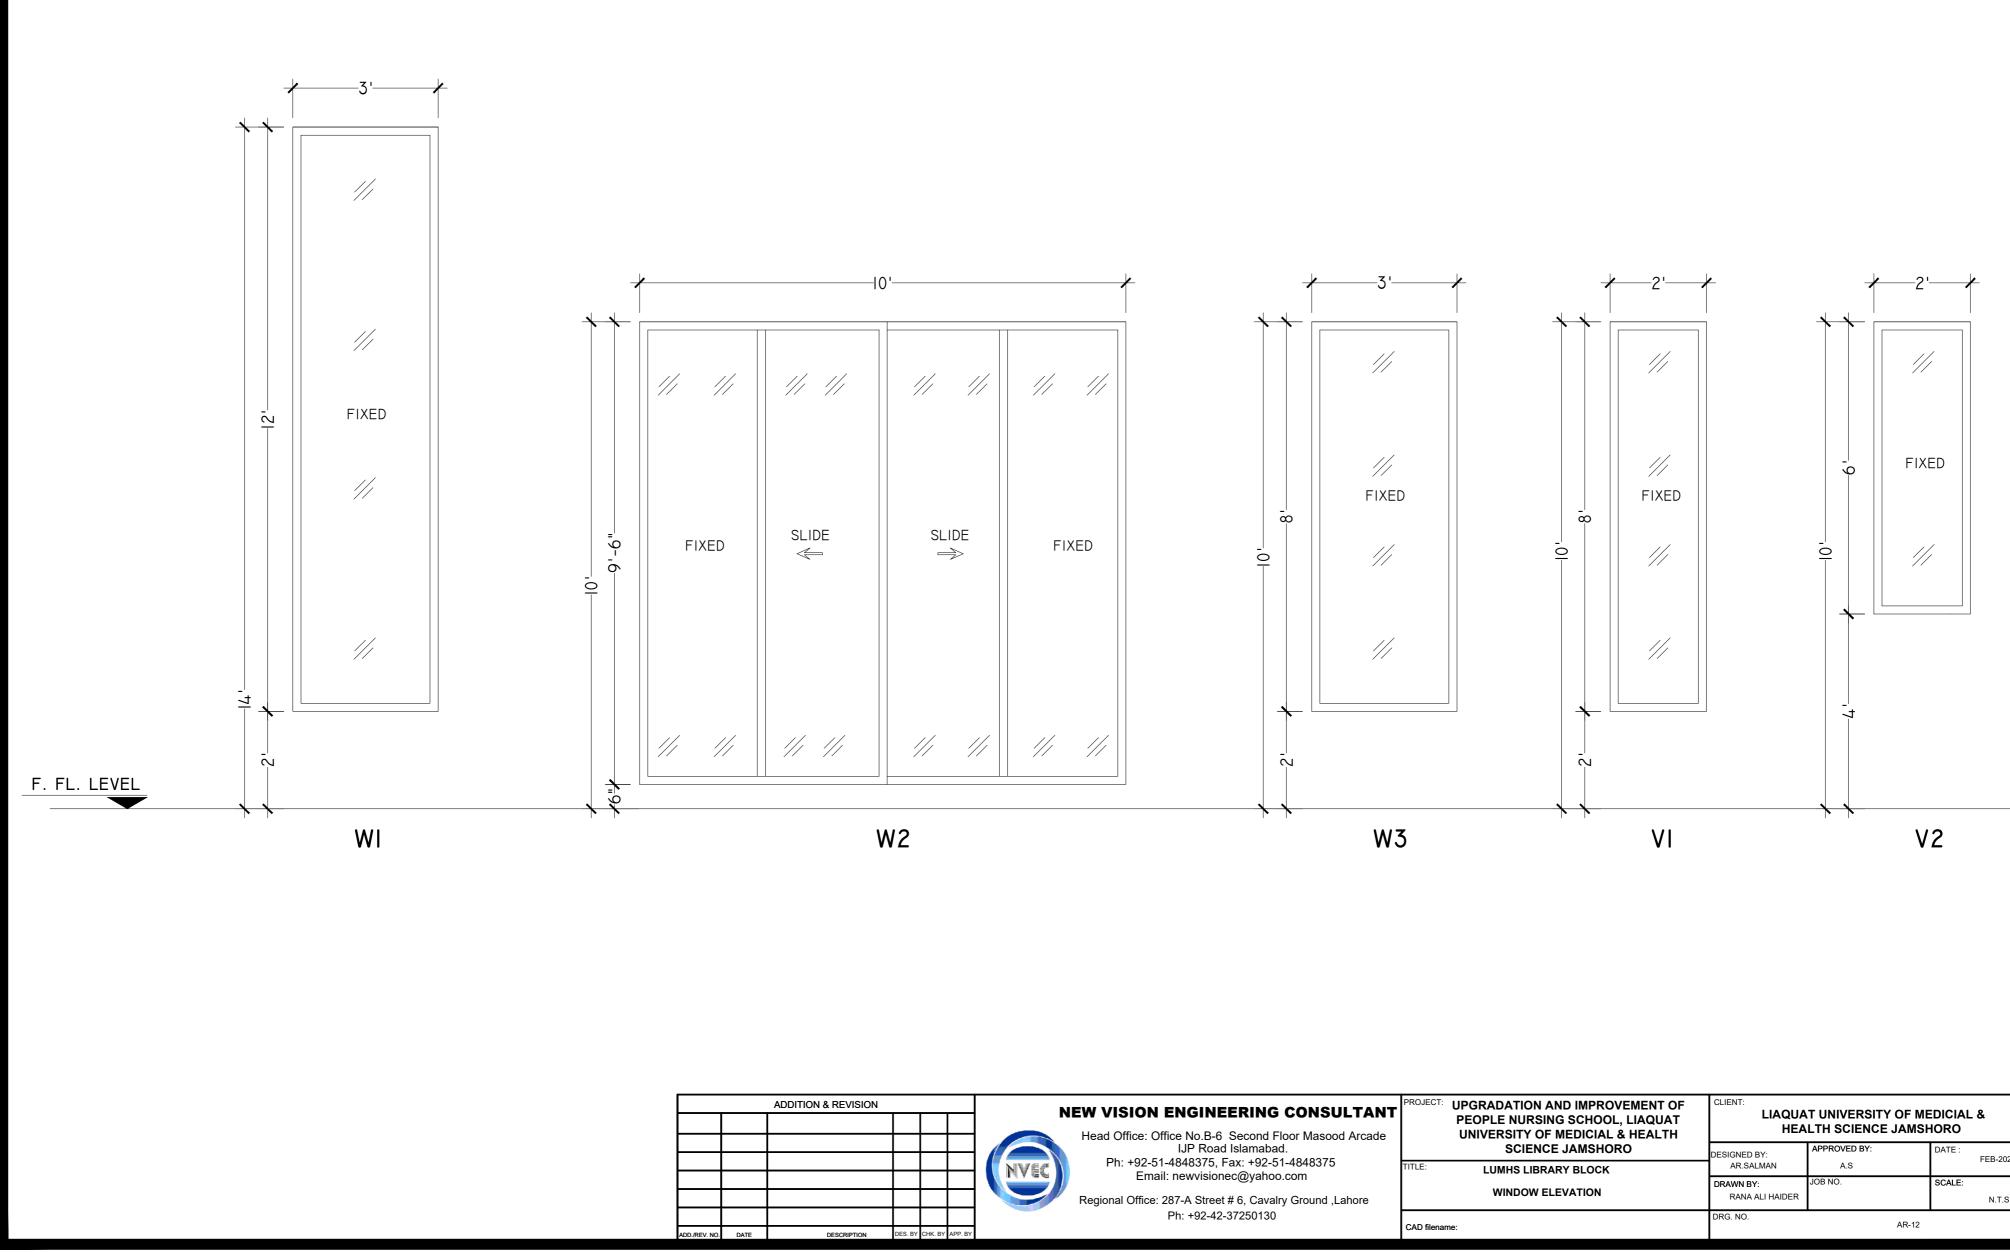

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IJP Road Islamabad. Ph: +92-51-4848375, Fax: +92-51-4848375		DESIGNED BY:		DATE : FEB-2024	
Email: newvisionec@yahoo.com	TITLE: LUMHS LIBRARY BLOCK	AR.SALMAN	A.S		
gional Office: 287-A Street # 6, Cavalry Ground ,Lahore		DRAWN BY: RANA ALI HAIDER	JOB NO.	SCALE: N.T.S	
Ph: +92-42-37250130	CAD filename:	DRG. NO. AR-12			

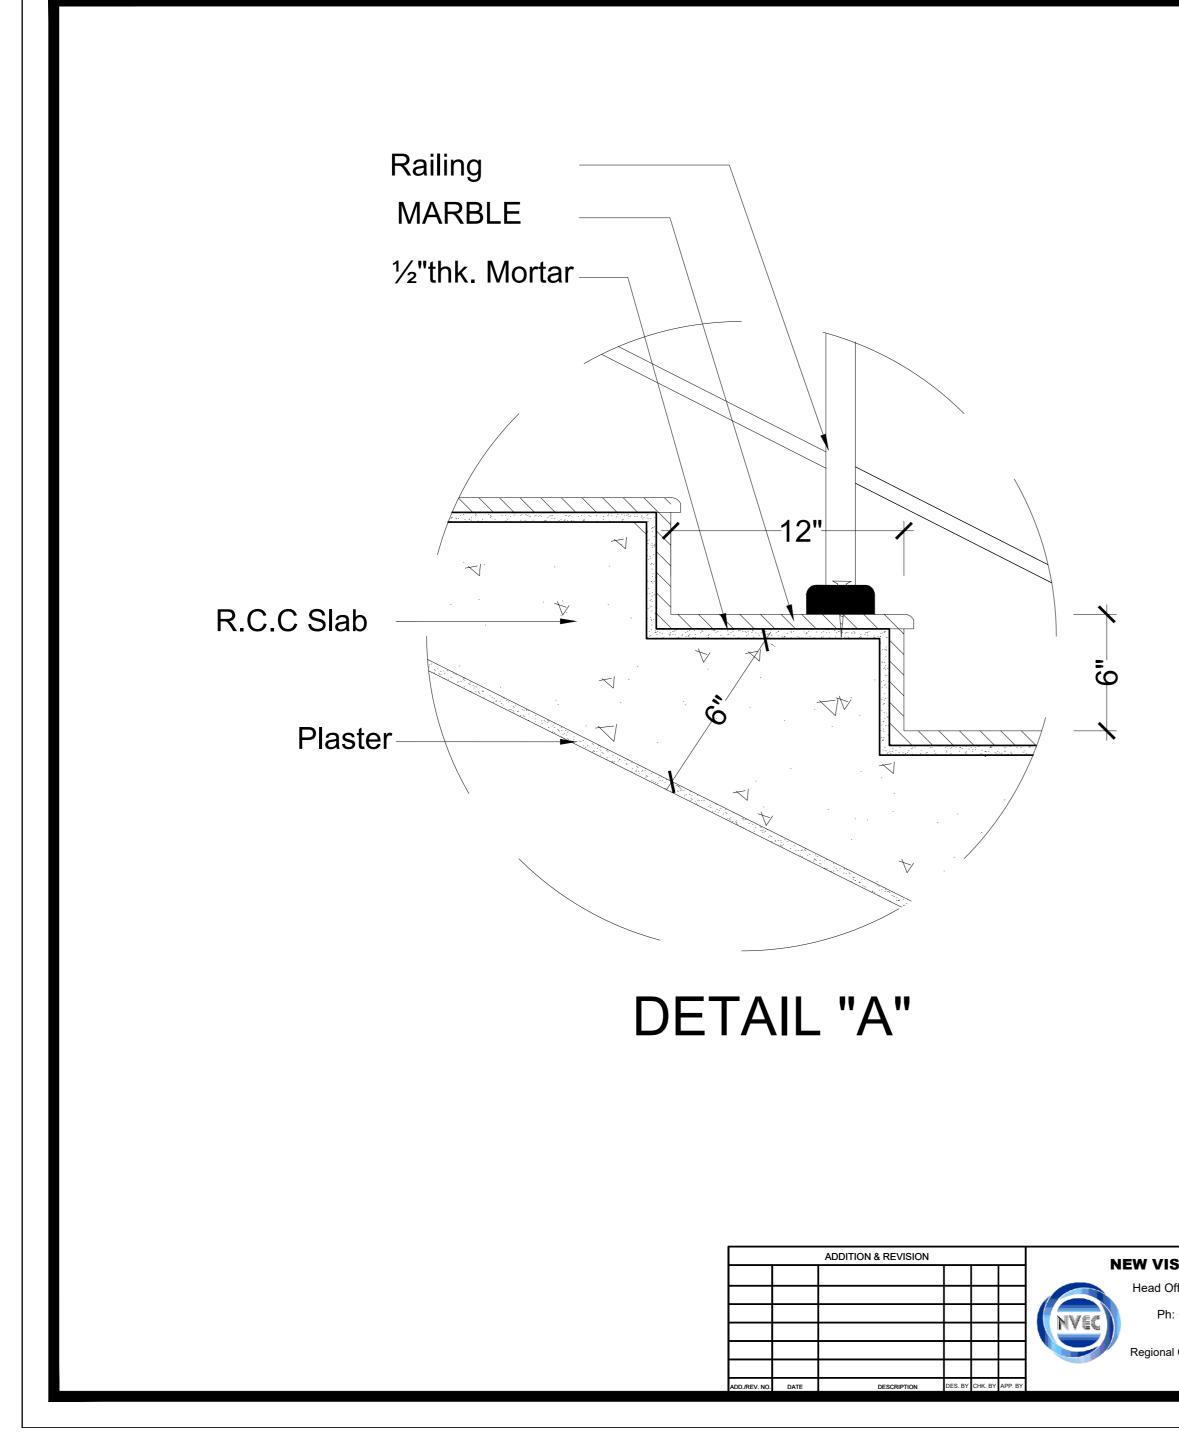


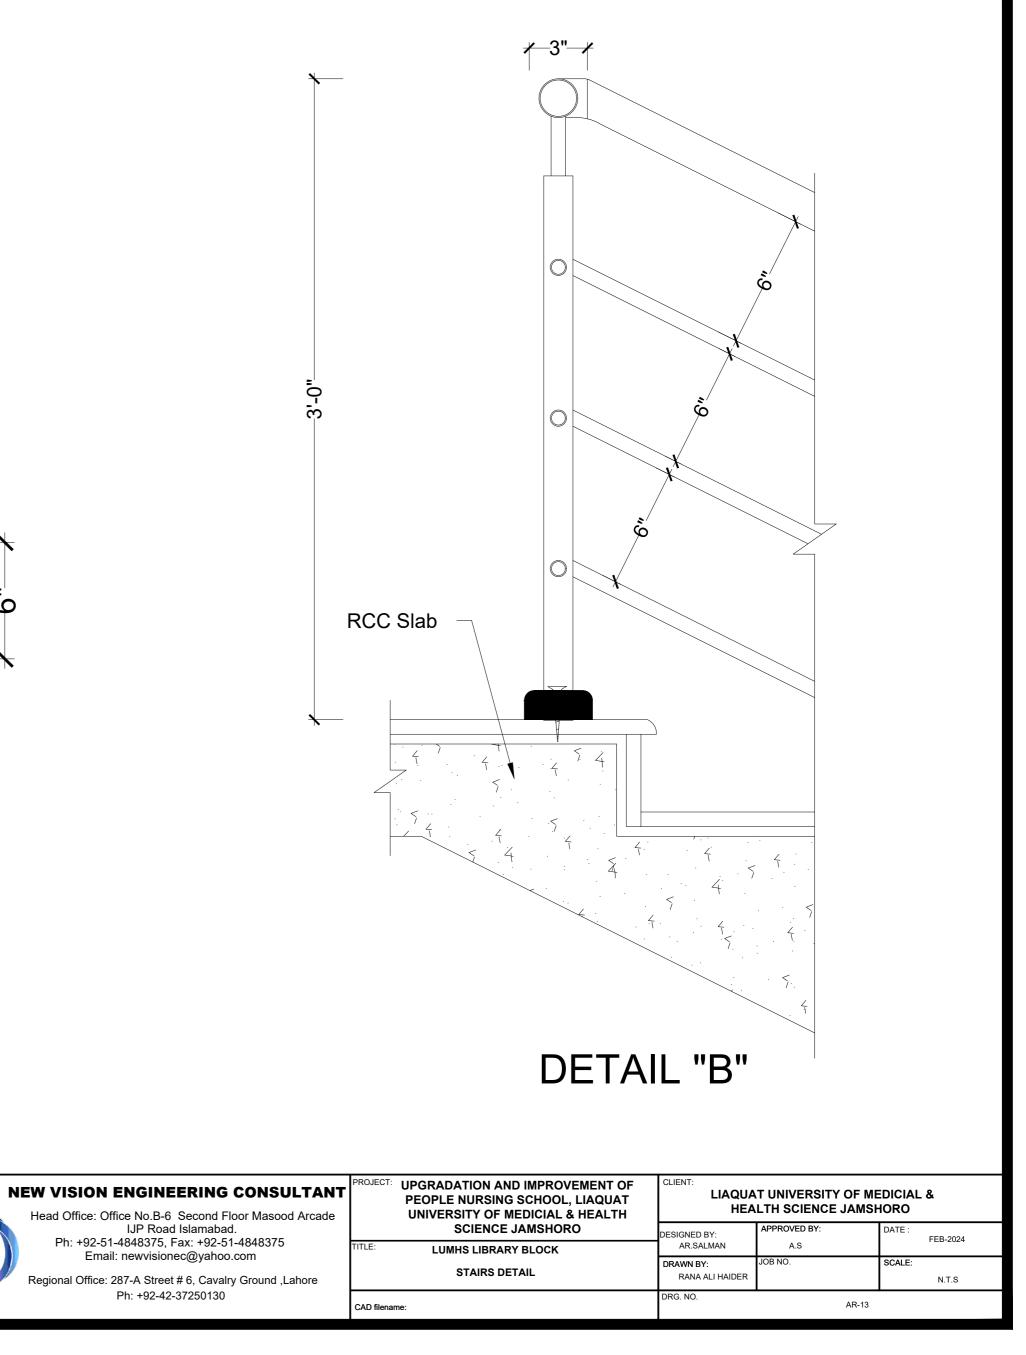


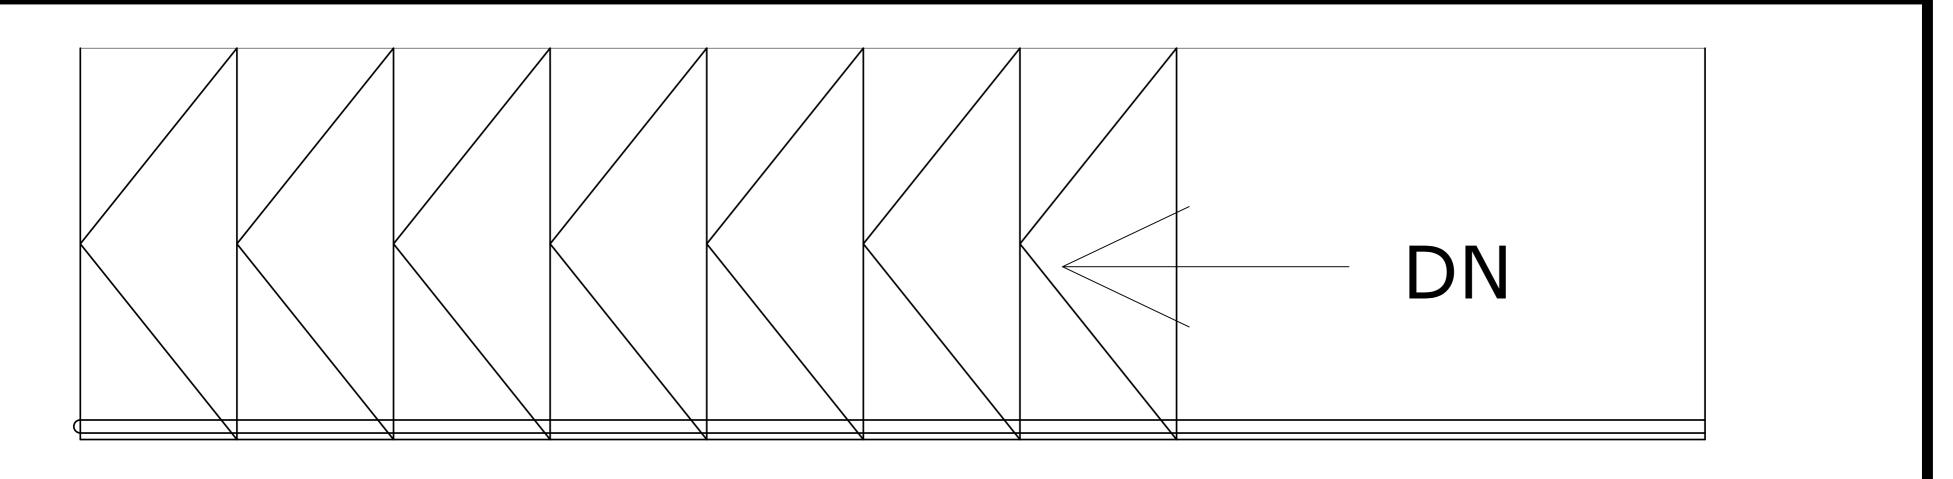

DISABLE RAMP (1:12)

DISABLE RAMP SECTION

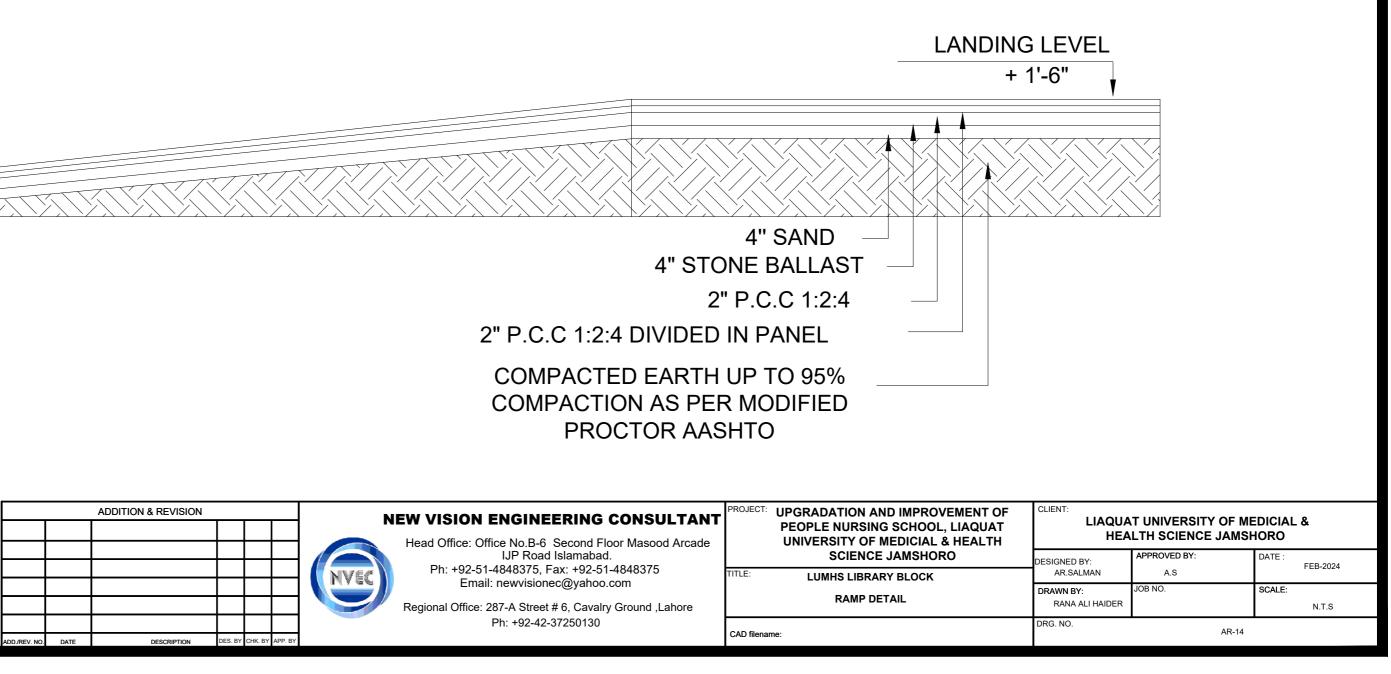

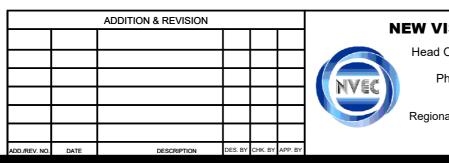


PLINTH PROTECTION


COMPACTED EARTH UP TO 95% COMPACTION AS PER MODIFIED PROCTOR AASHTO

2" THICK P.C.C 1:2:4 — 4" THICK BRICK BALLAST — 4" THICK SAND —

2" THICK P.C.C 1:2:4 IN PANELS

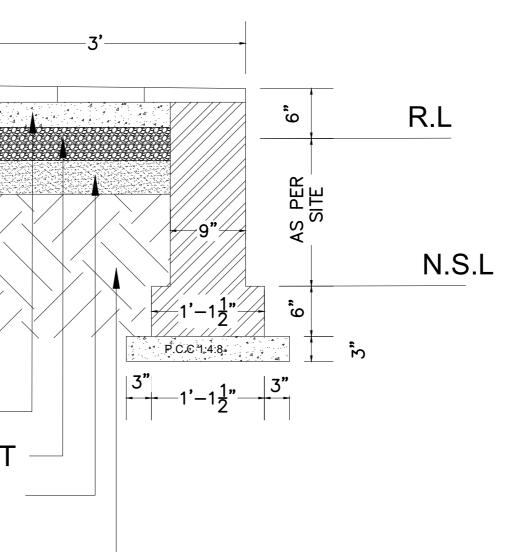


VISION ENGINEERING CONSULTANT ead Office: Office No.B-6 Second Floor Masood Arcade	PEOPLE NURSING SCHOOL, LIAQUAT UNIVERSITY OF MEDICIAL & HEALTH		CLIENT: LIAQUAT UNIVERSITY OF MEDICIAL & HEALTH SCIENCE JAMSHORO			
IJP Road Islamabad.	SCIEN			APPROVED BY:	DATE : FEB-2024	
Ph: +92-51-4848375, Fax: +92-51-4848375 Email: newvisionec@yahoo.com	TITLE: LUMHS LIB	RARY BLOCK	AR.SALMAN	A.S		
gional Office: 287-A Street # 6, Cavalry Ground ,Lahore	PLINTH PROTECTION DETAIL		DRAWN BY: RANA ALI HAIDER	JOB NO.	SCALE: N.T.S	
Ph: +92-42-37250130	CAD filename:		DRG. NO. AR-15			

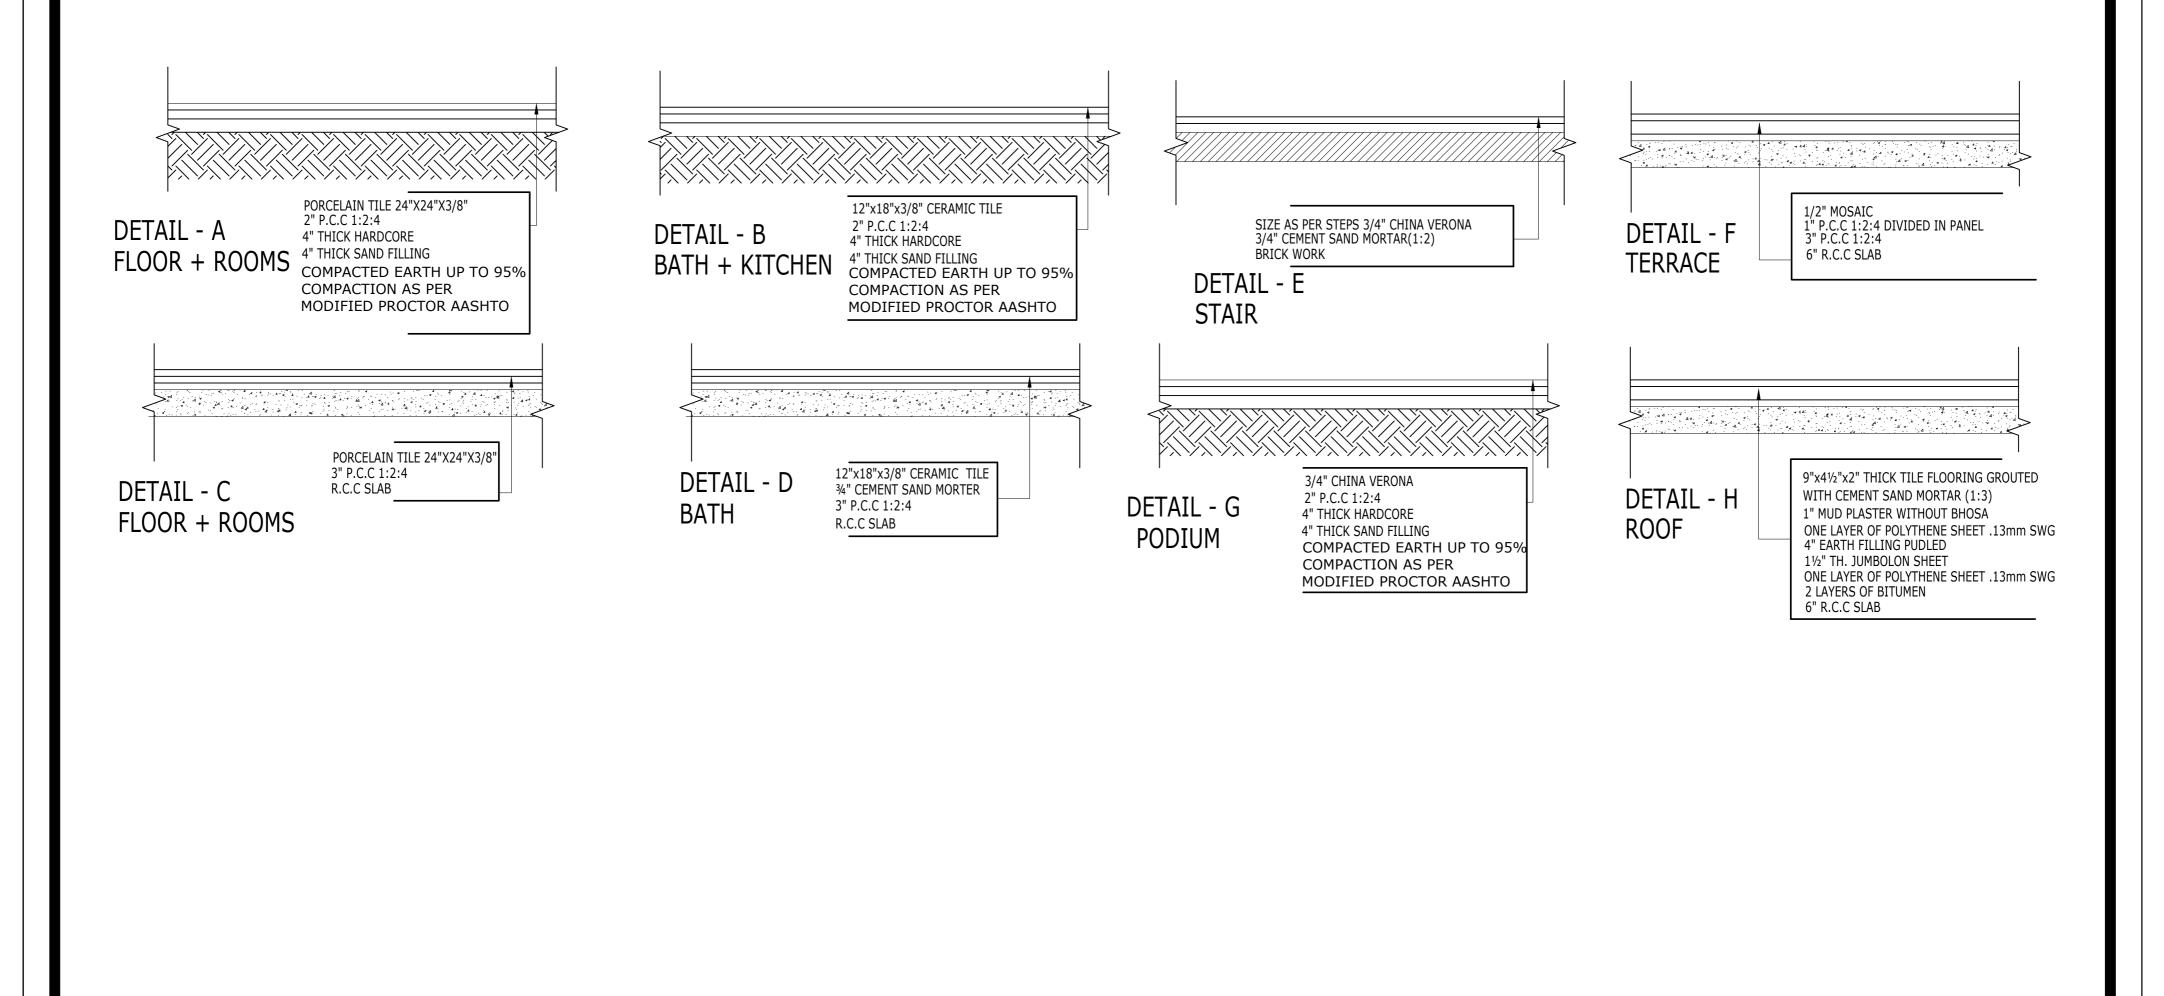


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ADD./REV. NO.	DATE	DESCRIPTION	DES. BY	CHK. BY	APP. BY		

/ISION ENGINEERING CONSULTANT	PROJECT: UPGRADATION AND IMPROVEMENT OF PEOPLE NURSING SCHOOL, LIAQUAT UNIVERSITY OF MEDICIAL & HEALTH	LIAQUAT UNIVERSITY OF MEDICIAL & HEALTH SCIENCE JAMSHORO				
IJP Road Islamabad.	SCIENCE JAMSHORO	DESIGNED BY:	APPROVED BY:	DATE : FEB-2024		
Ph: +92-51-4848375, Fax: +92-51-4848375 Email: newvisionec@yahoo.com	TITLE: LUMHS LIBRARY BLOCK	AR.SALMAN	A.S	1 20 2021		
Email: newvisionec@yanoo.com	FLOOR FINISH DETAIL	DRAWN BY:	JOB NO.	SCALE:		
onal Office: 287-A Street # 6, Cavalry Ground ,Lahore	FLOOR FINISH DETAIL	RANA ALI HAIDER		N.T.S		
Ph: +92-42-37250130	CAD filename:	DRG. NO. AR-16				

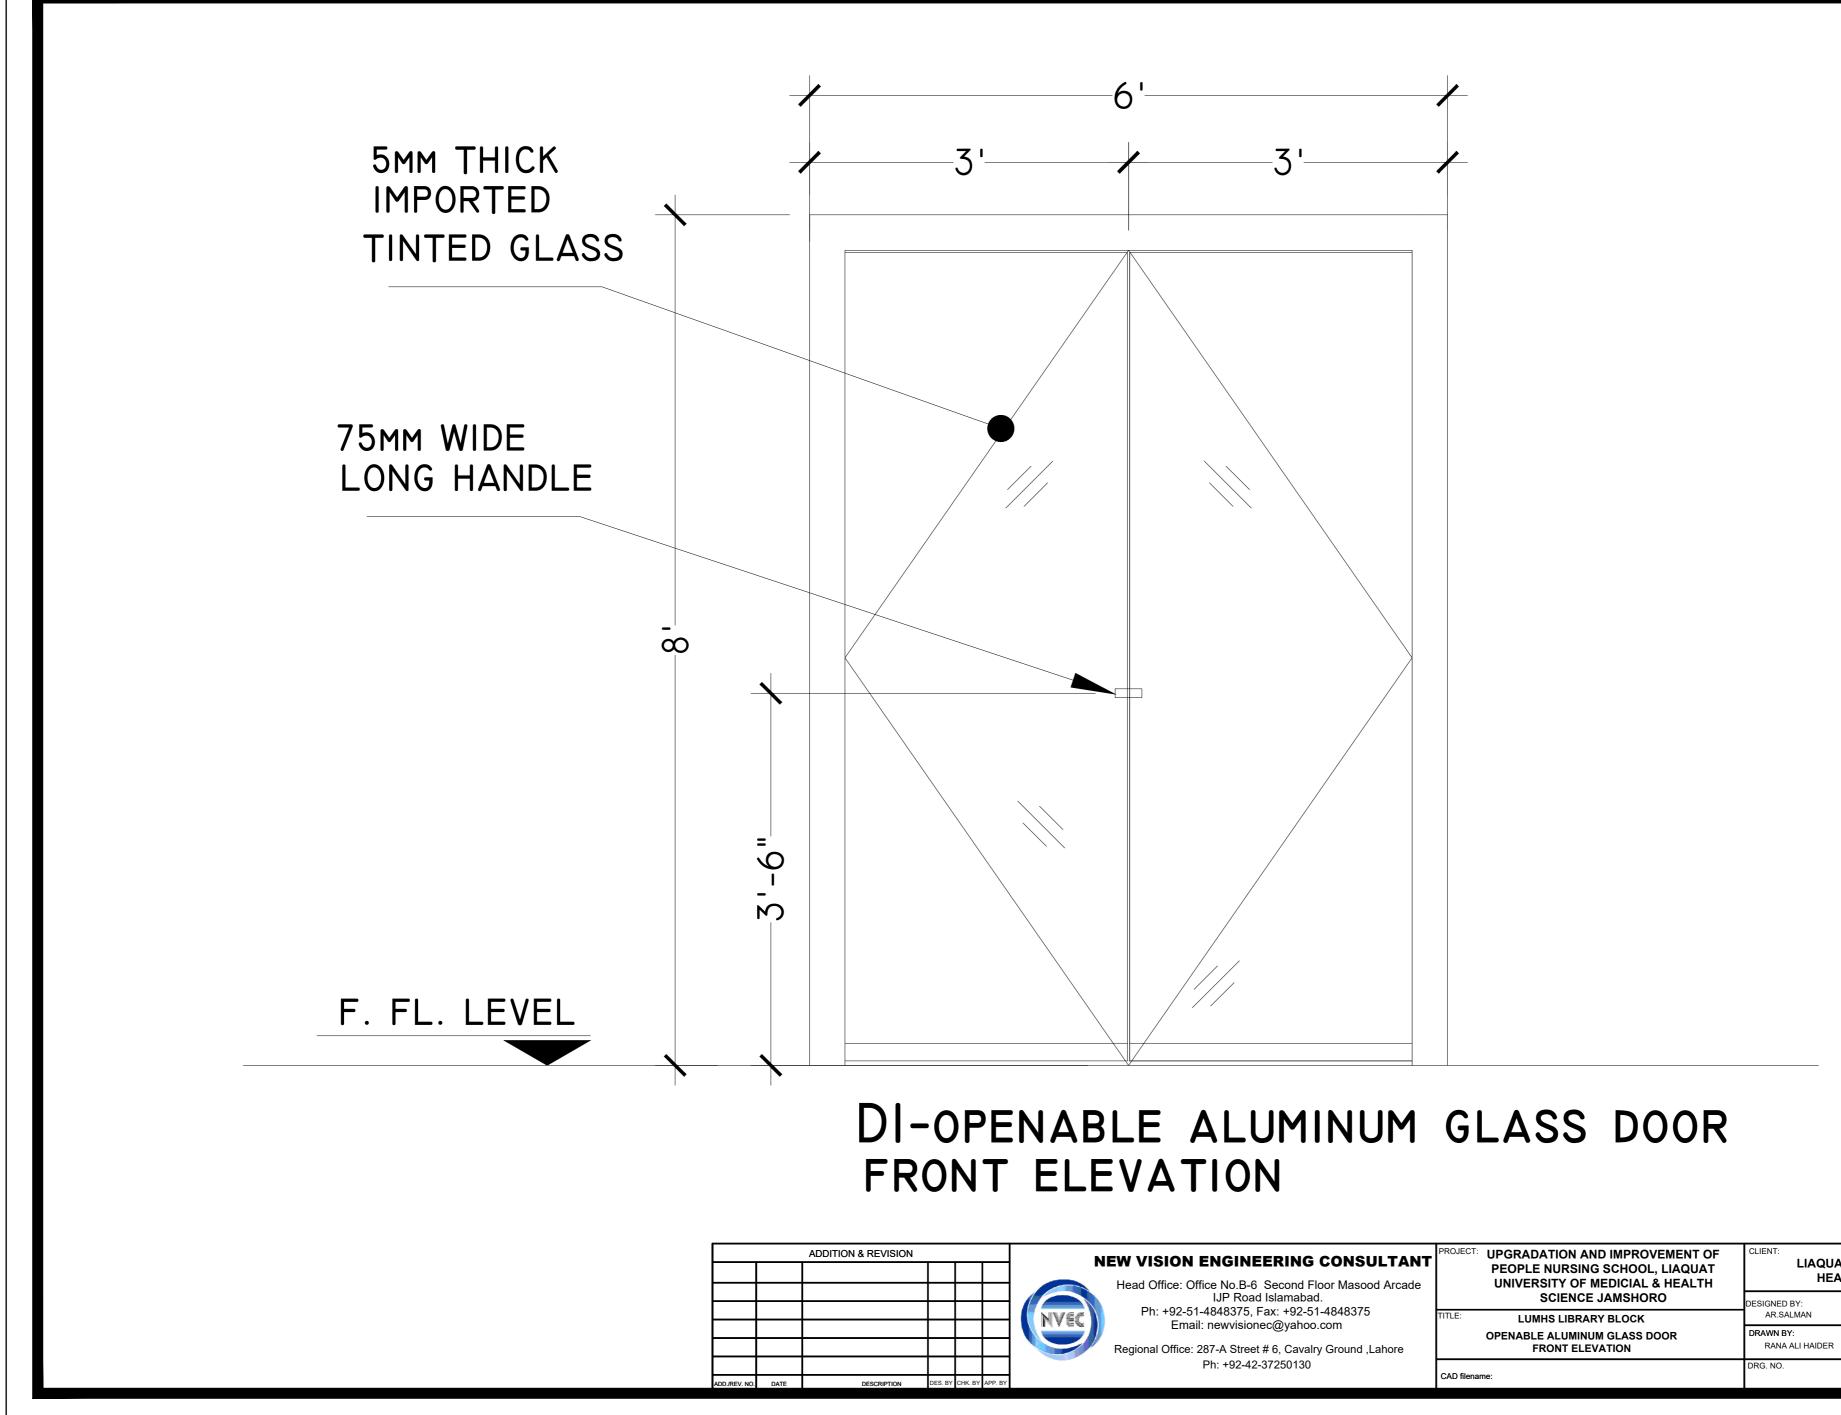

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IJP Road Islamabad. Ph: +92-51-4848375, Fax: +92-51-4848375		DESIGNED BY:		DATE : FEB-2024		
Email: newvisionec@yahoo.com	TITLE: LUMHS LIBRARY BLOCK	AR.SALMAN	A.S			
Email. newvisionec@yanoo.com	OPENABLE ALUMINUM GLASS DOOR	DRAWN BY:	JOB NO.	SCALE:		
onal Office: 287-A Street # 6, Cavalry Ground ,Lahore	FRONT ELEVATION	RANA ALI HAIDER		N.T.S		
Ph: +92-42-37250130	CAD filename:	DRG. NO. AR-17				

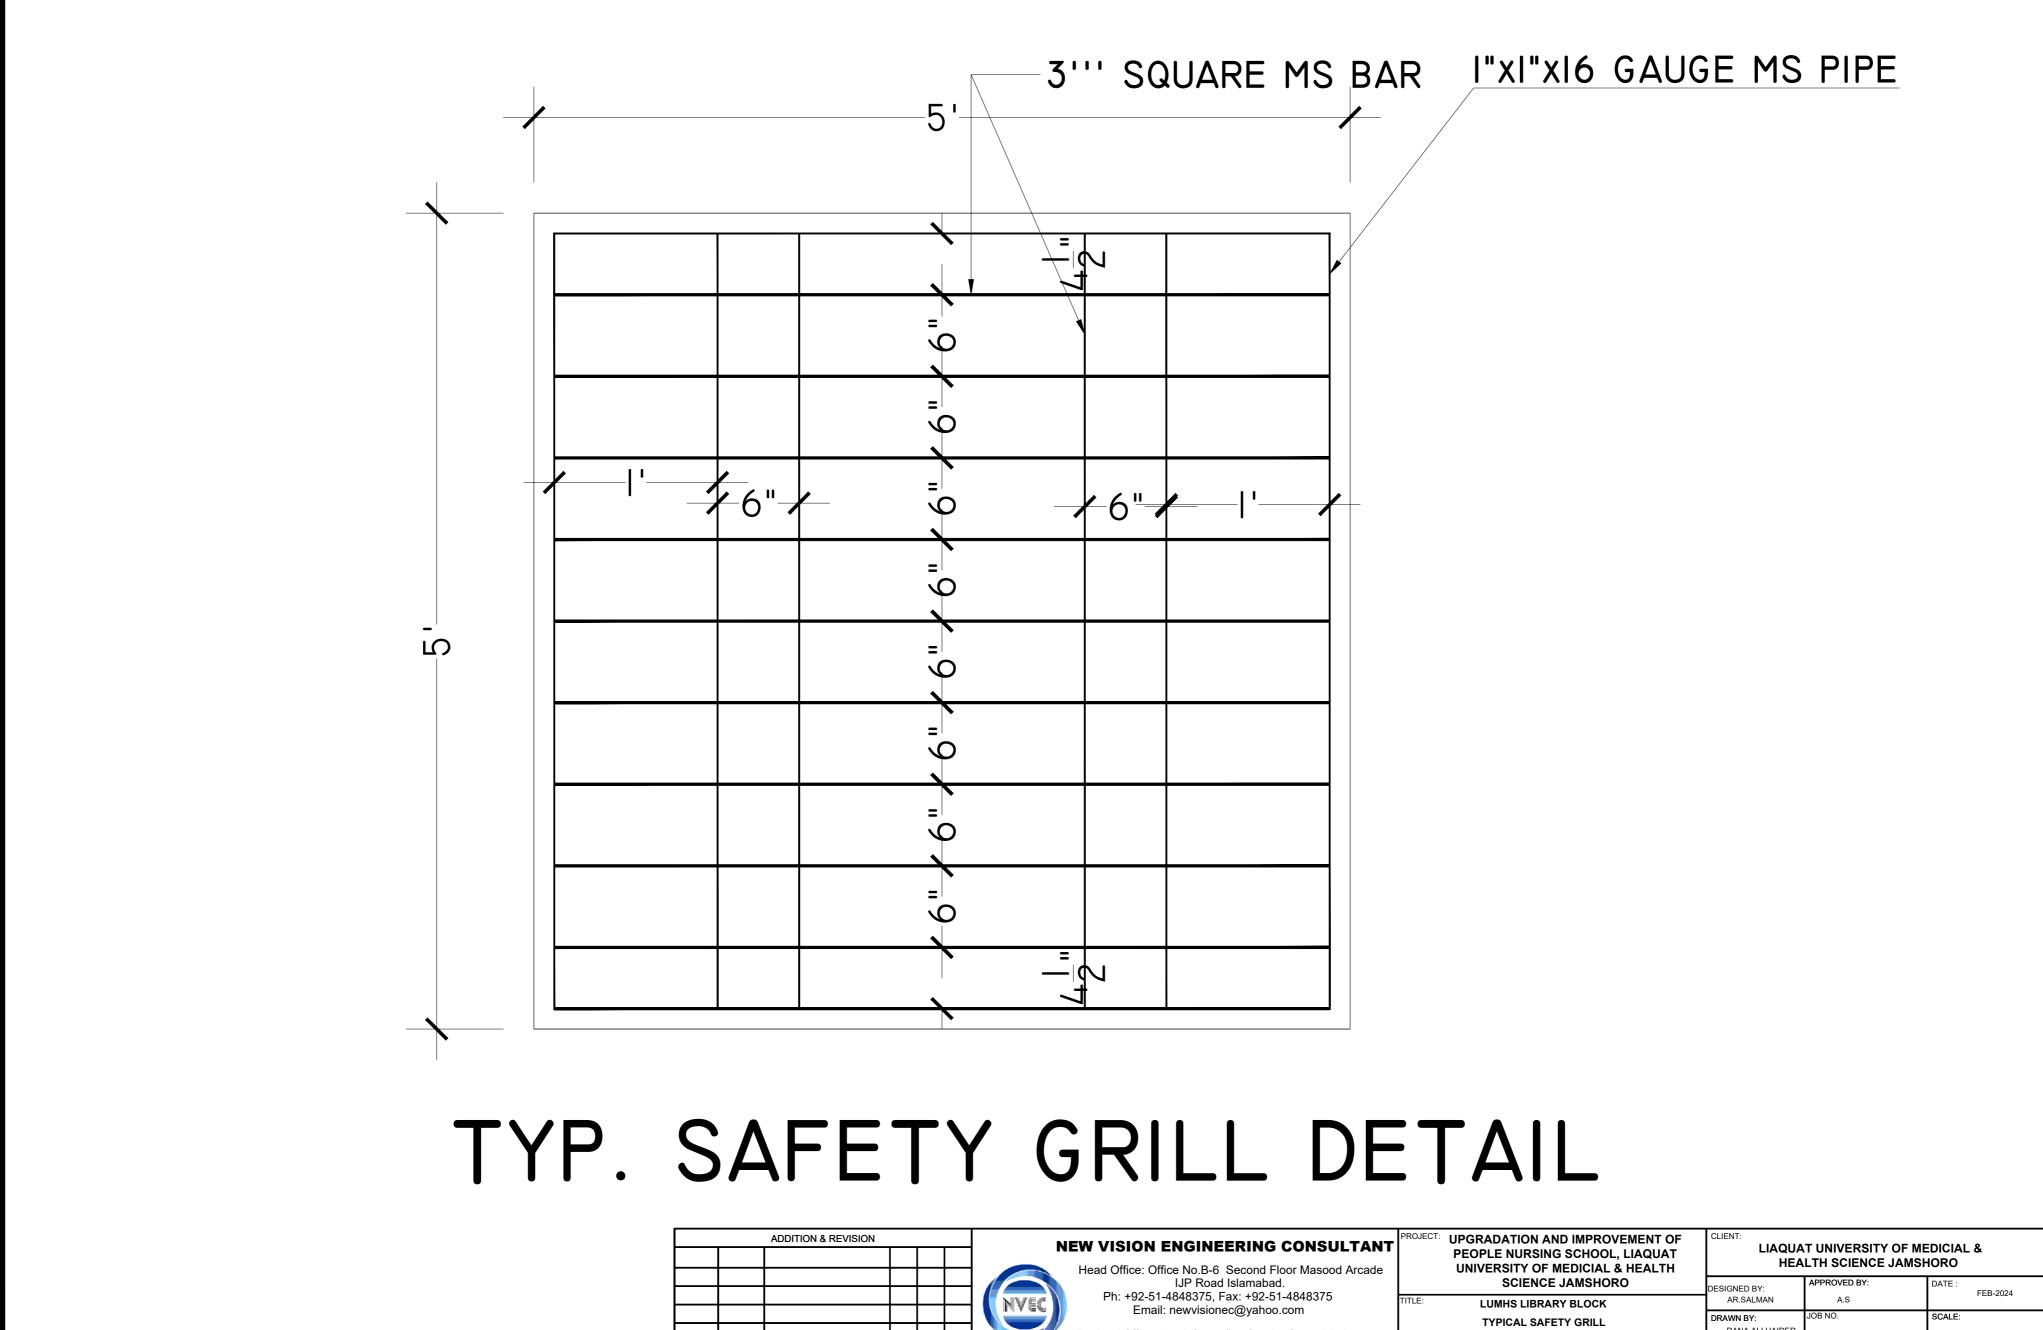

REV NO

DATE

DESCRIPTION

DES. BY CHK. BY APP.

d Office: Office No.B-6 Second Floor Masood Arcade	PROJECT:	UPGRADATION AND IMPROVEMENT OF PEOPLE NURSING SCHOOL, LIAQUAT UNIVERSITY OF MEDICIAL & HEALTH	CLIENT: LIAQUAT UNIVERSITY OF MEDICIAL & HEALTH SCIENCE JAMSHORO				
IJP Road Islamabad. Ph: +92-51-4848375, Fax: +92-51-4848375		SCIENCE JAMSHORO	DESIGNED BY:	APPROVED BY:	DATE : FEB-2024		
Email: newvisionec@yahoo.com	TITLE:	LUMHS LIBRARY BLOCK	AR.SALMAN	A.S			
nal Office: 287-A Street # 6, Cavalry Ground ,Lahore		TYPICAL SAFETY GRILL DETAIL	DRAWN BY: RANA ALI HAIDER	JOB NO.	SCALE: N.T.S		
Ph: +92-42-37250130	CAD filename:		DRG. NO. AR-18				

STRUCTURE

	LIST OF DRAWINGS			
S.NO.	DRAWING TITLE	DRG. NO		
	STRUCTURE DRAWINGS			
1	LIST OF DRAWINGS	ST-01		
2	GENERAL NOTES	ST-02		
3	TYPICAL DETAILS	ST-03		
4	TYPICAL DETAILS	ST-04		
5	TYPICAL DETAILS	ST-05		
6	FOUNDATION LAYOUT PLAN	ST-06		
7	FOUNDATION SCHEDULE	ST-07		
8	FOUNDATION SECTION DETAIL	ST-08		
9	FOUNDATION SECTION DETAIL	ST-09		
10	BRICK FOOTING FOUNDATION LAYOUT	ST-10		
11	BRICK FOOTING SECTION	ST-11		
12	GROUND FLOOR COLUMN LAYOUT PLAN	ST-12		
13	COLUMN SECTION	ST-13		
14	PLINTH BEAM LAYOUT PLAN	ST-14		
15	PLINTH BEAM SECTION	ST-15		
16	GROUND FLOOR BEAM LAYOUT PLAN	ST-16		
	GROUND FLOOR BEAM SECTION	ST-10		
17				
18	FIRST FLOOR BEAM LAYOUT PLAN	ST-18		
19	FIRST FLOOR BEAM SECTION	ST-19		
20	ROOF FLOOR LAYOUT PLAN	ST-20		
21	GROUND FLOOR SLAB LAYOUT POSITIVE REINF. PLAN	ST-21		
22	GROUND FLOOR SLAB LAYOUT NEGATIVE REINF. PLAN	ST-22		
23	FIRST FLOOR SLAB LAYOUT POSITIVE REINF. PLAN	ST-23		
24	FIRST FLOOR SLAB LAYOUT NEGATIVE REINF. PLAN	ST-24		
25	STAIR DETAIL	ST-25		
26	O.H.W.T DETAIL	ST-26		
27	SEPTIC TANK	ST-27		
28	EMERGENCY STEEL STAIR PLAN & DETAIL	ST-28		
29	EMERGENCY STEEL STAIR SECTION DETAIL	ST-29		
30	EMERGENCY STEEL STAIR MISC DETAIL	ST-30		
31	EMERGENCY STAIR RAILING DETAIL	ST-31		
	NEW VISION ENGINEERING CO Head Office: Office No.B-6 SECOND FL IJP Road Islamabad	OOR Masood Arcade	PROJECT: UPGRADATION AND IMPROVEMENT OF PEOPLE NURSING SCHOOL, LIAQUAT UNIVERSITY OF MEDICIAL & HEALTH SCIENCE JAMSHORO	CLIENT: LIAQU, HE, DESIGNED BY:
	Ph: +92-51-4848375, Fax: +92 Email: newvisionec@yah	oo.com		ENG.ZAIN ARSHAD DRAWN BY:
	Regional Office: 287-A Street # 6, Cav Ph: +92-42-3725013		LIST OF DRAWING	MATHEW SIMON

ADDITION & REVISION ADD./REV. NO. DATE DESCRIPTION

NOTE:

THE STRUCTURE IS DESIGNED AS COMPOSITE IN NATURE I.E., 9" AND 13.5" WALLS ARE LOAD BEARING.THE CONSTRUCTION SHOULD BE CARRIED OUT PARALLEL FOR FRAME AND WALLS SO LOAD SHOULD BE DISTRIBUTED ON WALLS.

GENERAL TECHNICAL NOTES

- Figured dimensions are to be followed. 1.
- 2. Class "A" kiln burnt brick with minimum crushing strength of 2000 PSI should be used & joint at end should be sloppy, Vertical toothed joint at corners are prohibited.
- 3. A steel G-60 deformed steel should be used in beams footing slabs and water retaining structures, in columns, for all diameters.
- All steel should be checked for its quality and placement 4. DETAIL as shown in drawings.
- Extra care is required for proper placement of top 5. reinforcement at support sections and cantilevers.
- 6. Dotted bars designate top reinforcement.
- Provide L- shaped end hooks for all bars at discontinuous 7. ends in footings, walls, beams and slabs as shown in drawings.
- Lap length should be followed As except specified:-8.
 - (a) 1" Ø = 60" (b) 3/4" Ø = 45" (c) 5/8" Ø = 36" (d) 1/2" Ø = 30"
 - (e) 3/8" Ø = 23"
- Provide 3/8" dia at 12" c/c as distribution steel if not 09. shown in drawings.
- Minimum concrete cover. 10.

a) Footing = 2"	e) Water tank and retaining wall
b) Slabs = 3/4"	i- Water/earth face or
c) Beams = $1\frac{1}{2}$ "	exposed to weather = 2"
d) Columns = $1\frac{1}{2}$ "	ii- Other faces = 1"

- 11. All footing should be taken below the original Ground Level to achieve the minimum depth as shown in drawings. Footing should not be placed on uncompacted fill area.
- All drawings should be read in conjunction with 12. Architectural Drawings.
- Contractor will co-ordinate all drawings such as architectural, 13. structural, electrical, mechanical, water supply, drainage etc. before execution of work.
- Standard ACI 318, Astm C 33 and Astm A-615 use for 14. structural concrete
- 15. Fine modulus of fine aggregate varies from 2-3.5mm For concrete use 2.9- 3.2mm For plaster use 2.2-3.6mm QUALITY OF CONCRETE
- FOOTINGS & RETAINING WALLS. Minimum concrete compressive strength for 6"x12" cylinder to be 3000 psi at 28 days age. Concrete Nominal Mix 1:2:4 or more rich to provide specified strength (Equivalent 6"x6"x6" cube strength 3750 psi)

COLUMNS. 2.


> Minimum concrete compressive strength for 6"x12" cylinder to be 4000 psi at 28 days age. Concrete Nominal Mix to be 1:11/2:3 or more rich to provide specified strength

Admixture must be provided to ensure the specified structural strength as mentioned earlier. 3. BEAMS, RIBS & SLABS.


- Minimum concrete compressive strength for 6"x12" cylinder to be 3000 psi at 28 days age.Concrete Nominal Mix to be 1:2:4 or more rich to provide specified strength (Equivalent 6"x6"x6" cube strength 3750 psi) Admixture must be provided to ensure the specified structural strength as mentioned earlier.
- 4. Use of plasticizers recommended to reduce the water cement ratio and increase workability of concrete.
- 5. All concrete mixes to be used, should be got designed & approved before execution of work.
- 6. Quality, size and gradation of aggregates (fine & course) as used during the mix design, should be strictly adhered with.
- 7. The Design is in accordance with Seismic Zone 2A.

NOTES


- 1. ALL LAYOUT DIMENSIONS AND F.FLOOR LEVELS TO BE AS PER ARCH DRAWING.
- 2. PROVIDE PLINTH BEAM PB AT PLINTH LEVEL, WALL BEAMS AT SLAB LEVEL.
- 3. PROVIDE #2 DOUBLE-LEG TIE BARS AT 12" CENTRES AT COMMON JOINT BETWEEN WALLS AND COLUMNS. THESE BARS SHOULD PASS INTO WALLS ON EACH SIDE OF COLUMNS.

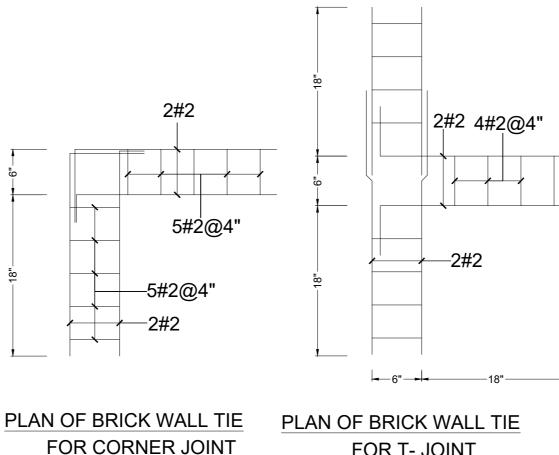

FOR T-JOINT

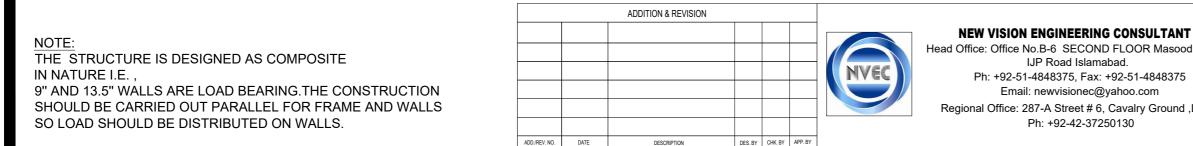

REINFORCING STEEL

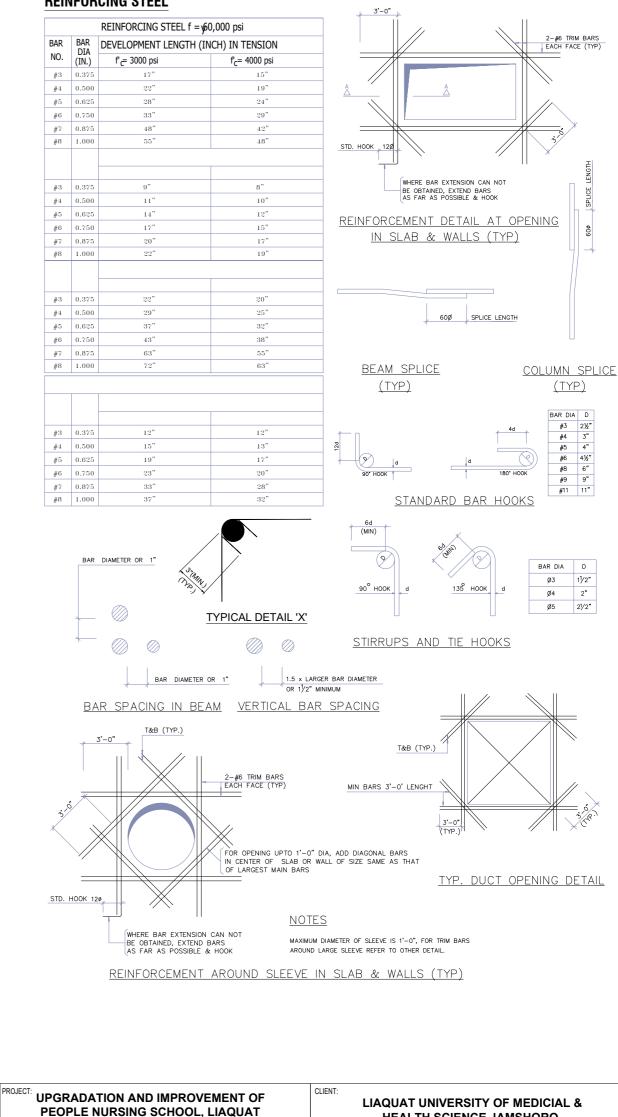


Head Office: Office No.B-6 SECOND FLOOR Masood Arcade IJP Road Islamabad. Ph: +92-51-4848375, Fax: +92-51-4848375 Email: newvisionec@yahoo.com Regional Office: 287-A Street # 6, Cavalry Ground ,Lahore Ph: +92-42-37250130


LUMHS LIBRARY BLOCK GENERAL NOTES


UNIVERSITY OF MEDICIAL & HEALTH


SCIENCE JAMSHORO

LIAQUAT UNIVERSITY OF MEDICIAL & HEALTH SCIENCE JAMSHORO									
ESIGNED BY: ENG.ZAIN ARSHAD	APPROVED BY:	DATE :	FEB,2024						
RAWN BY: MATHEW SIMON	JOB NO.	SCALE:	N.T.S						
RG. NO.	ST-02								

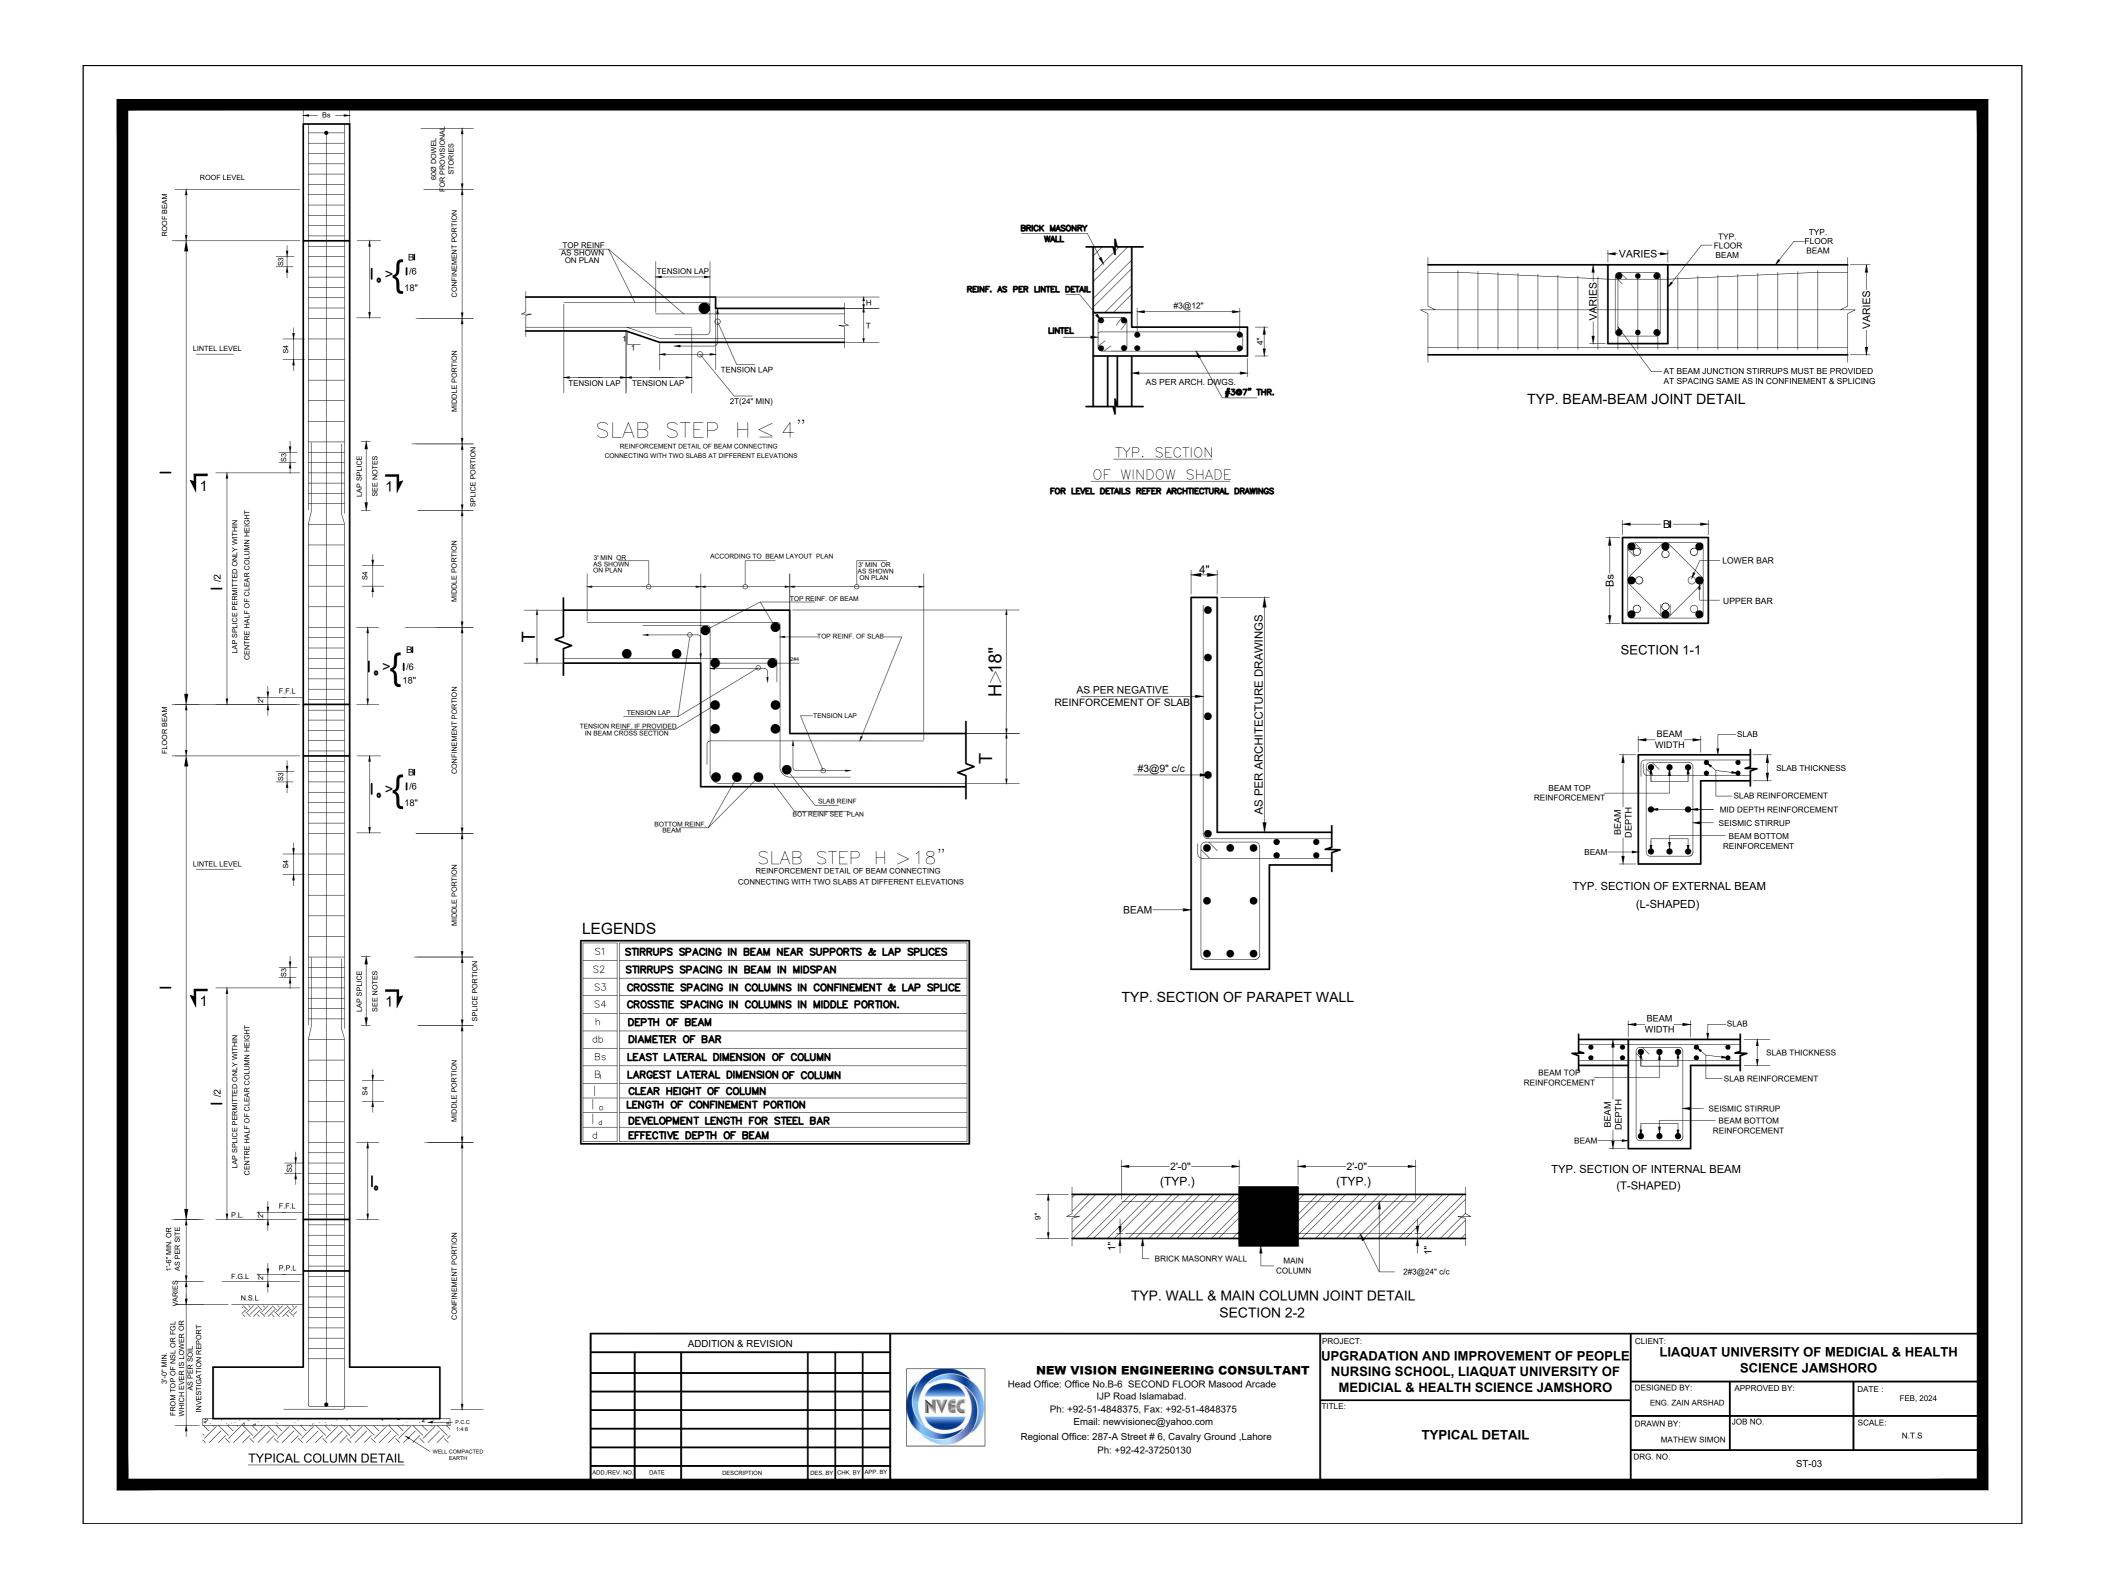


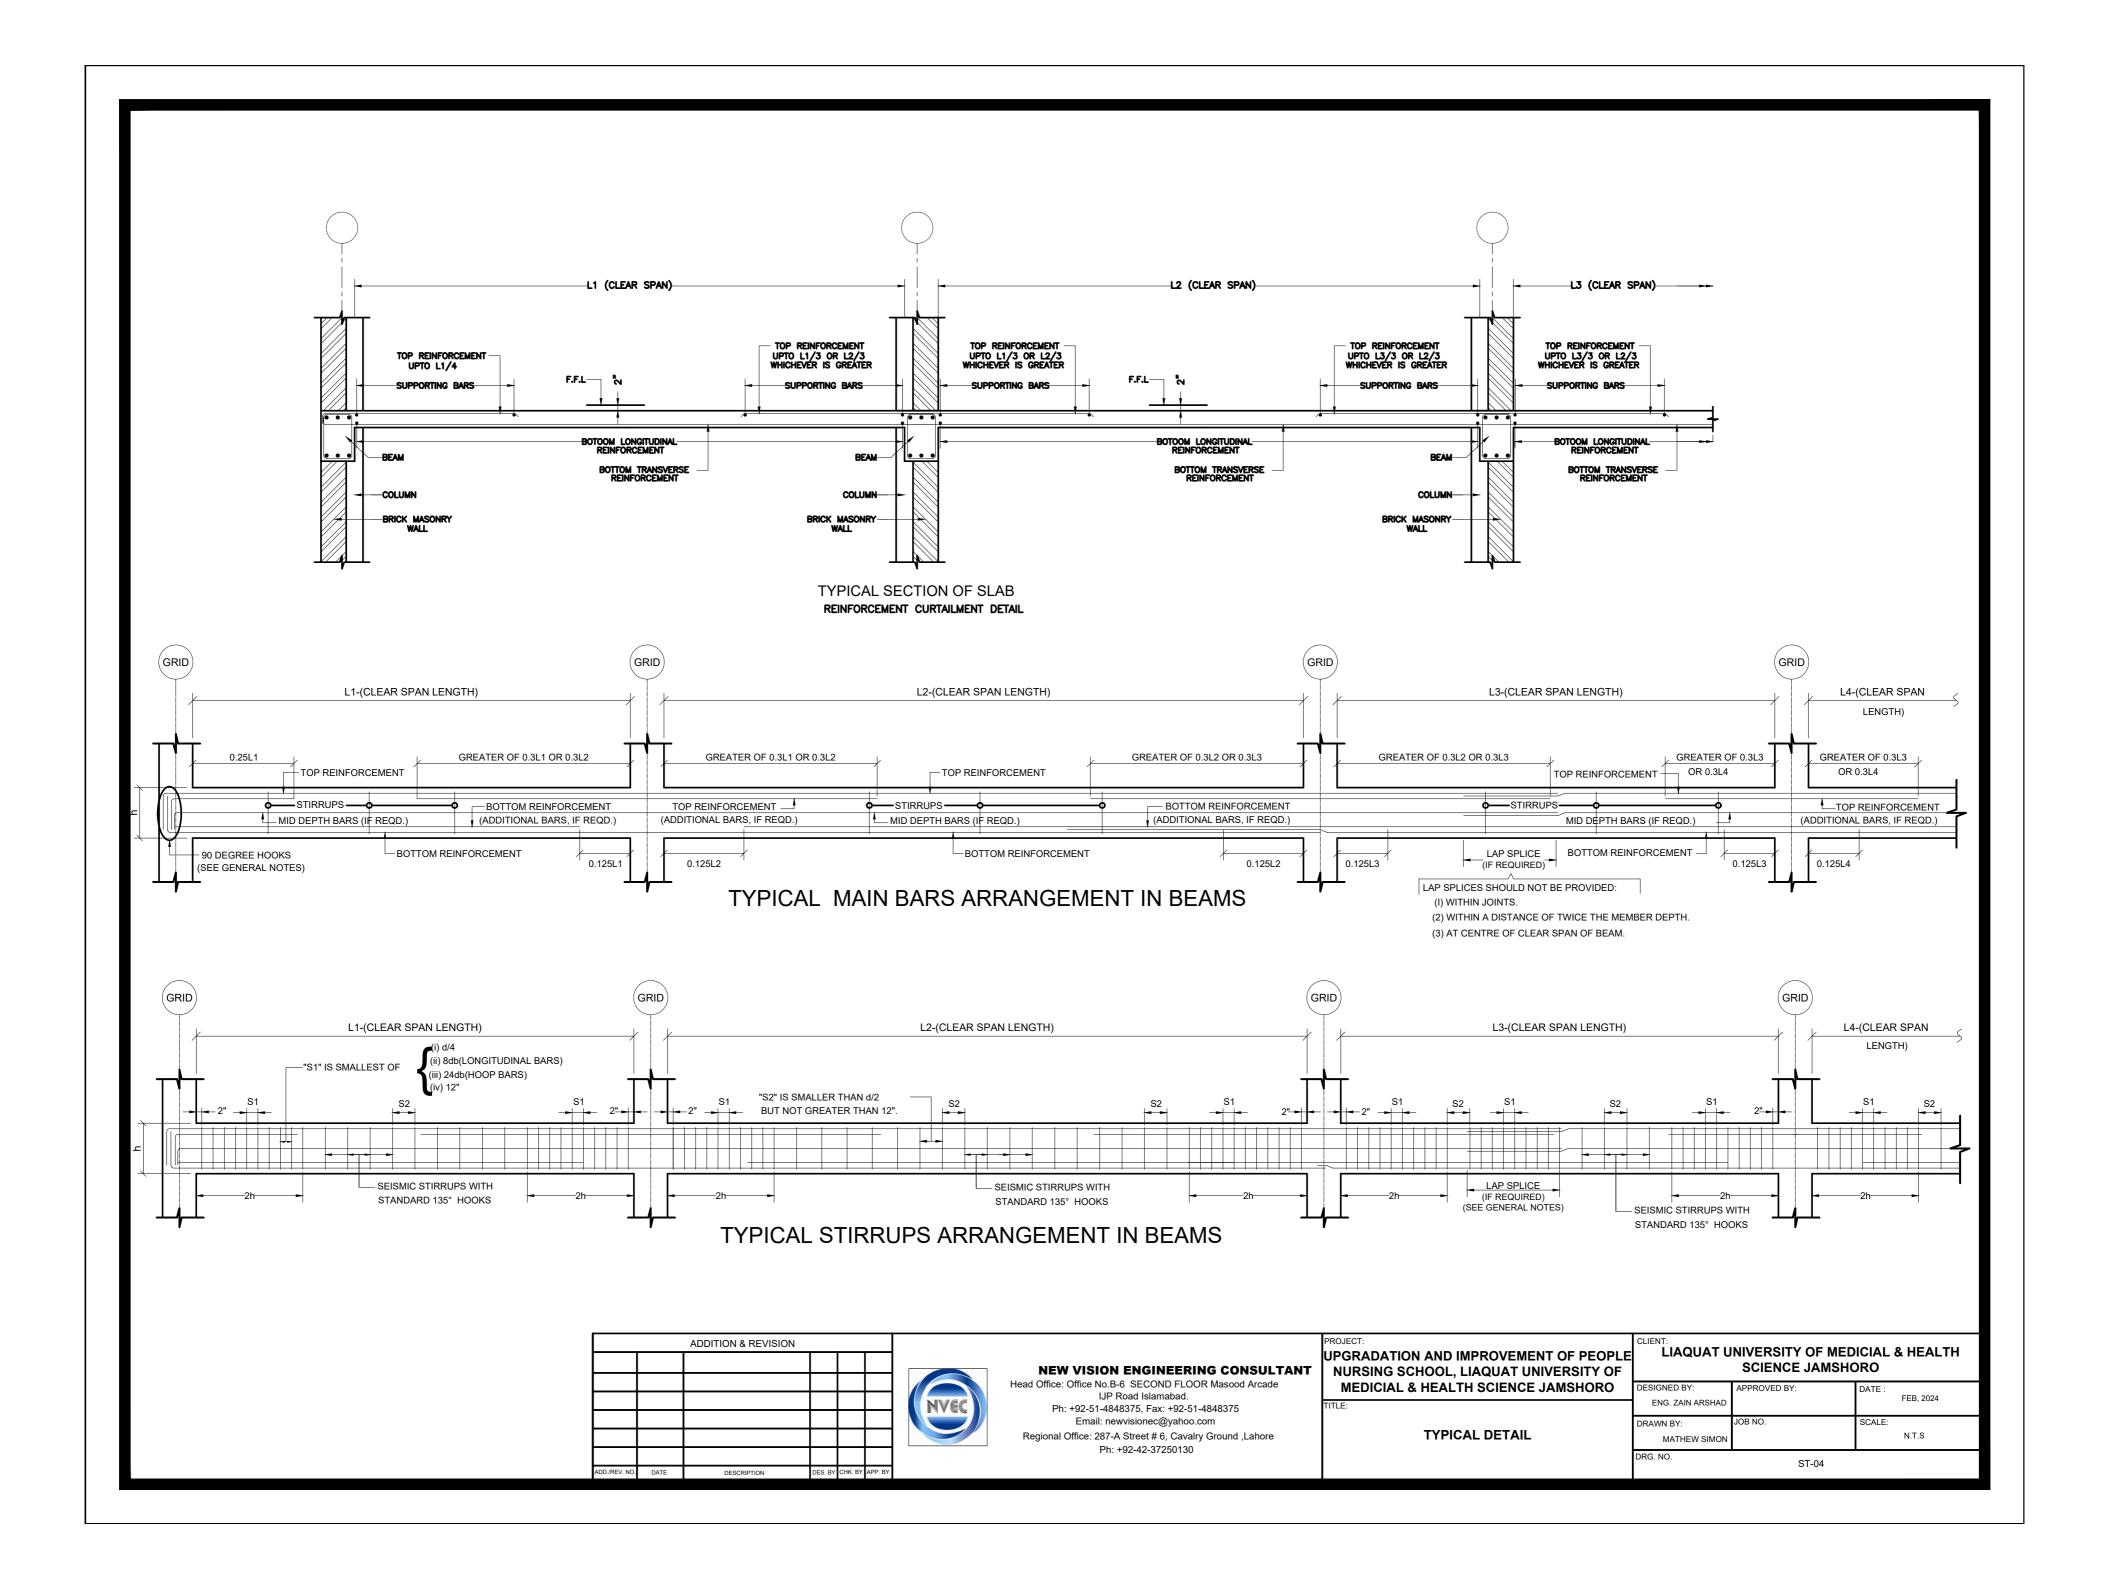


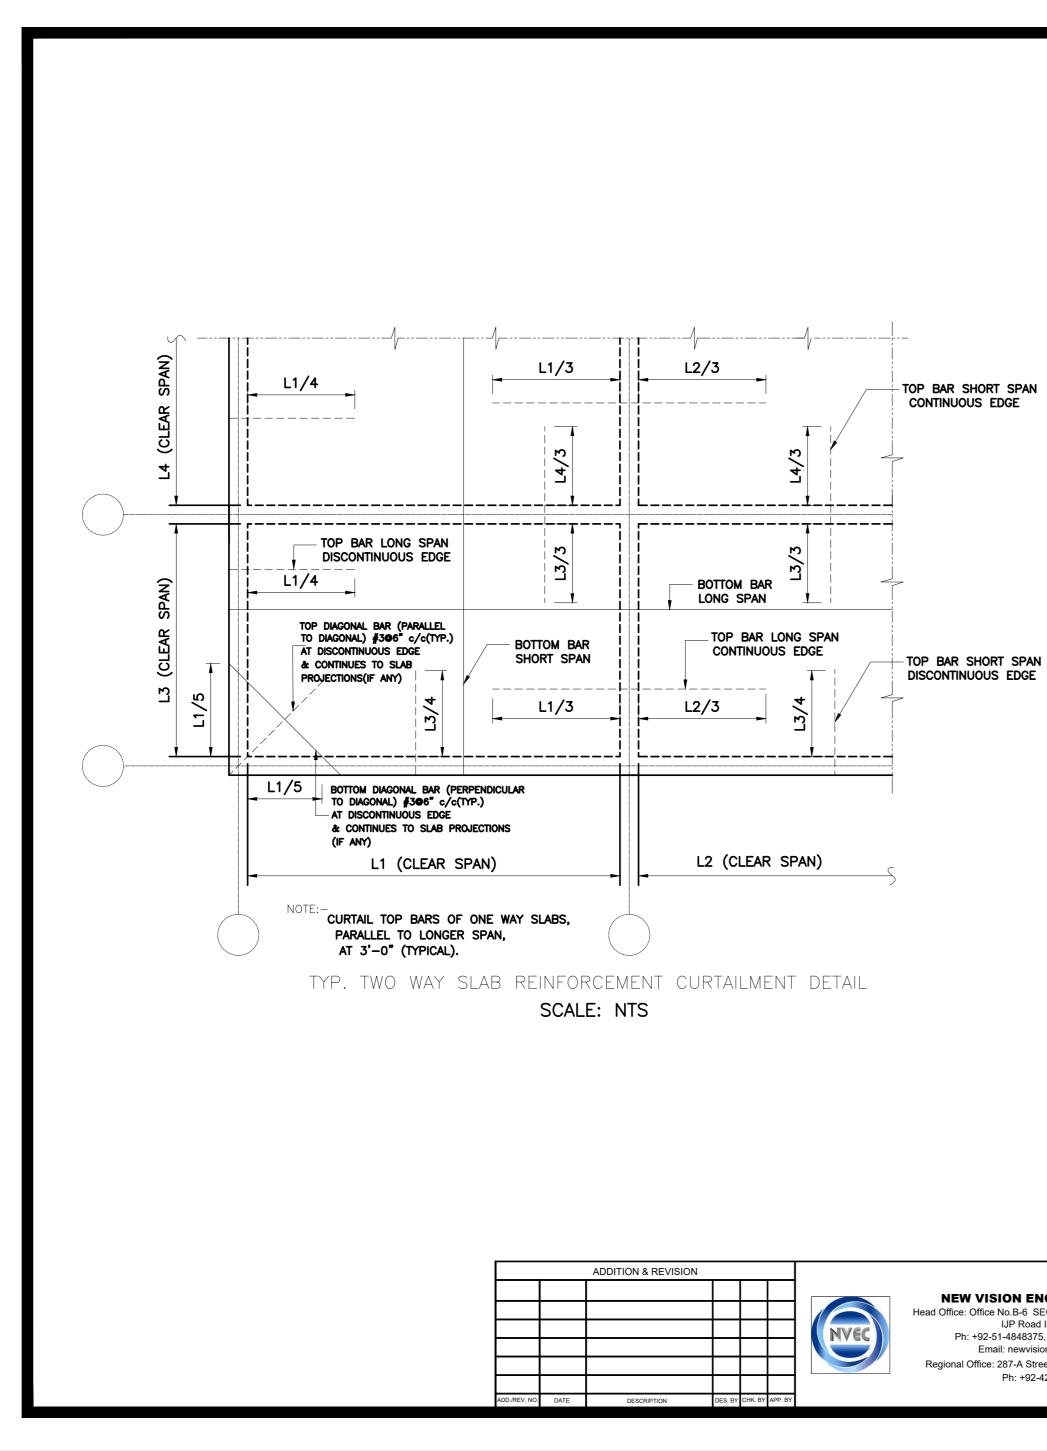

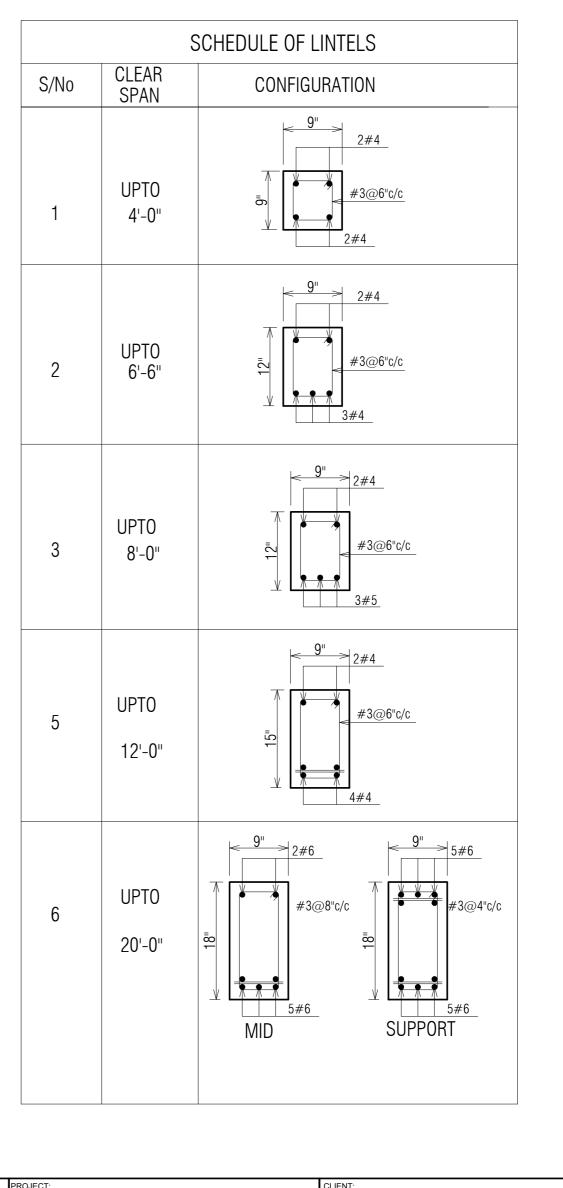

NGINEERING CONSULTANT	UPGRADATION AND IMPROVEMENT OF PEOPLE NURSING SCHOOL, LIAQUAT UNIVERSITY OF	CLIENT: LIAQUAT UNIVERSITY OF MEDICIAL & HEALTH SCIENCE JAMSHORO				
SECOND FLOOR Masood Arcade d Islamabad.	MEDICIAL & HEALTH SCIENCE JAMSHORO	DESIGNED BY: ENG. ZAIN ARSHAD	APPROVED BY:	DATE : FEB, 2024		
'5, Fax: +92-51-4848375 ionec@yahoo.com reet # 6, Cavalry Ground ,Lahore -42-37250130		DRAWN BY: MATHEW SIMON		SCALE: N.T.S		
-42-57250150		DRG. NO. ST-05				

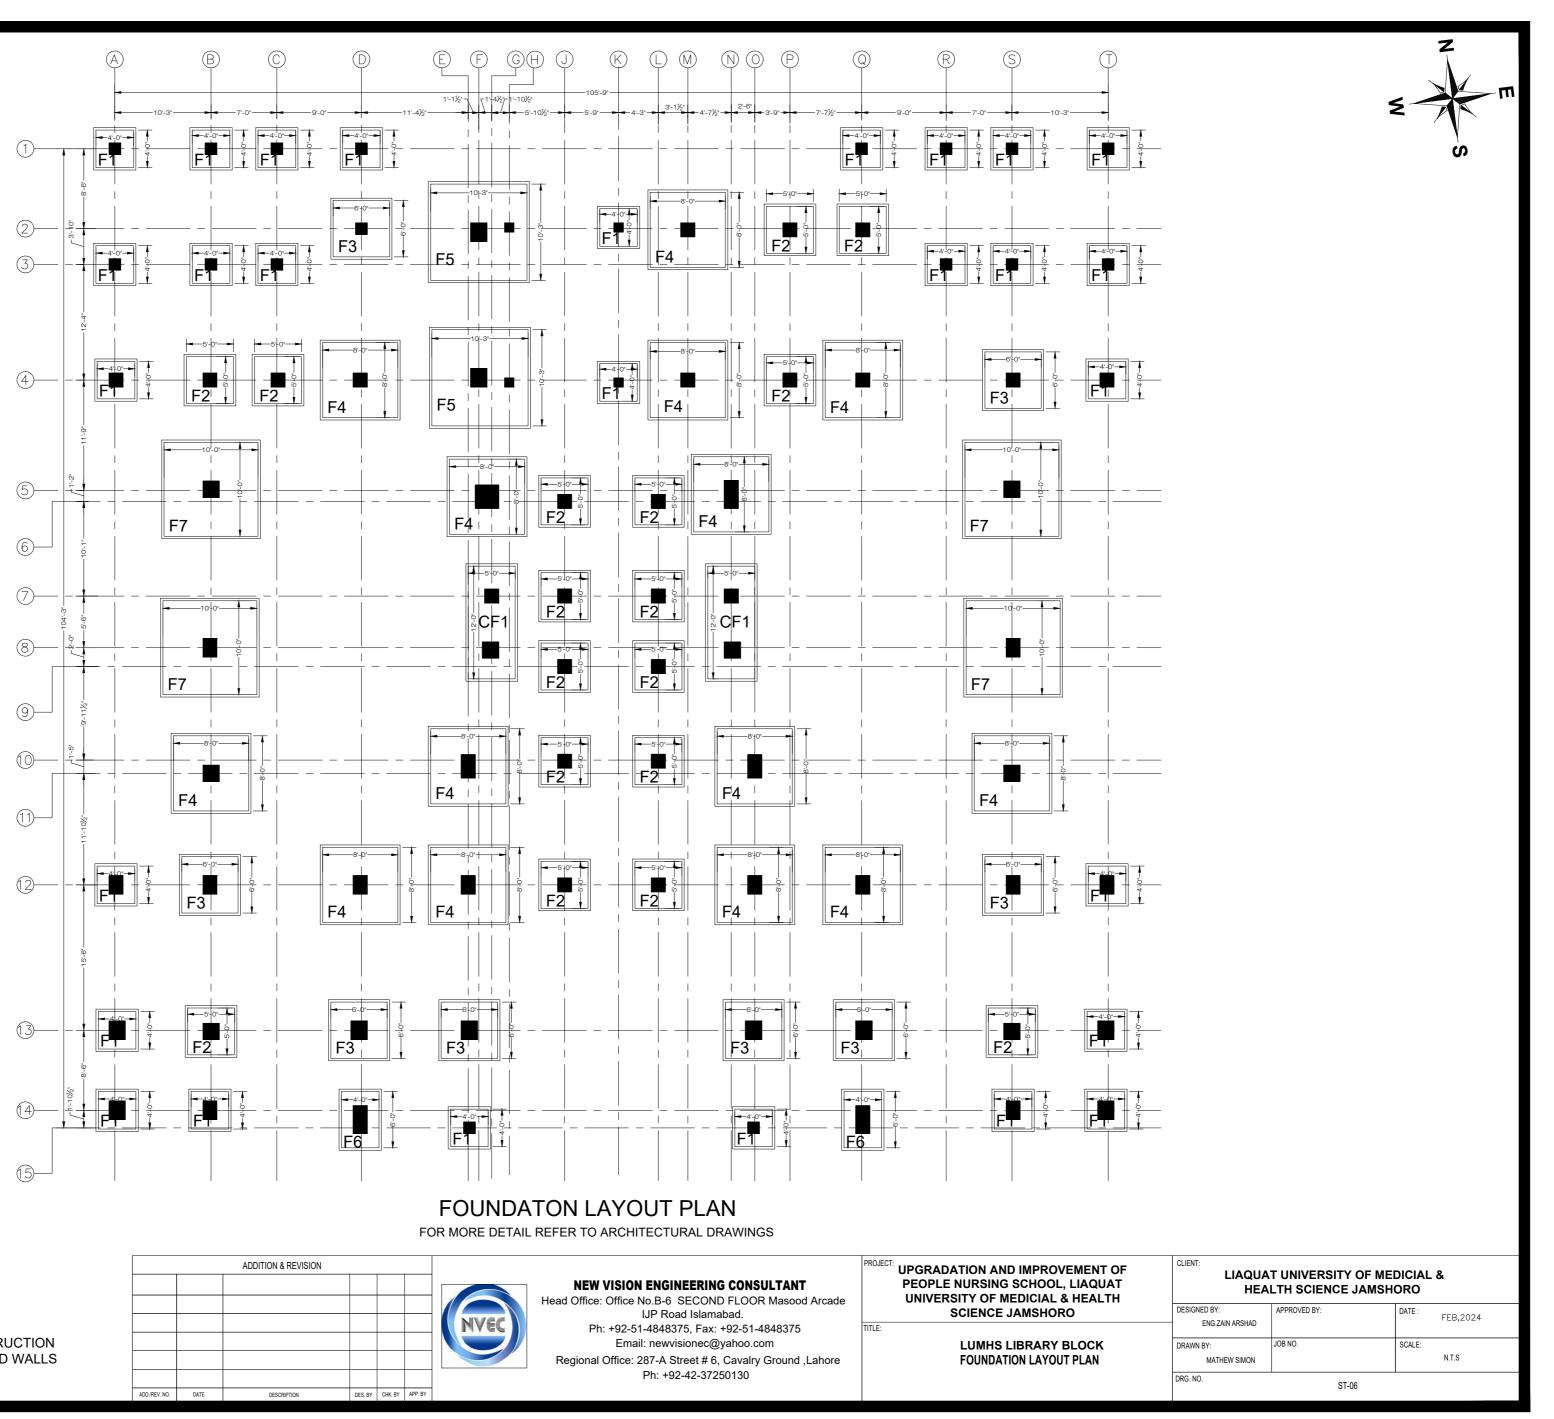

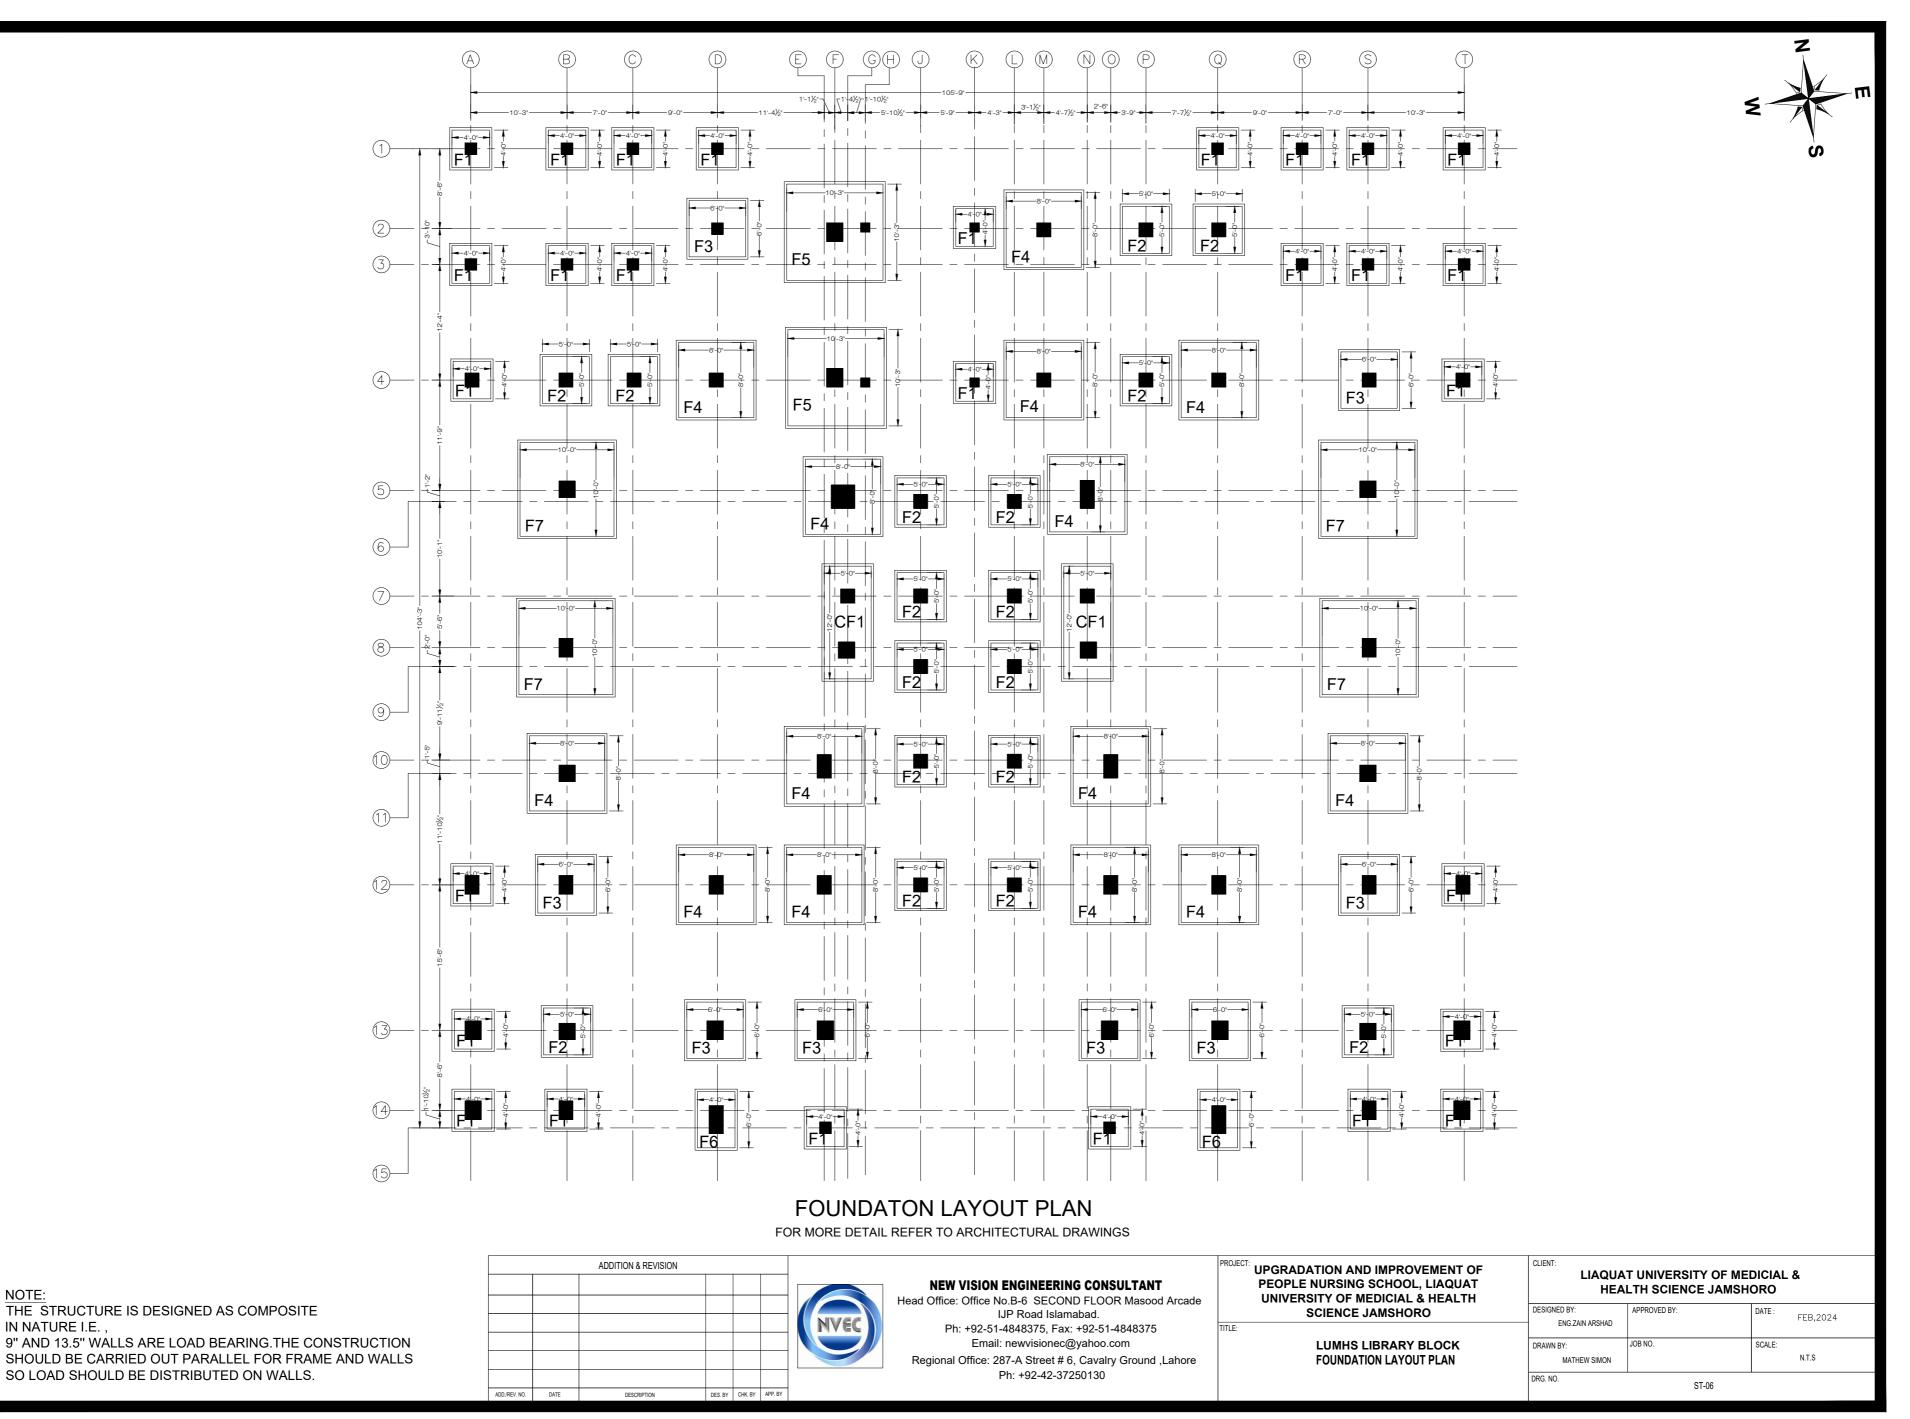

NOTE:

THE STRUCTURE IS DESIGNED AS COMPOSITE IN NATURE I.E.,

SHOULD BE CARRIED OUT PARALLEL FOR FRAME AND WALLS SO LOAD SHOULD BE DISTRIBUTED ON WALLS.

SCHEDULE OF FOOTINGS

MARK		S	SIZE	F	REINFORCEMENT DETAIL						
	1	10/	11	BOTTON	I BARS	TOP	BARS	REMARKS			
		W	Н	BS	BL	TS	TL				
F1	4'-0"	4'-0"	12"	#4@8" c/c	#4@8" c/c	#3@7" c/c	#3@7" c/c	ISOLATED FOOTING			
F2	5'-0"	5'-0"	12"	#4@5" c/c	#4@5" c/c	#3@7" c/c	#3@7" c/c	ISOLATED FOOTING			
F3	6'-0"	6'-0"	12"	#5@5.5" c/c	#5@6" c/c	#3@7" c/c	#3@7" c/c	ISOLATED FOOTING			
F4	8'-0"	8'-0"	15"	#4@5" c/c	#4@5" c/c	#3@7" c/c	#3@7" c/c	ISOLATED FOOTING			
F5	10'-3"	10'-3"	18"	#5@5" c/c	#5@5" c/c	#3@7" c/c	#3@7" c/c	ISOLATED FOOTING			
F6	4'-0"	6'-0"	12"	#5@5" c/c	#5@5" c/c	#5@7" c/c	#5@8" c/c	ISOLATED FOOTING			
F7	10'-0"	10'-0"	18"	#4@5" c/c	#4@5" c/c	#3@7" c/c	#3@7" c/c	ISOLATED FOOTING			


CF1	SIZE AS PER PLAN	18"	#4@5" c/c	#4@5" c/c


NOTE:		ADI	DITION & REVISION			NEW VISION ENGINEERING CONSULTANT Head Office: Office No.B-6 SECOND FLOOR Masood Arcade	PROJECT: UPGRADATION AND IMPROVEMENT OF PEOPLE NURSING SCHOOL, LIAQUAT UNIVERSITY OF MEDICIAL & HEALTH		AT UNIVERSITY ALTH SCIENCE	OF MEDICIAL & JAMSHORO
THE STRUCTURE IS DESIGNED AS COMPOSITE IN NATURE I.E. ,					NVEC	IJP Road Islamabad. Ph: +92-51-4848375, Fax: +92-51-4848375	SCIENCE JAMSHORO	DESIGNED BY: ENG.ZAIN ARSHAD	APPROVED BY:	DATE: FEB,2024
9" AND 13.5" WALLS ARE LOAD BEARING.THE CONSTRUCTION SHOULD BE CARRIED OUT PARALLEL FOR FRAME AND WALLS						Email: newvisionec@yahoo.com Regional Office: 287-A Street # 6, Cavalry Ground ,Lahore	LUMHS LIBRARY BLOCK FOUNDATION SCHEDULE	DRAWN BY: MATHEW SIMON	JOB NO.	SCALE: N.T.S
SO LOAD SHOULD BE DISTRIBUTED ON WALLS.	ADD./REV. NO.	DATE	DESCRIPTION	DES. BY CHK. BY APP. BY		Ph: +92-42-37250130		DRG. NO.	ST-	-07


#3@6" c/c

#3@6" c/c

COMBINED FOOTING

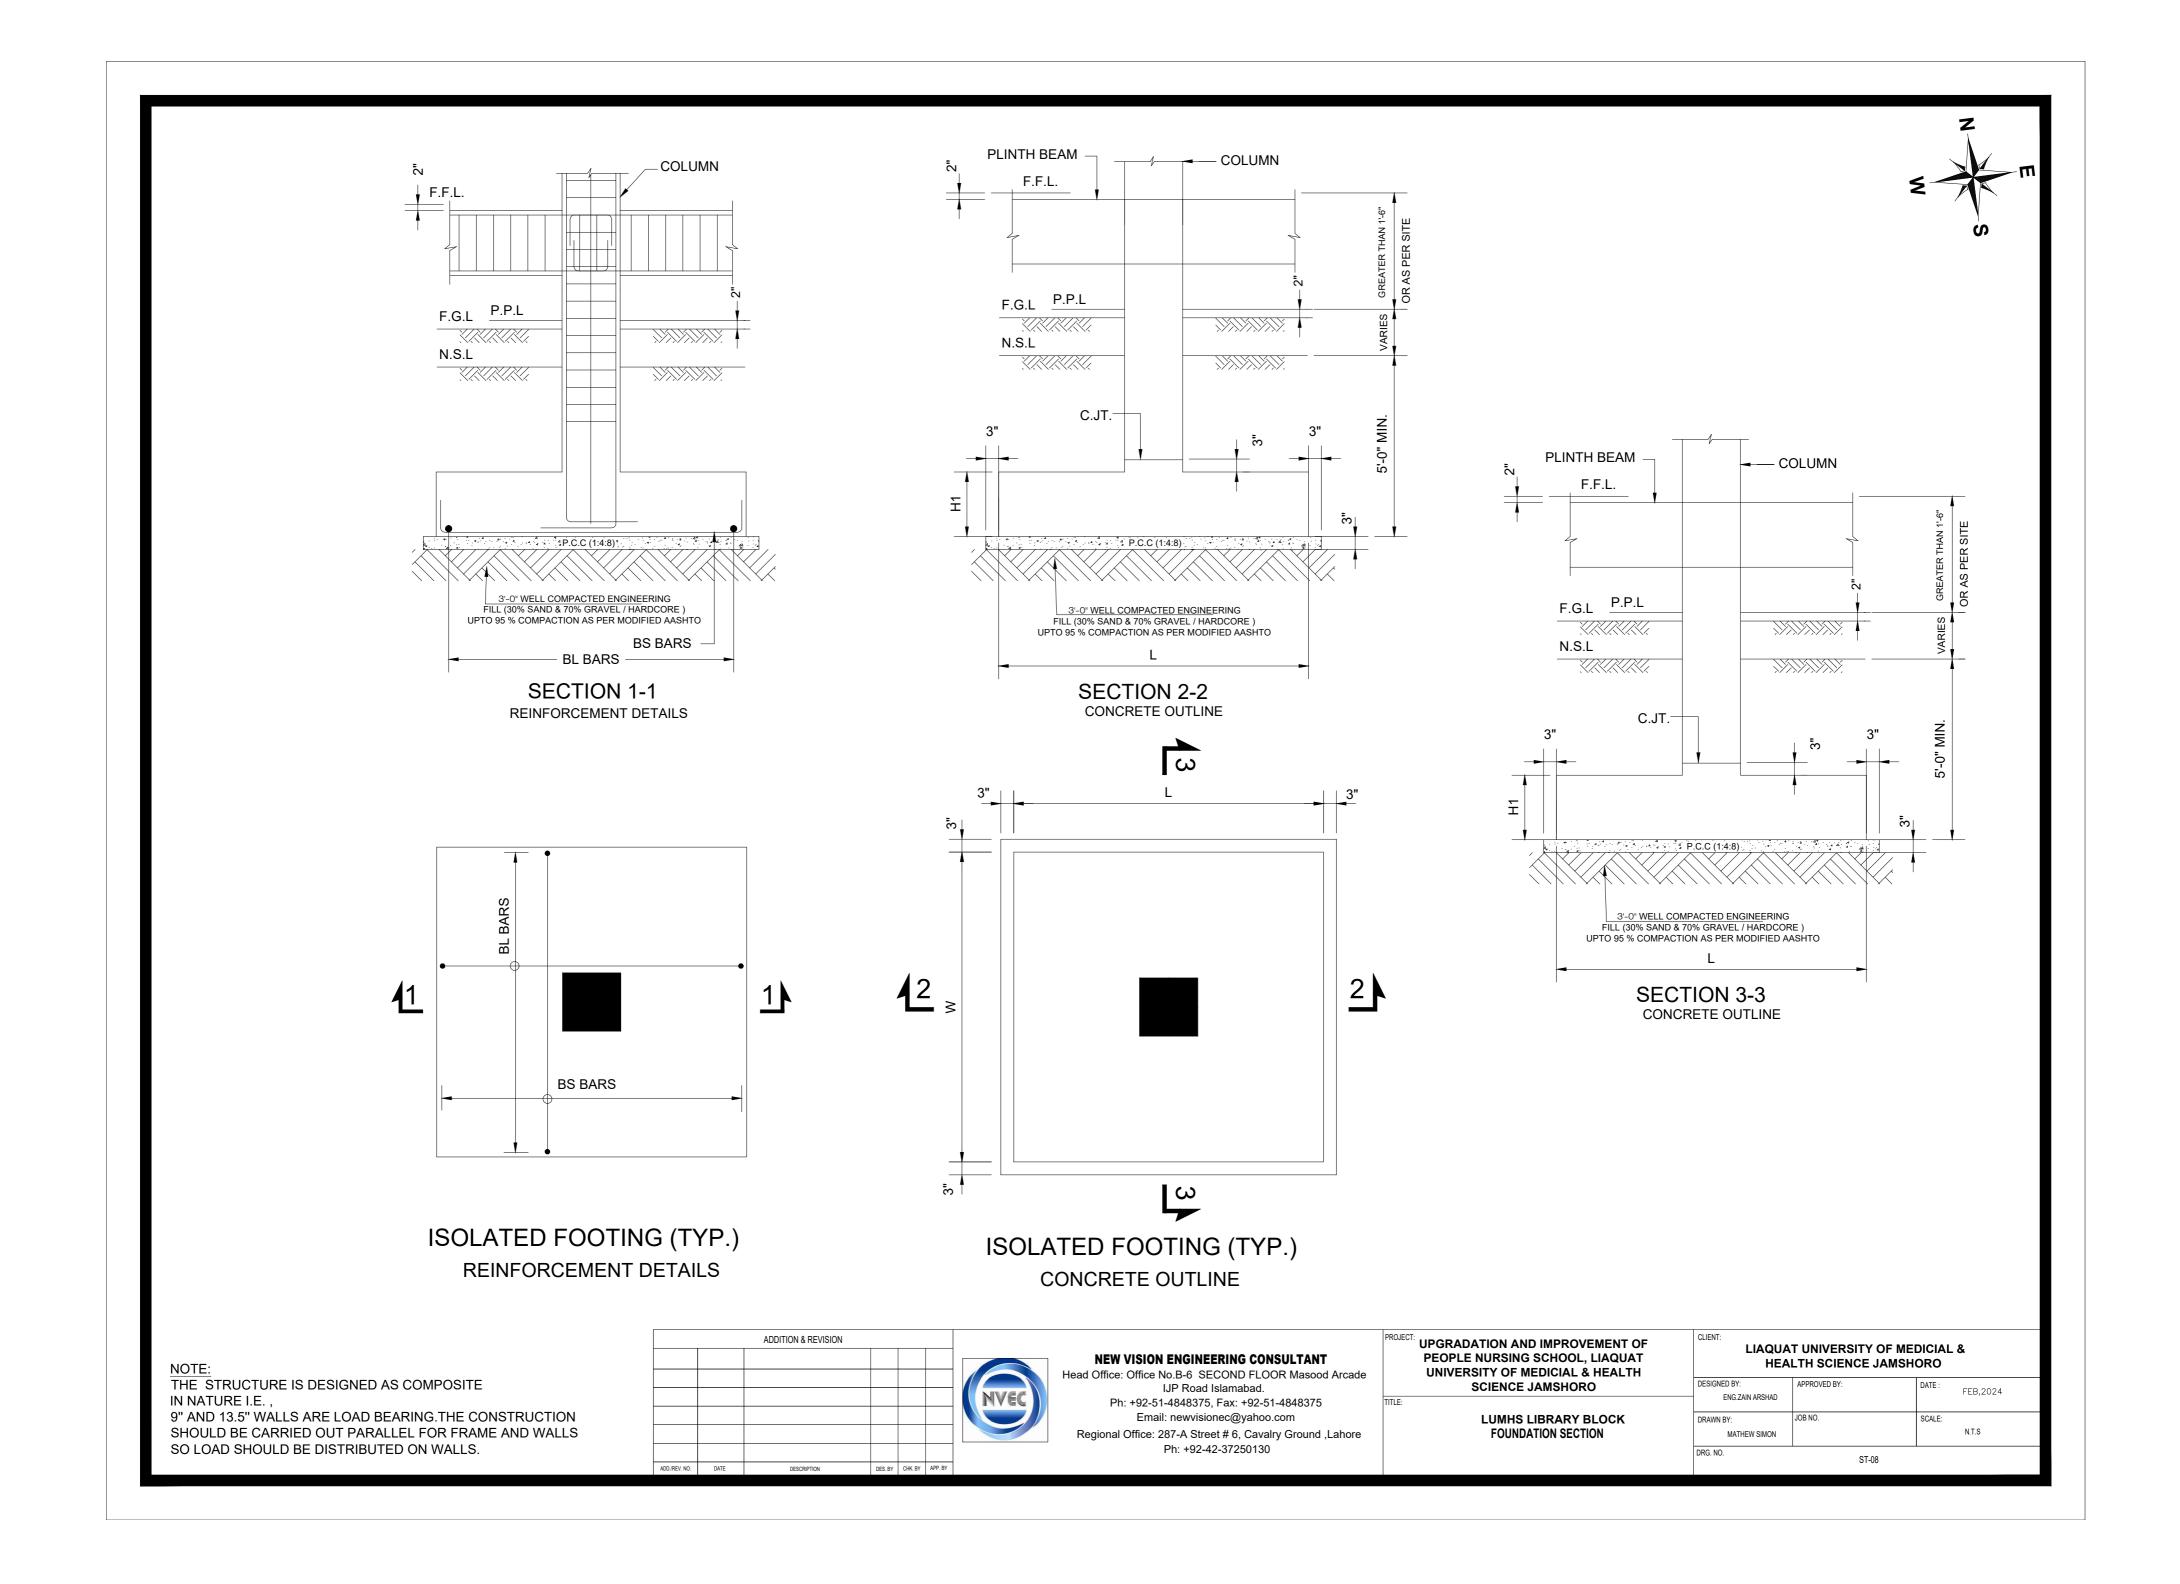


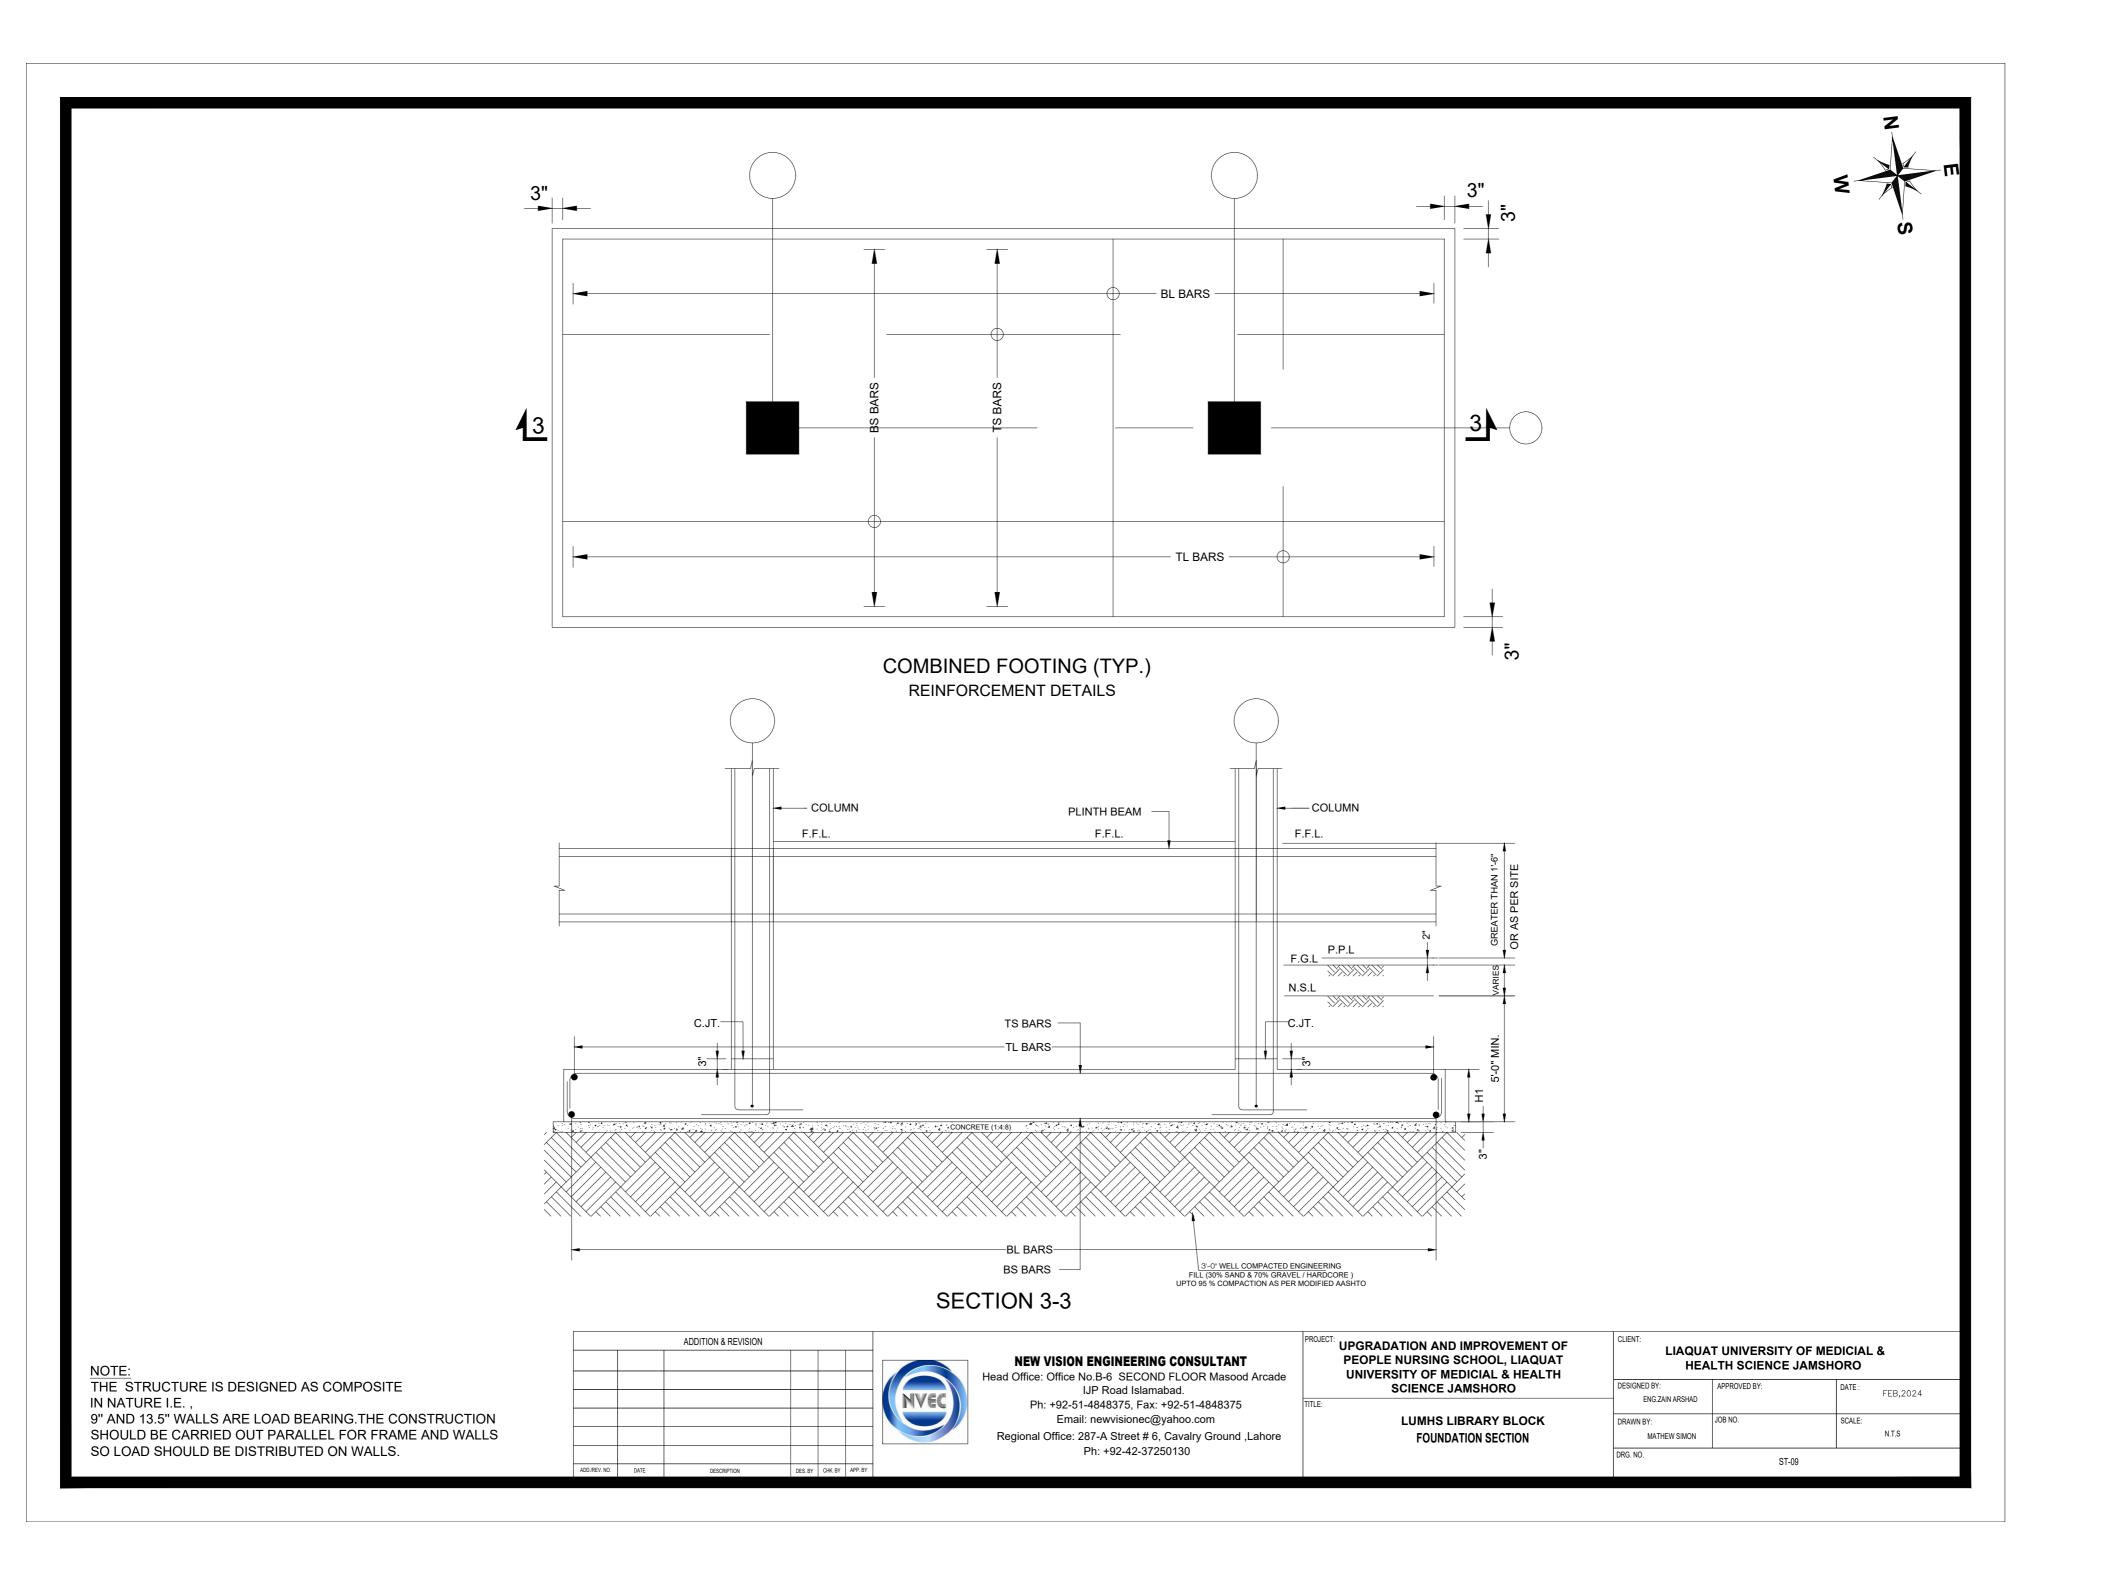


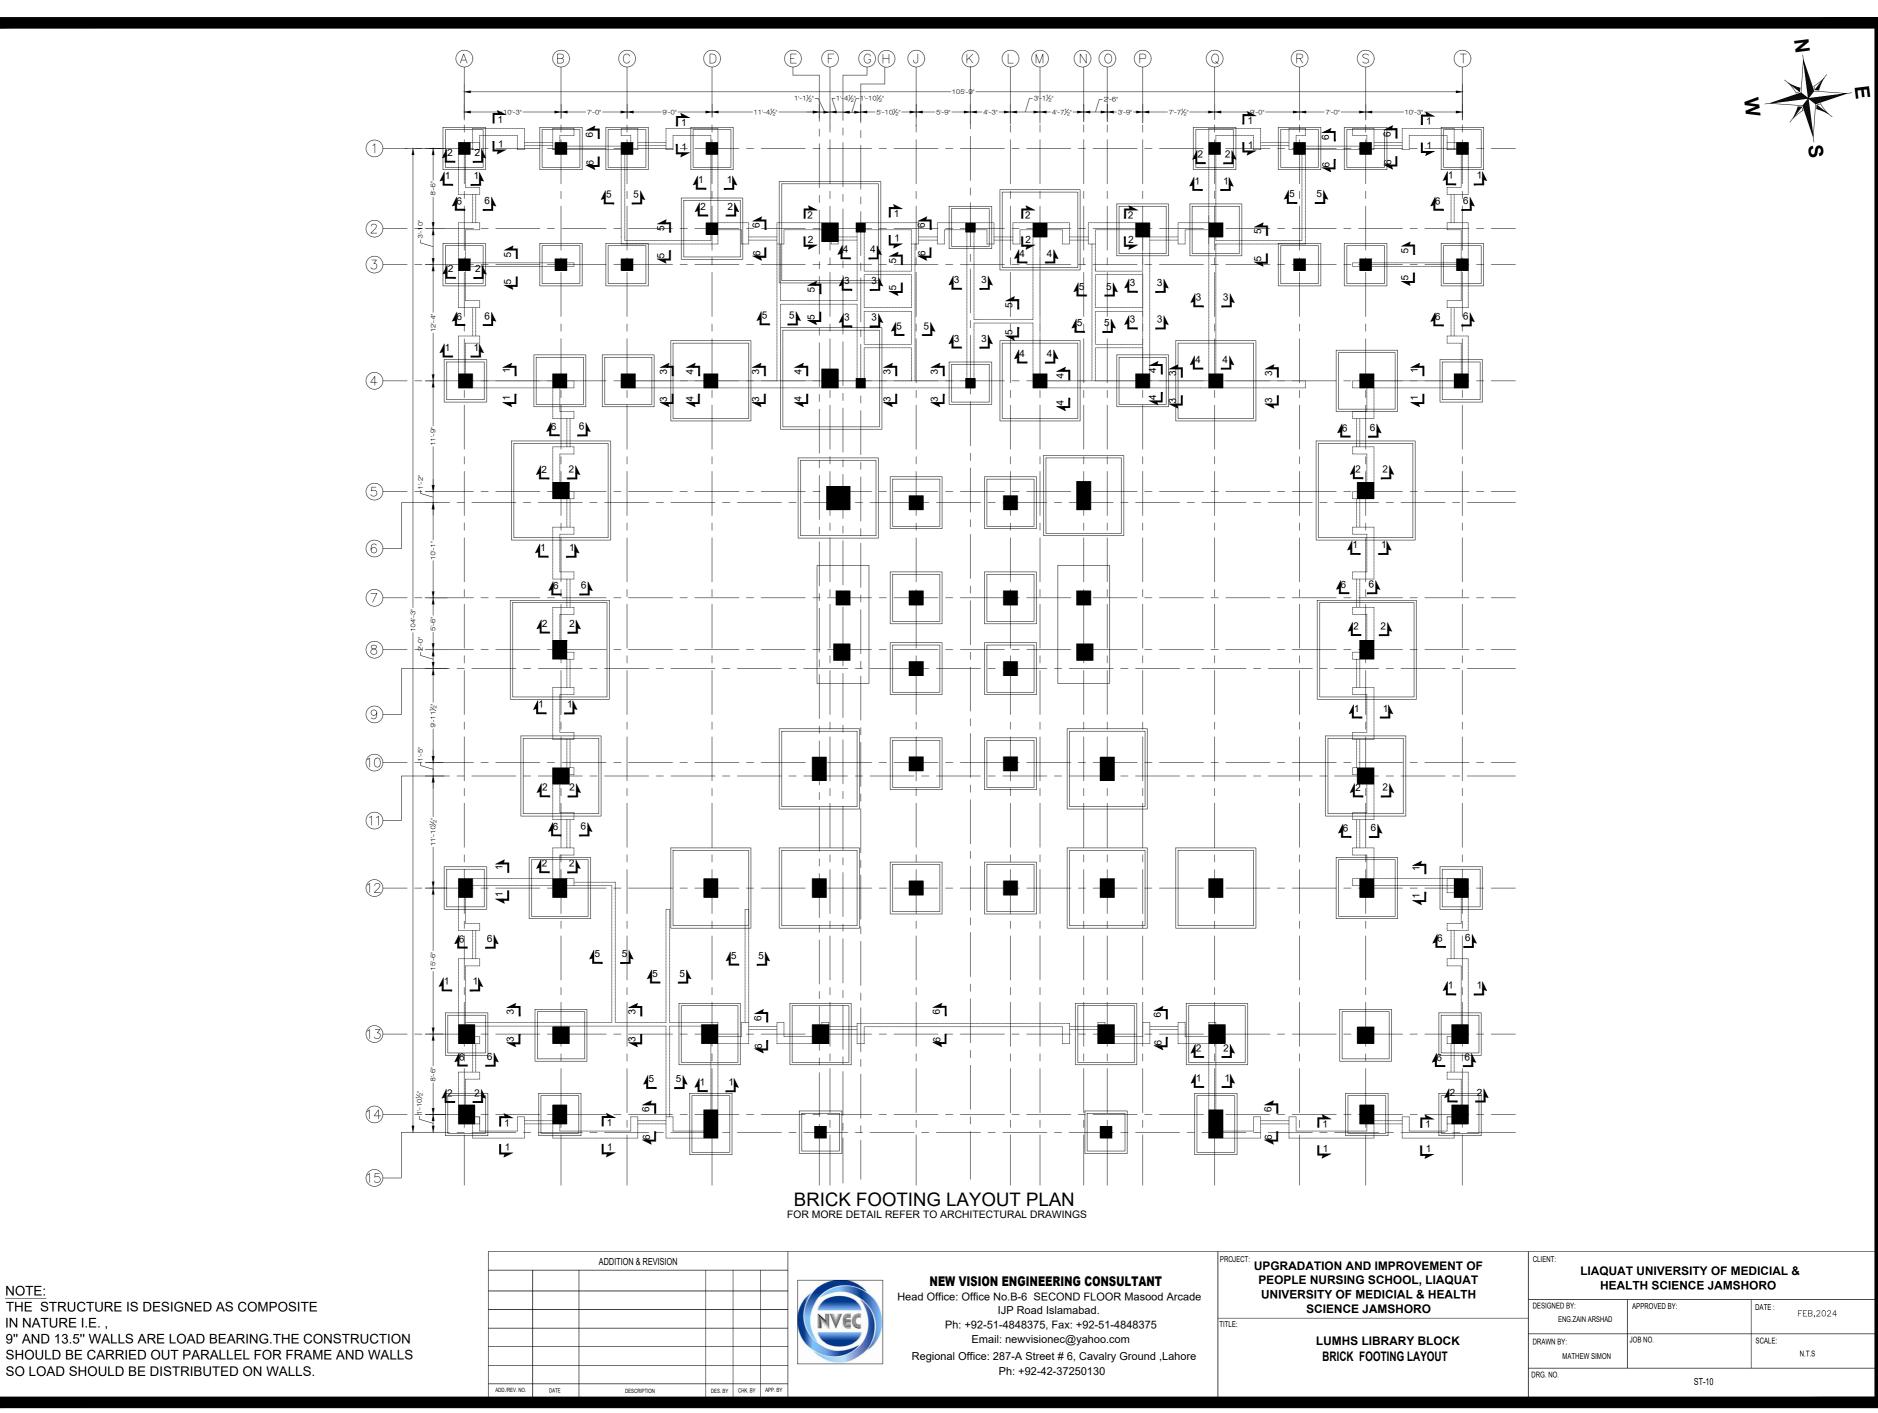


IN NATURE I.E., 9" AND 13.5" WALLS ARE LOAD BEARING. THE CONSTRUCTION SHOULD BE CARRIED OUT PARALLEL FOR FRAME AND WALLS SO LOAD SHOULD BE DISTRIBUTED ON WALLS.

NOTE:

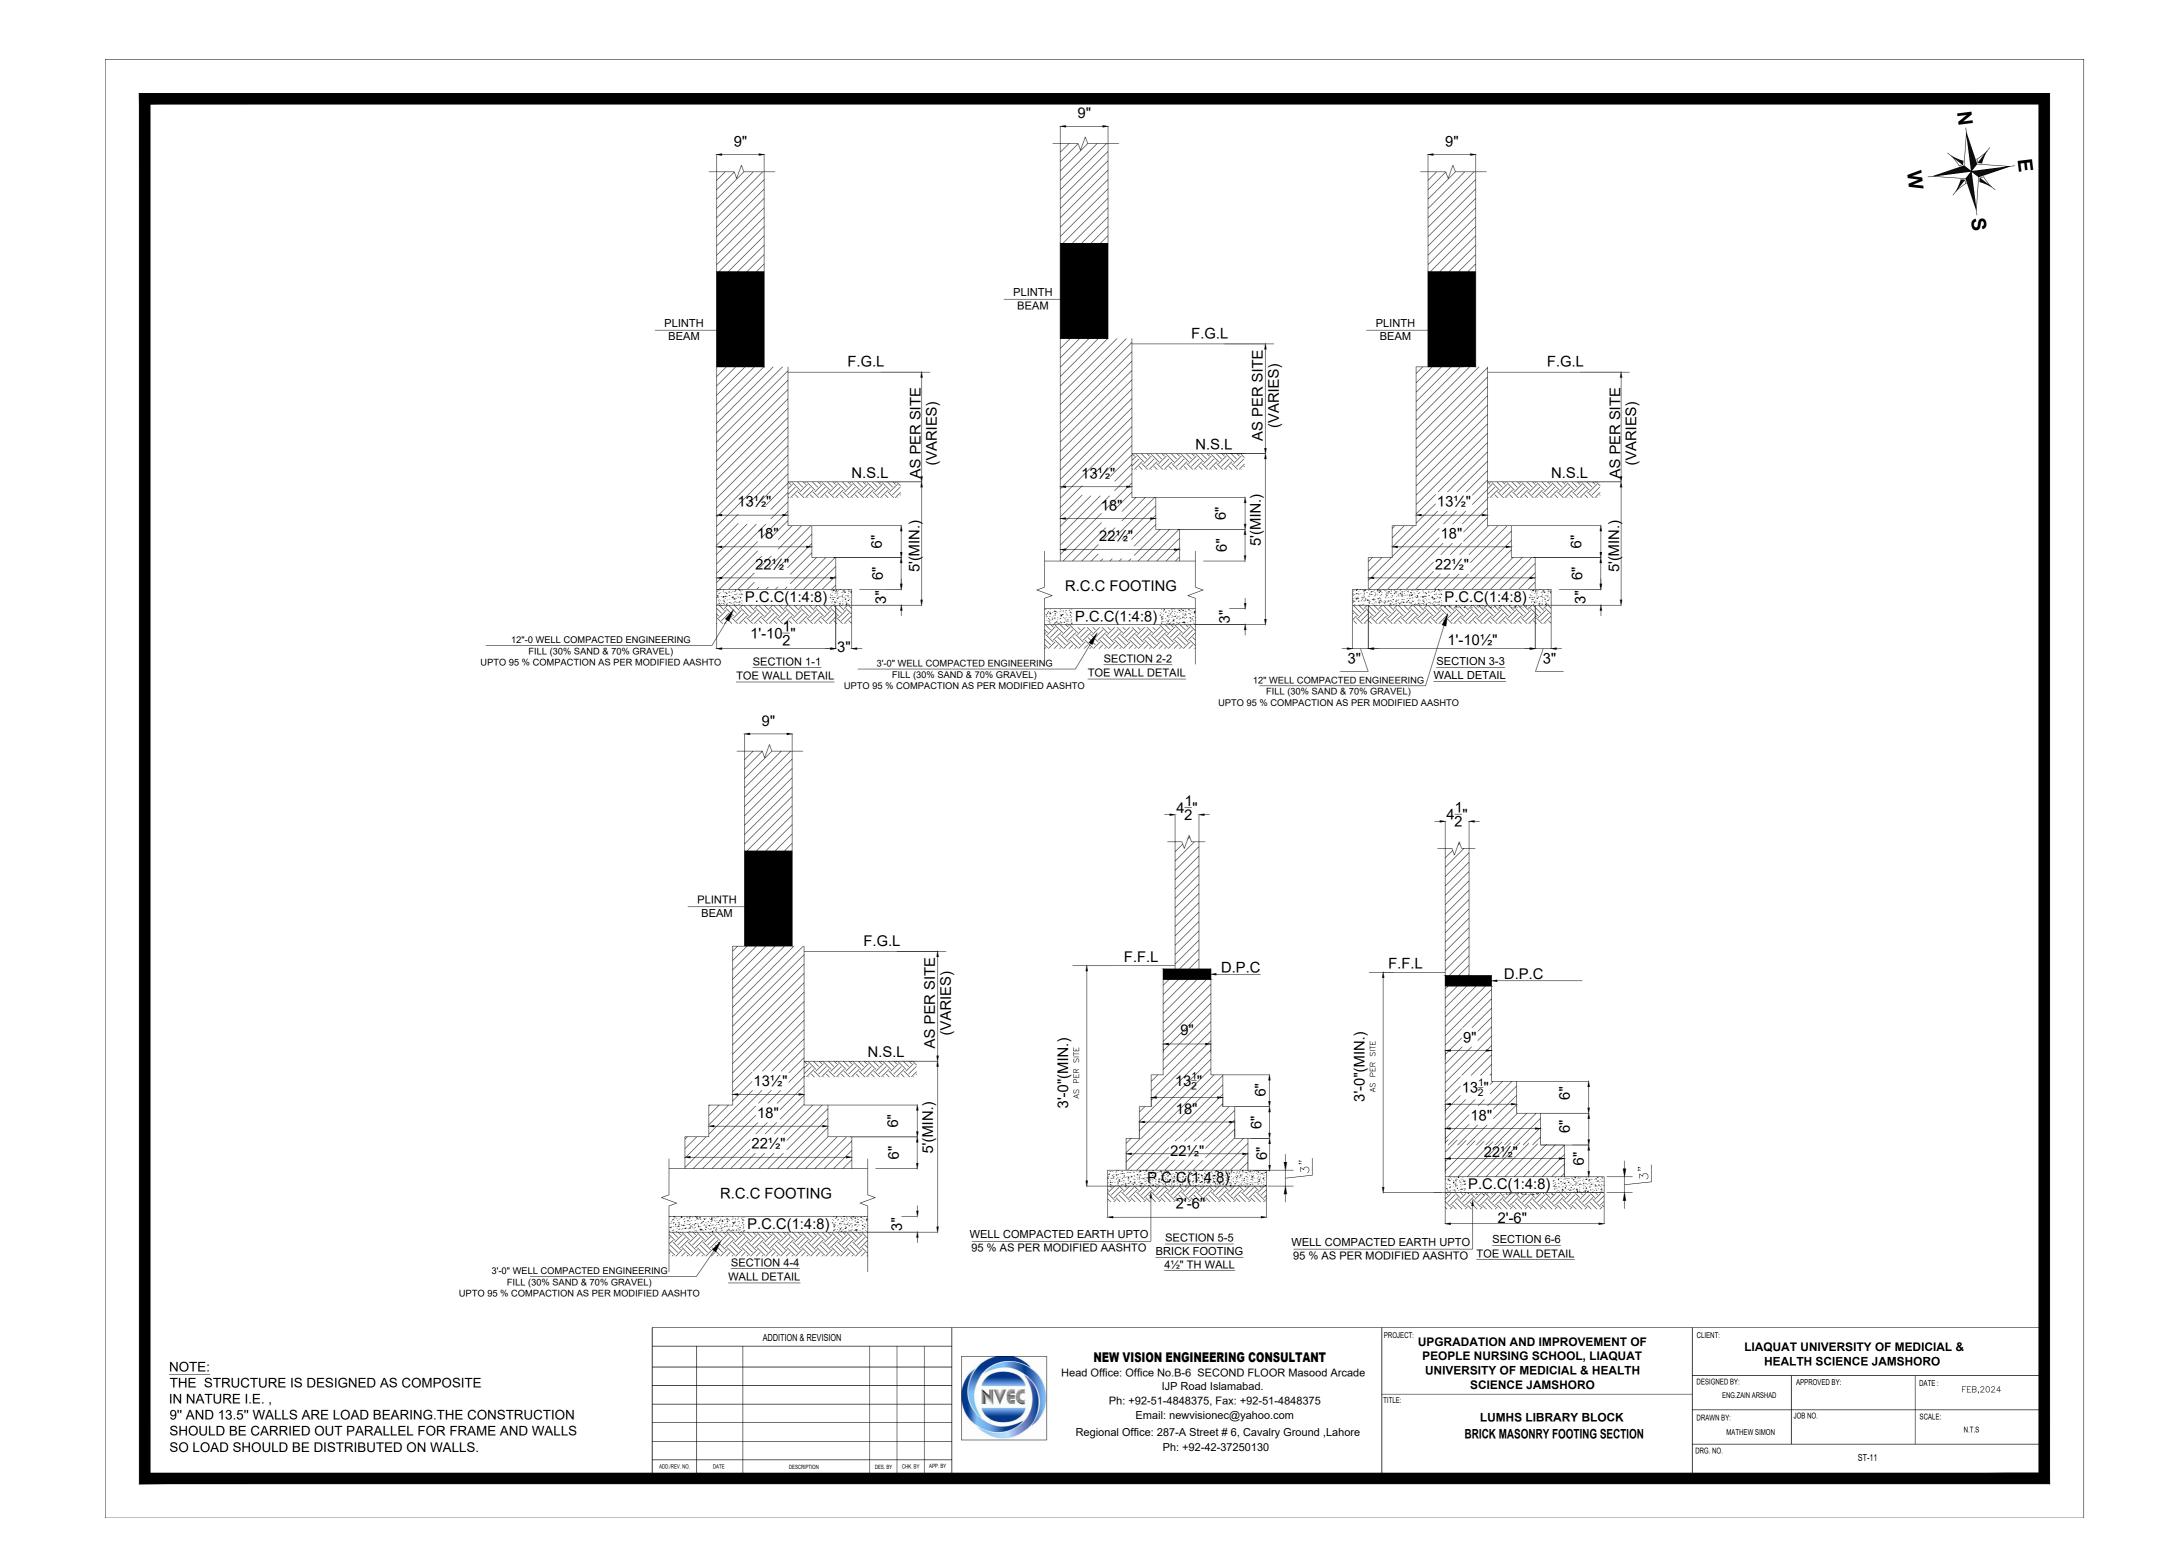


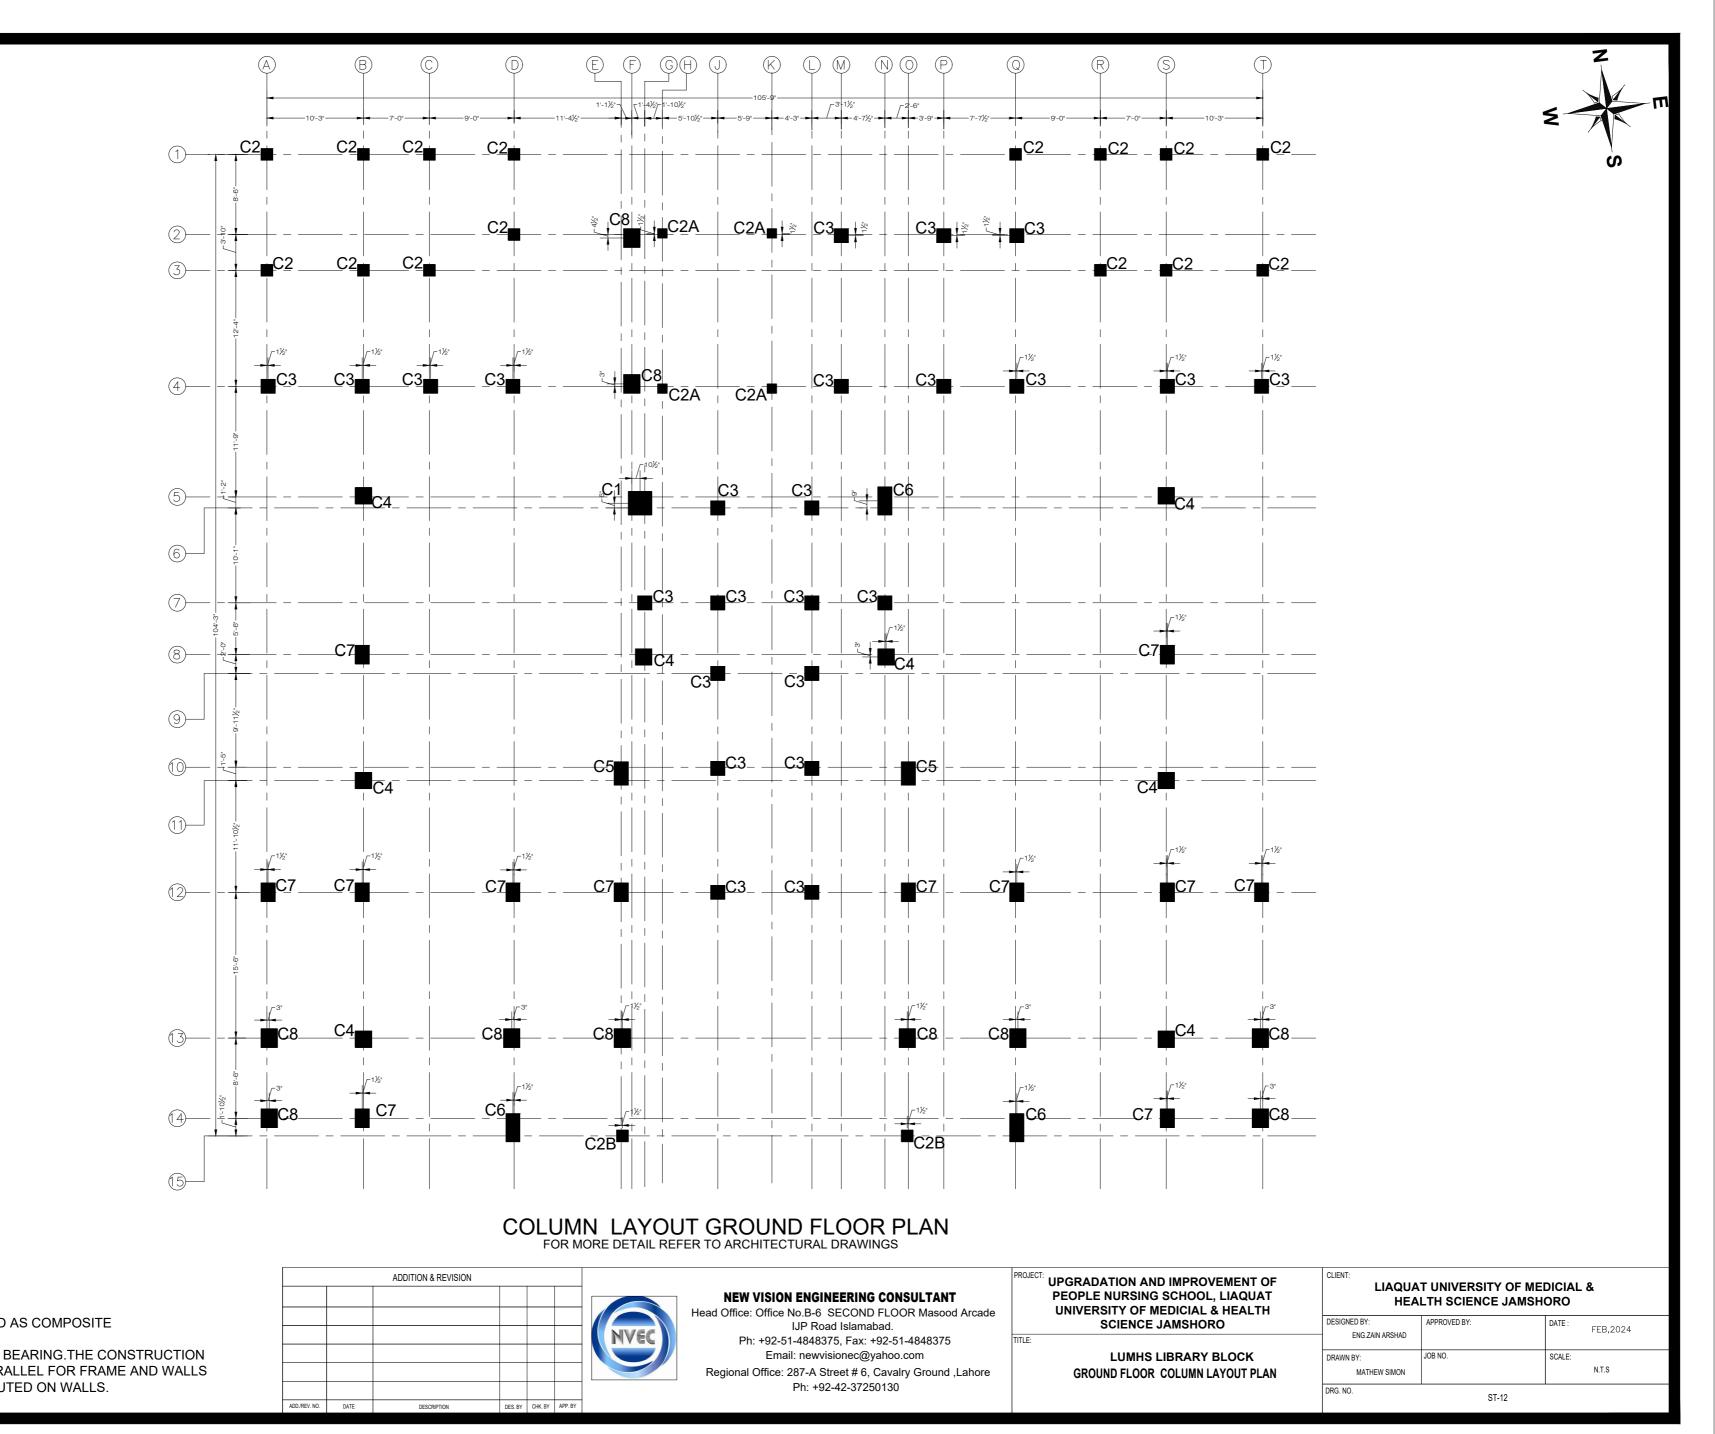

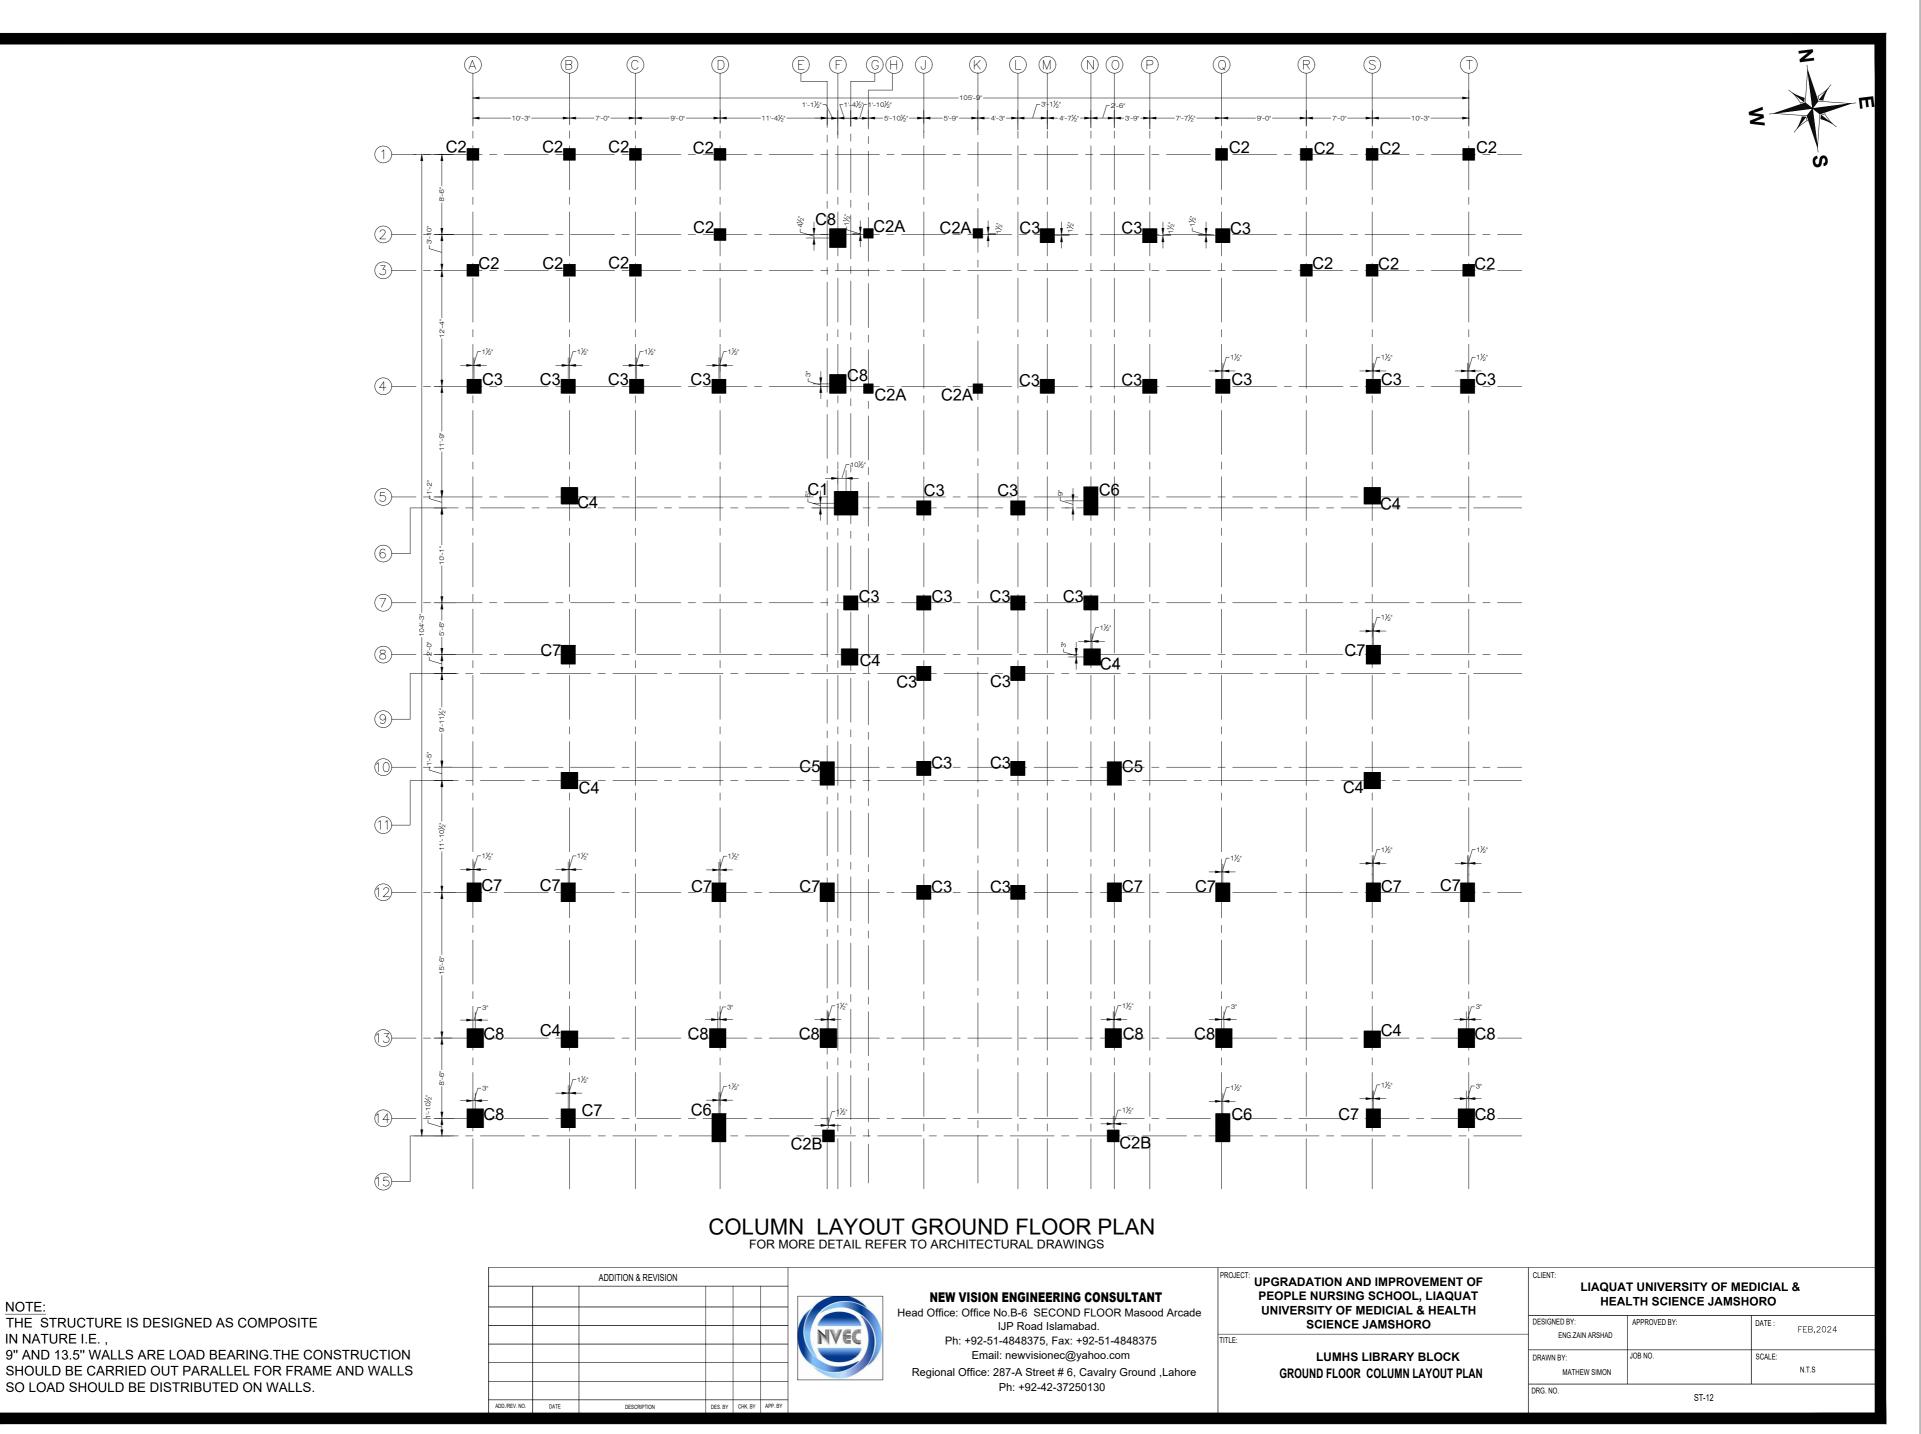



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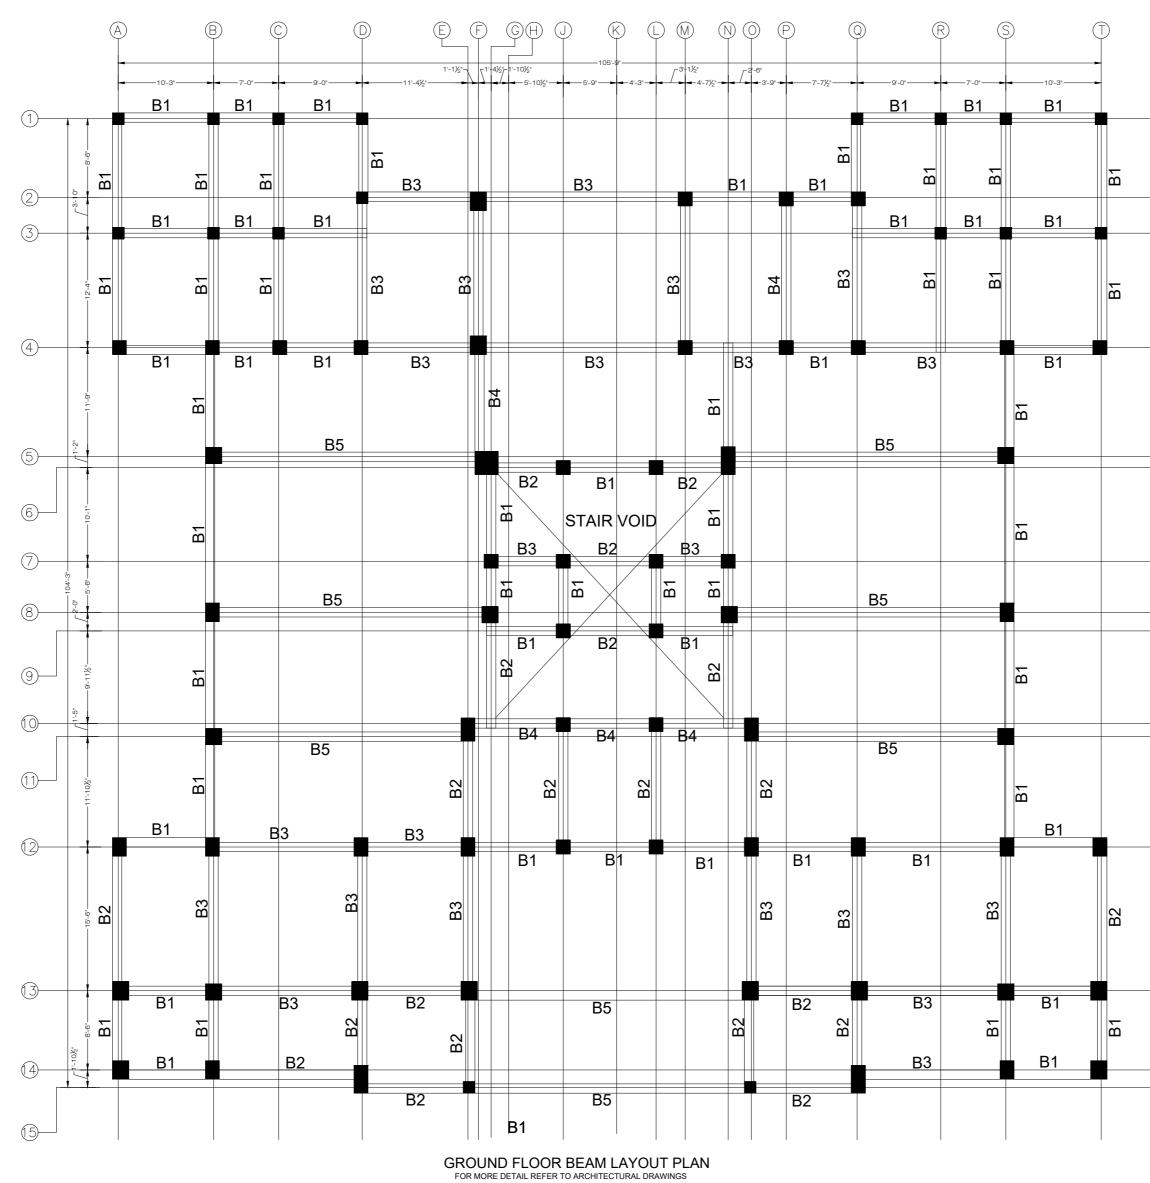
IN NATURE I.E., 9" AND 13.5" WALLS ARE LOAD BEARING. THE CONSTRUCTION SHOULD BE CARRIED OUT PARALLEL FOR FRAME AND WALLS

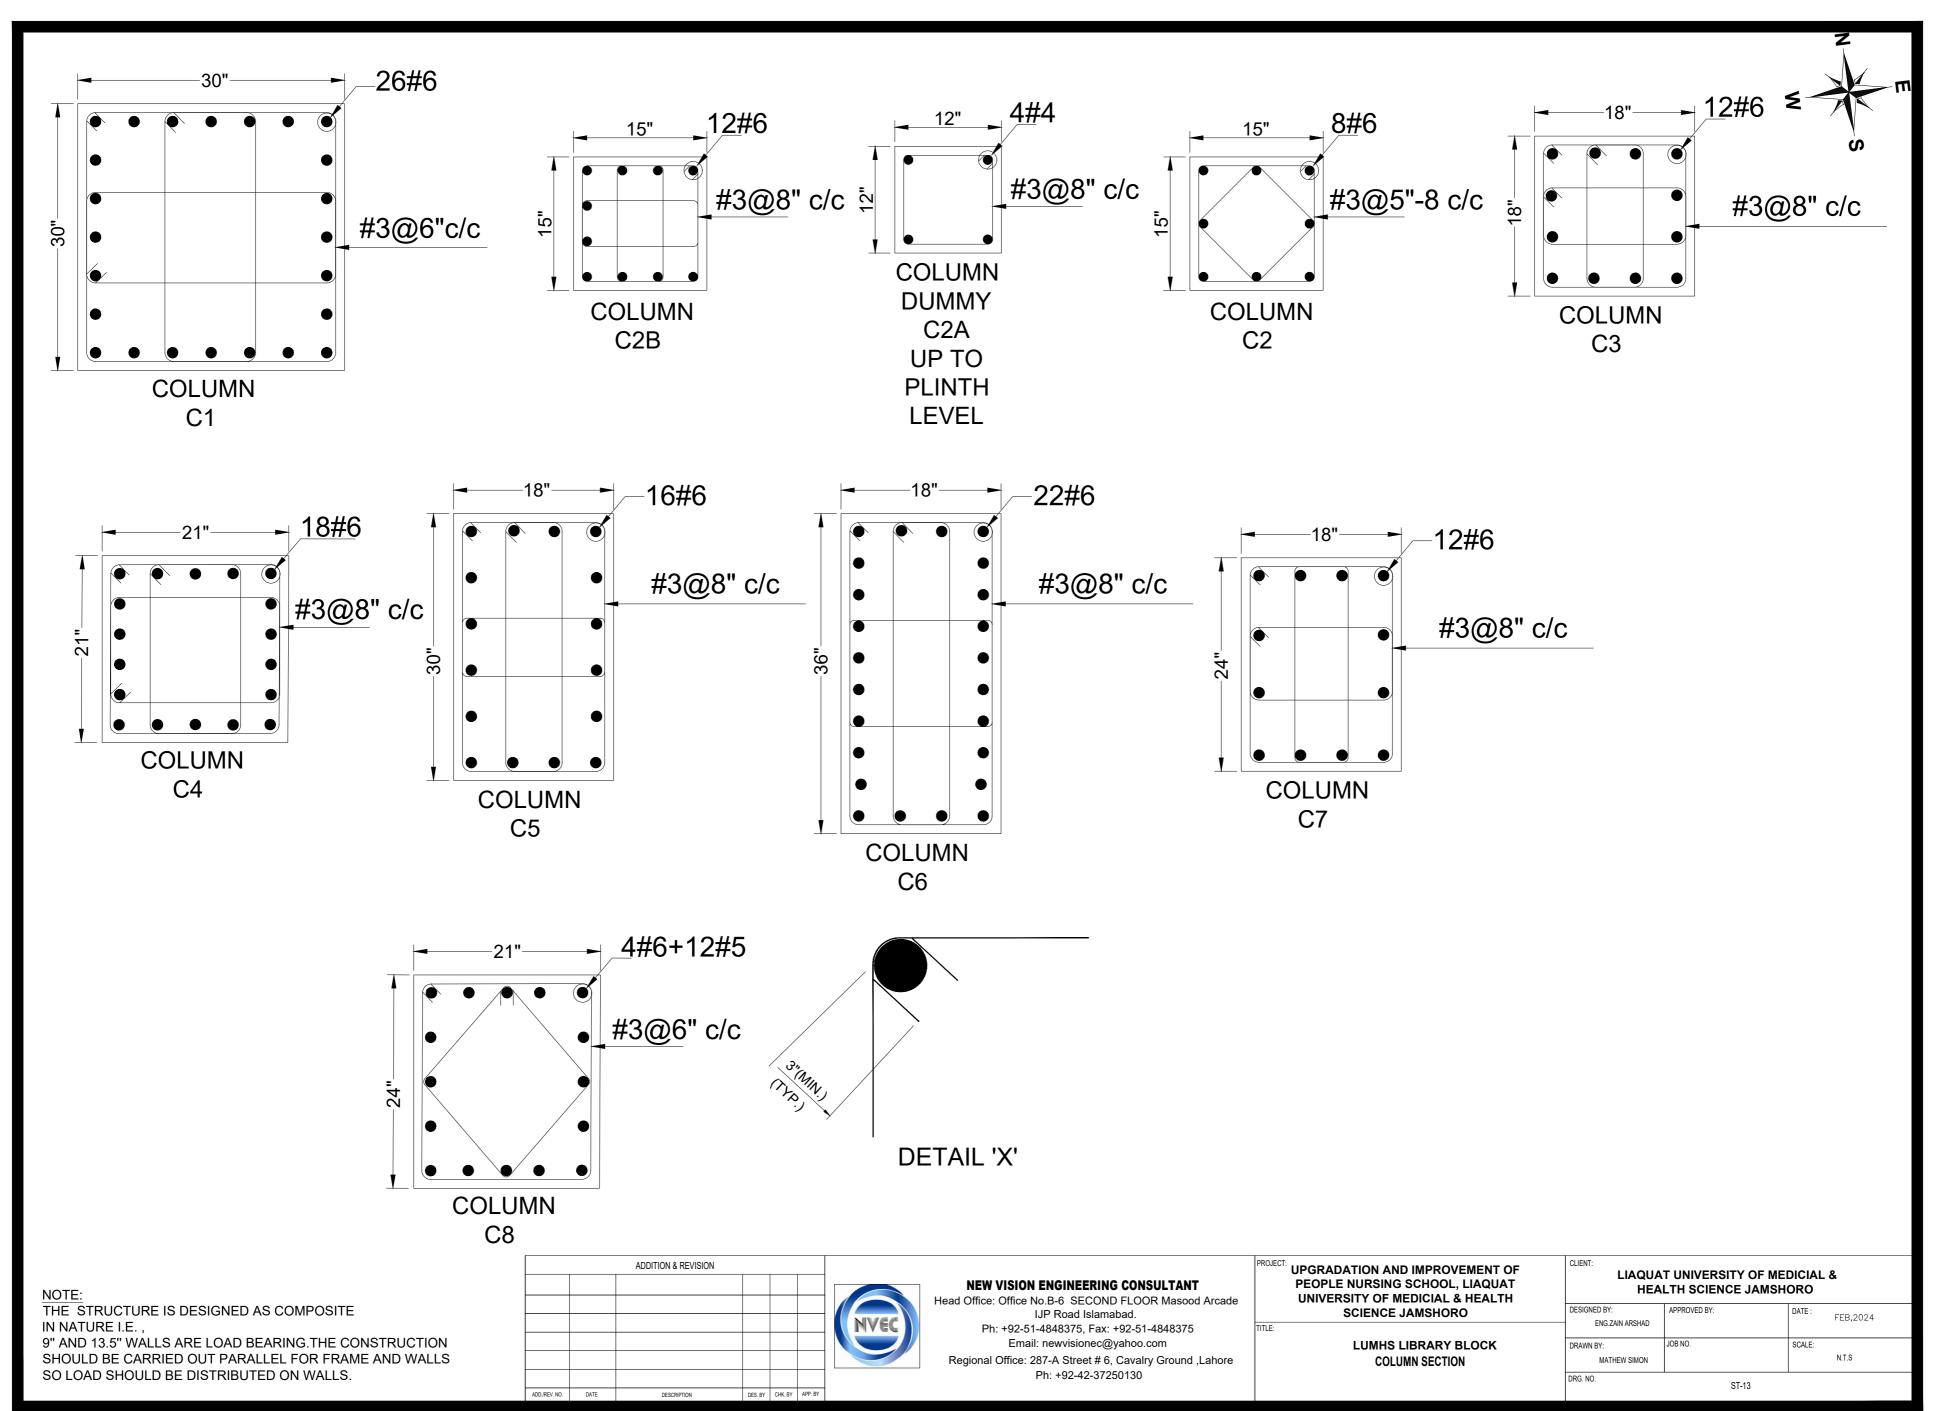

ENGINEERING CONSULTANT	PROJECT: UPGRADATION AND IMPROVEMENT OF PEOPLE NURSING SCHOOL, LIAQUAT UNIVERSITY OF MEDICIAL & HEALTH		AT UNIVERSITY OF ALTH SCIENCE JA	
P Road Islamabad. 1848375, Fax: +92-51-4848375	SCIENCE JAMSHORO	DESIGNED BY: ENG.ZAIN ARSHAD	APPROVED BY:	DATE : FEB,2024
newvisionec@yahoo.com 7-A Street # 6, Cavalry Ground ,Lahore	LUMHS LIBRARY BLOCK COLUMN SECTION	DRAWN BY: MATHEW SIMON	JOB NO.	SCALE: N.T.S
h: +92-42-37250130		DRG. NO.	ST-13	i



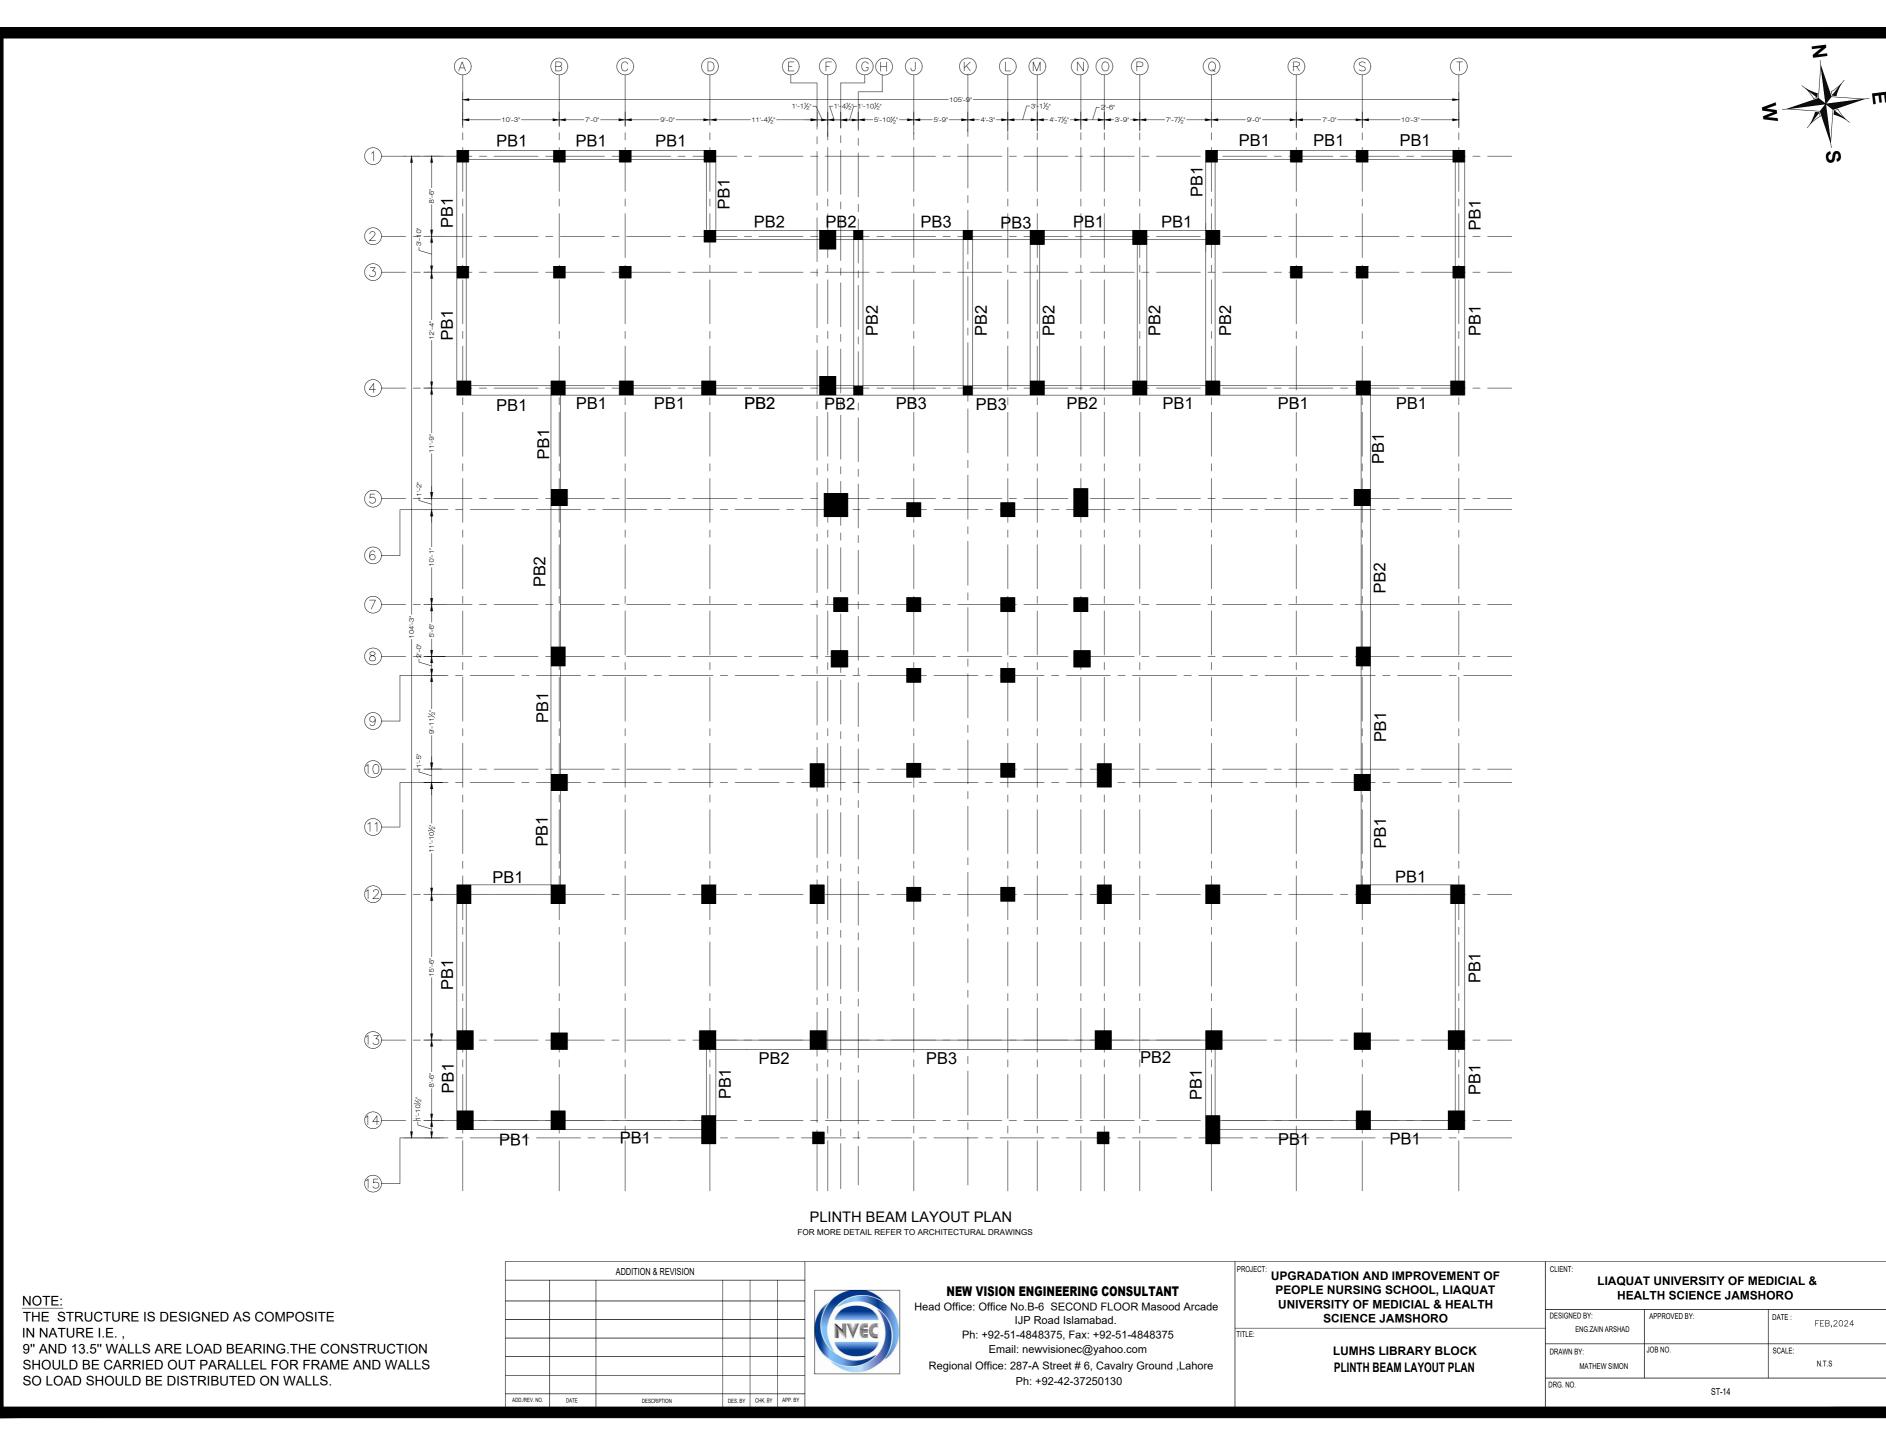

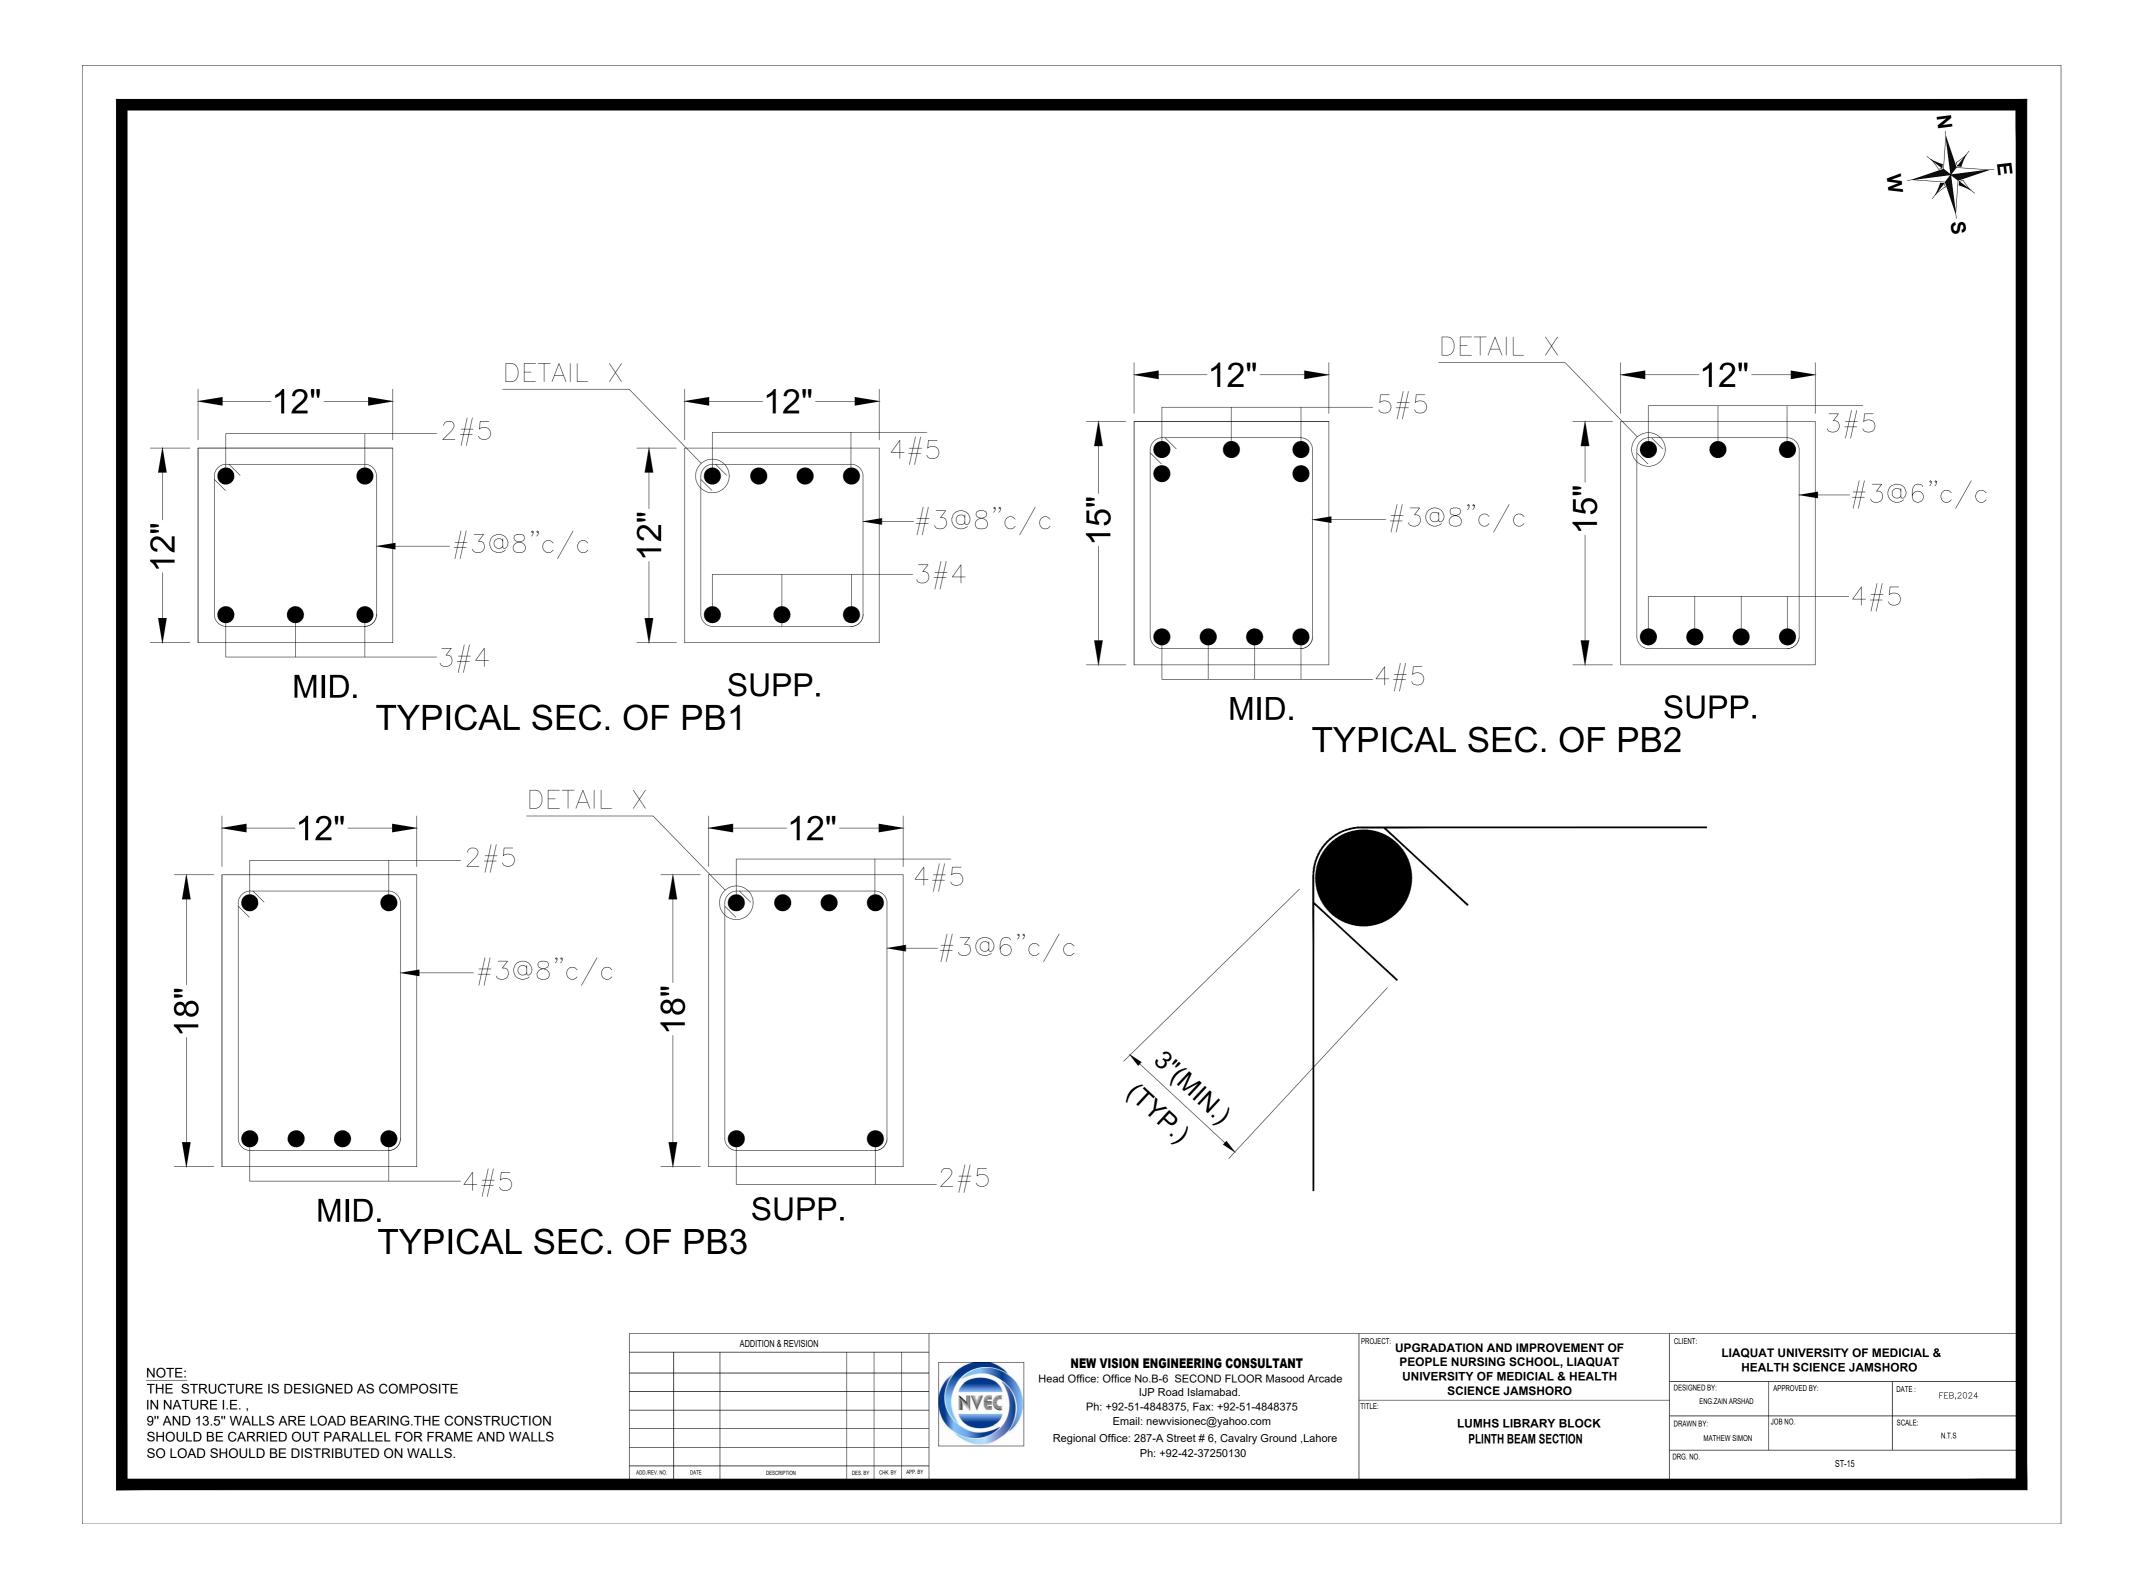

ADDITION & REVISION NEW VISION ENGINEERING CONSULTANT Head Office: Office No.B-6 SECOND FLOOR Masood Arcade THE STRUCTURE IS DESIGNED AS COMPOSITE IJP Road Islamabad. NVEC Ph: +92-51-4848375, Fax: +92-51-4848375 9" AND 13.5" WALLS ARE LOAD BEARING.THE CONSTRUCTION Email: newvisionec@yahoo.com SHOULD BE CARRIED OUT PARALLEL FOR FRAME AND WALLS Regional Office: 287-A Street # 6, Cavalry Ground ,Lahore Ph: +92-42-37250130 ADD./REV. NO. DES. BY CHK. BY APP. BY DATE DESCRIPTION

NOTE:

IN NATURE I.E.,


SO LOAD SHOULD BE DISTRIBUTED ON WALLS.


PROJECT: UPGRADATION AND IMPROVEMENT OF PEOPLE NURSING SCHOOL, LIAQUAT UNIVERSITY OF MEDICIAL & HEALTH SCIENCE JAMSHORO

TITLE:

LUMHS LIBRARY BLOCK GROUND FLOOR BEAM LAYOUT PLAN


	T UNIVERSITY OF MEI		&
DESIGNED BY: ENG.ZAIN ARSHAD	APPROVED BY:	DATE :	FEB,2024
DRAWN BY: MATHEW SIMON	JOB NO.	SCALE:	N.T.S
DRG. NO.	ST-16		

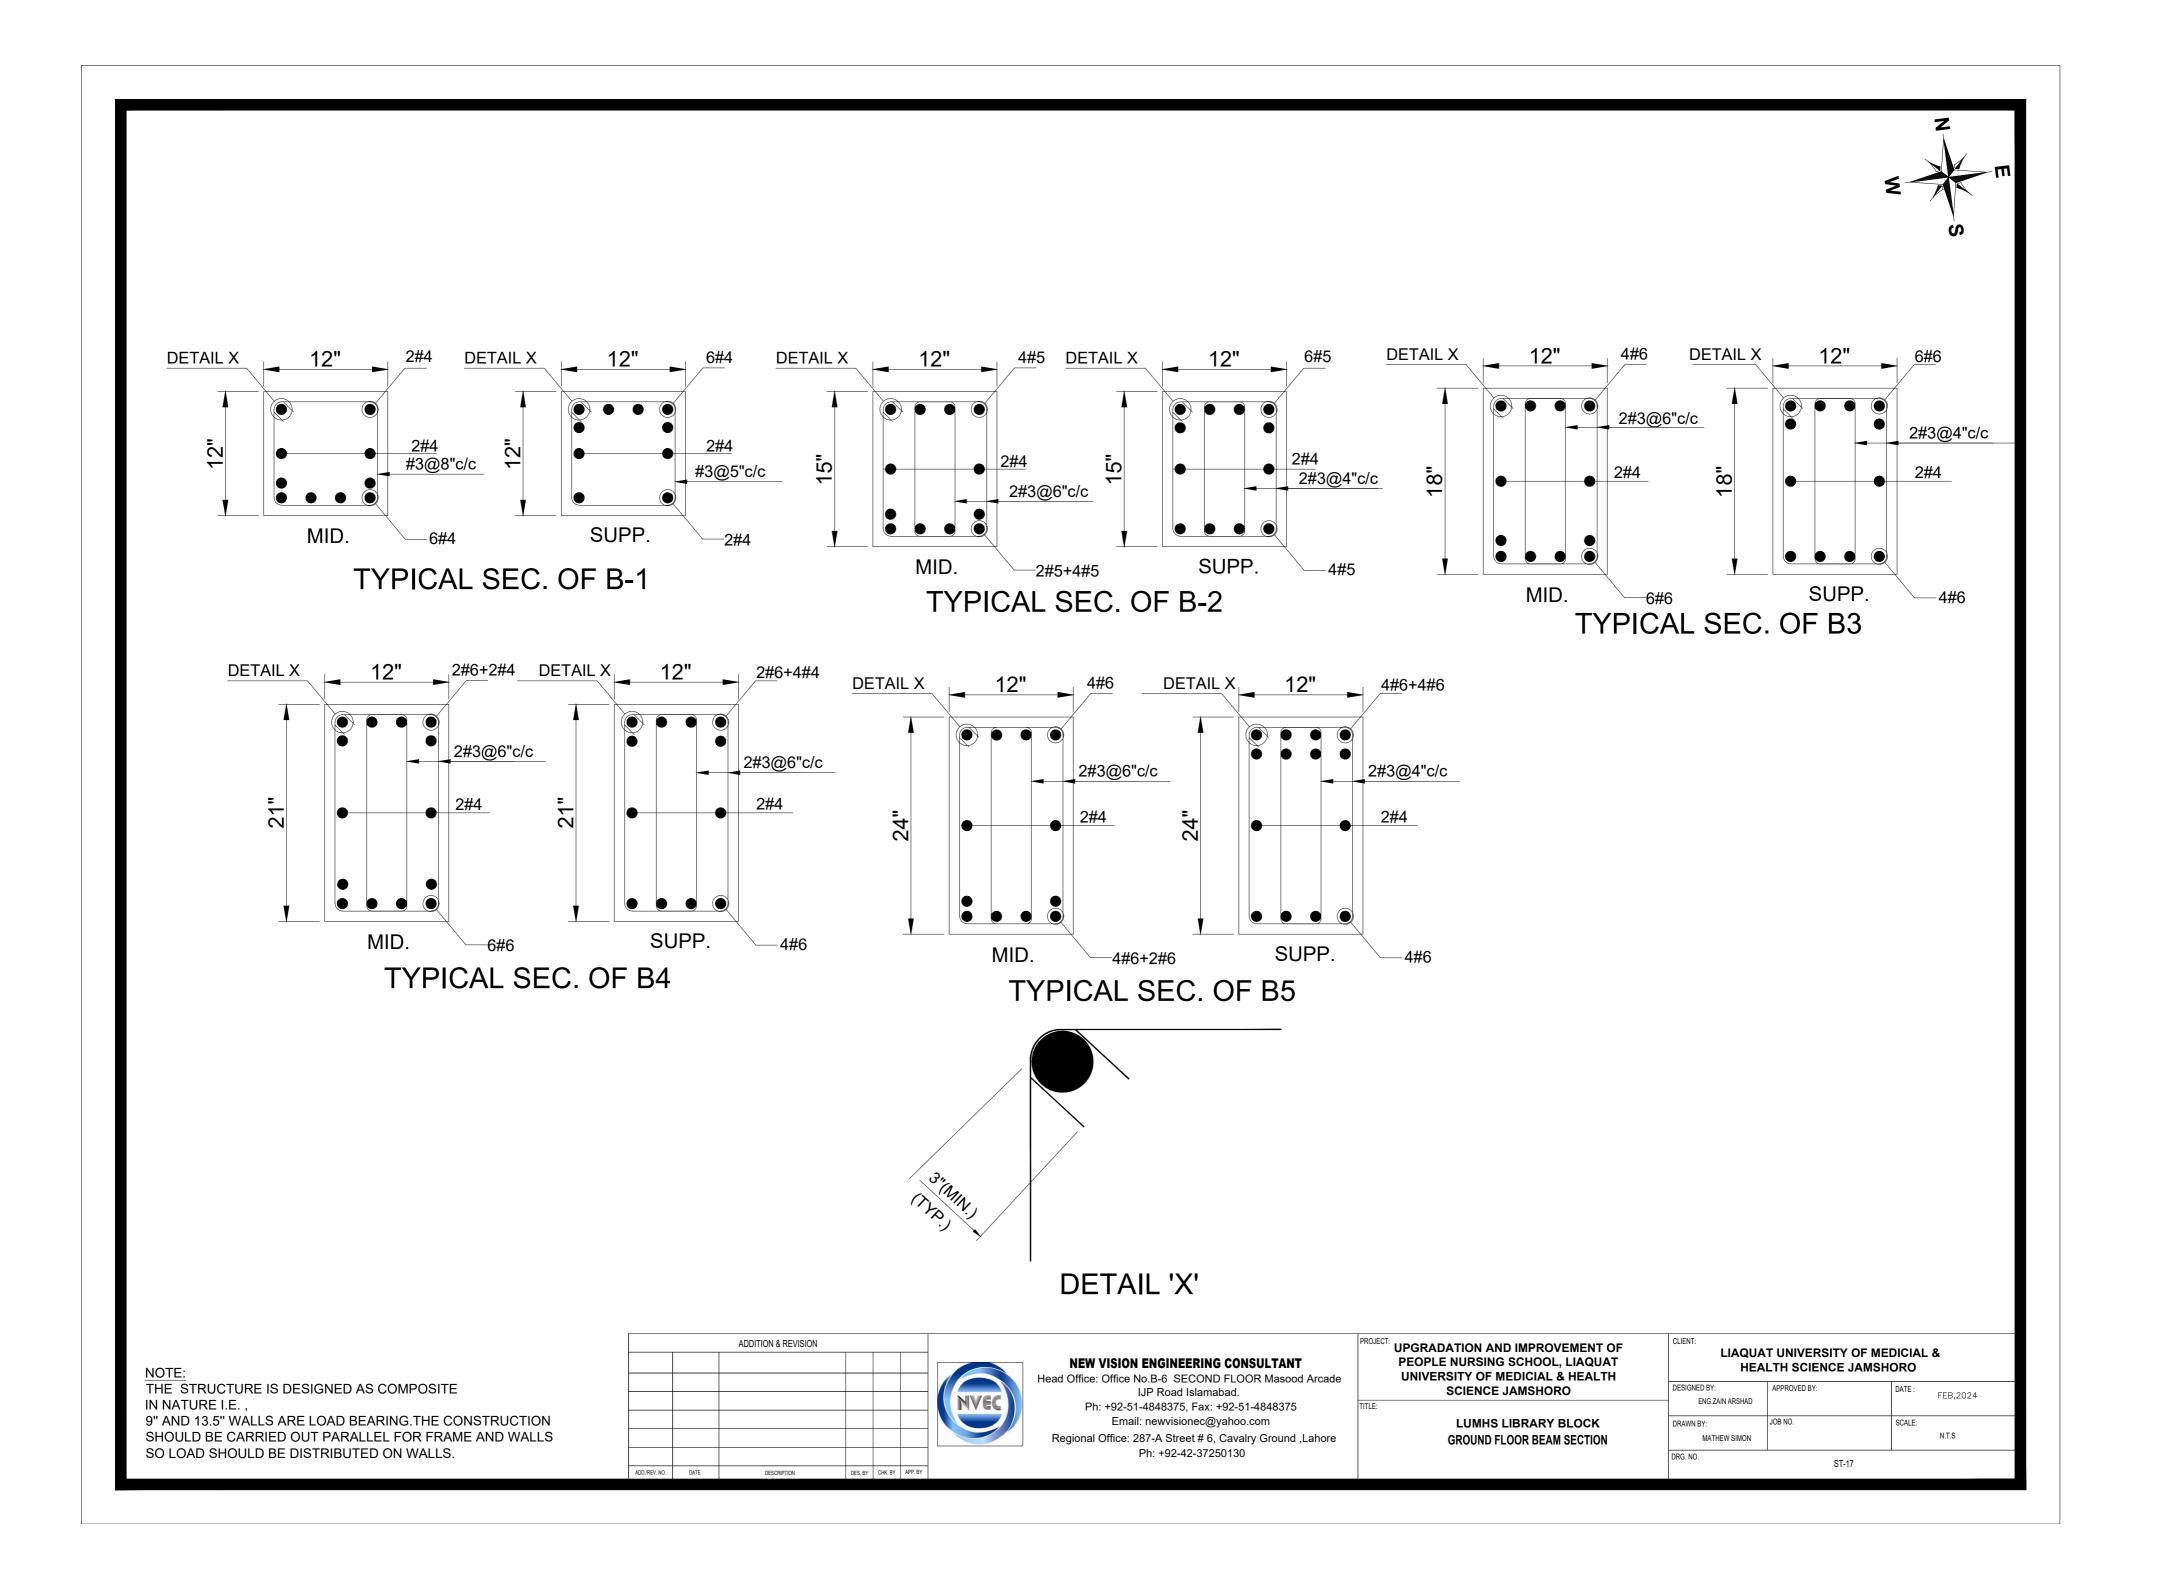


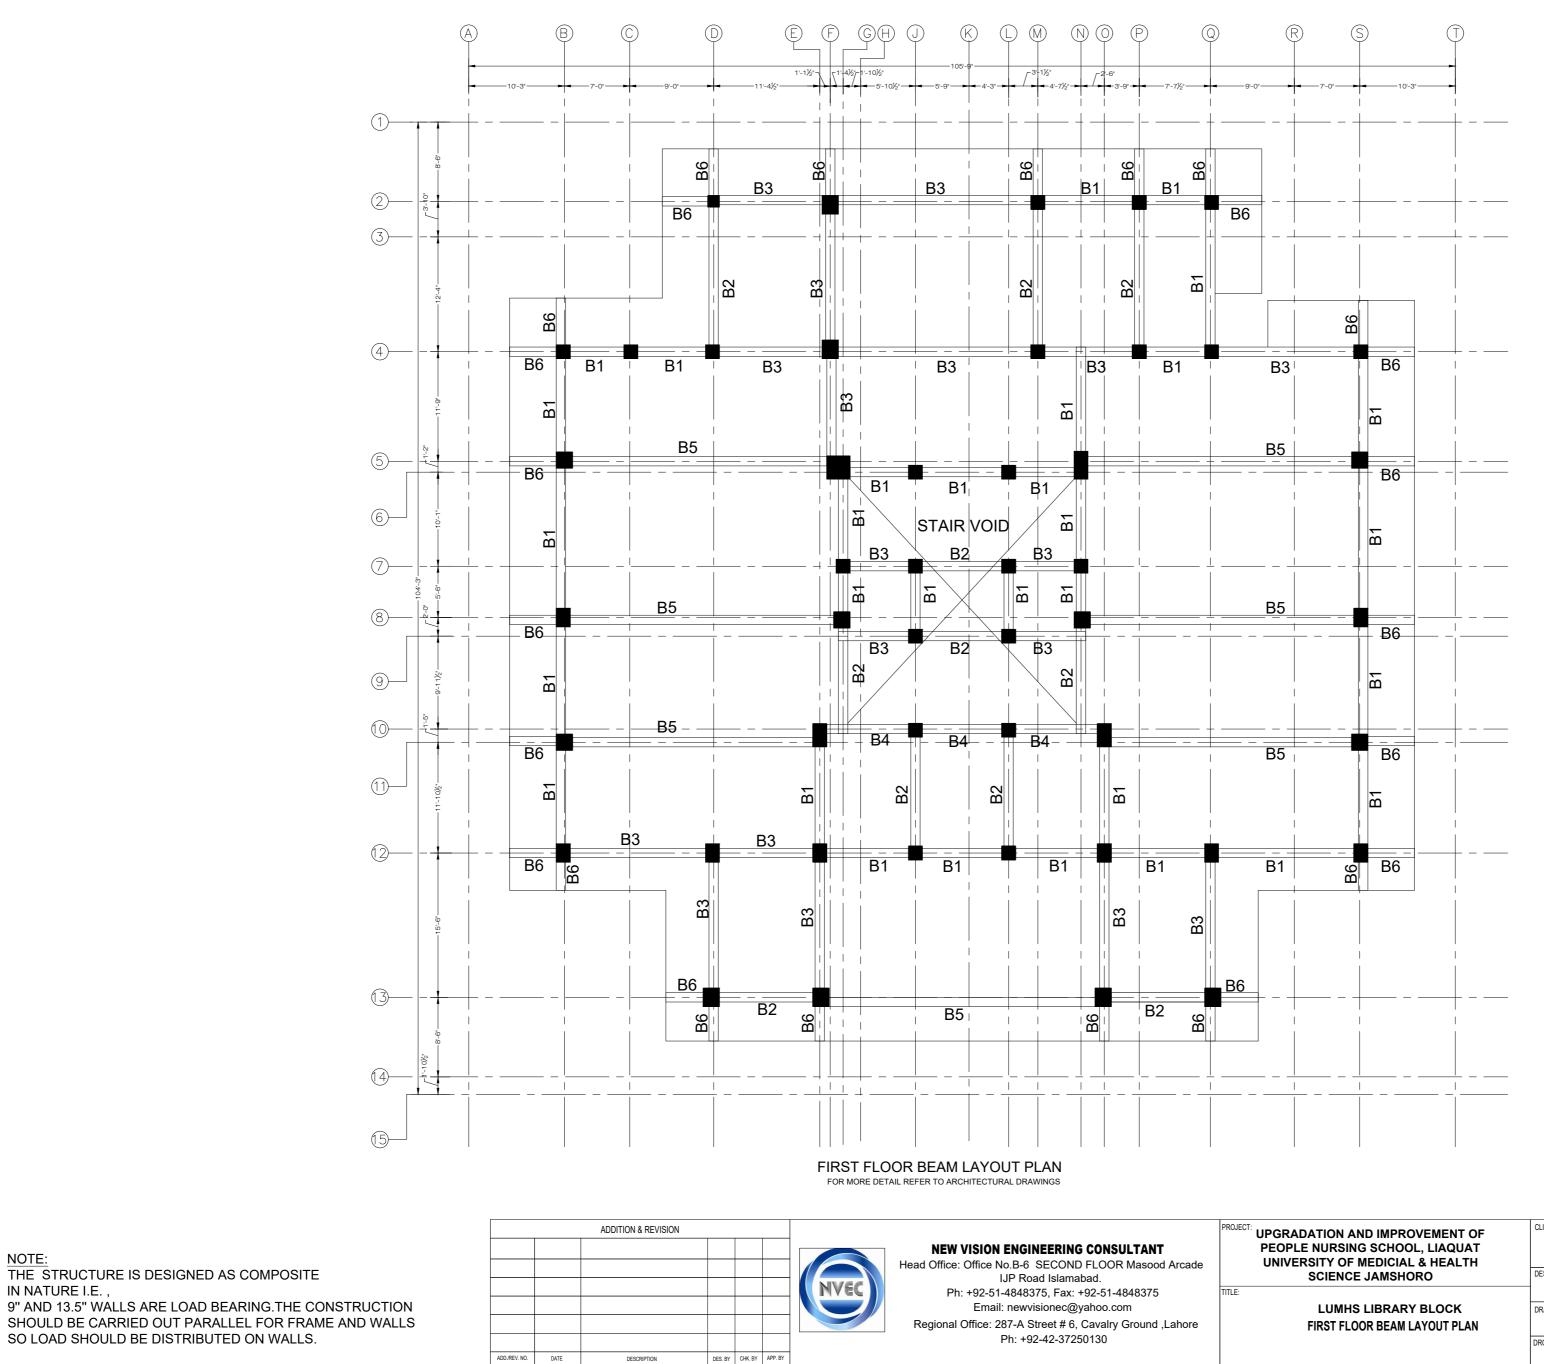



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DESIGNED BY: ENG.ZAIN ARSHAD	APPROVED BY:	DATE :	FEB,2024
DRAWN BY: MATHEW SIMON	JOB NO.	SCALE:	N.T.S
DRG. NO.	ST-18		



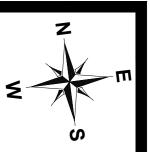

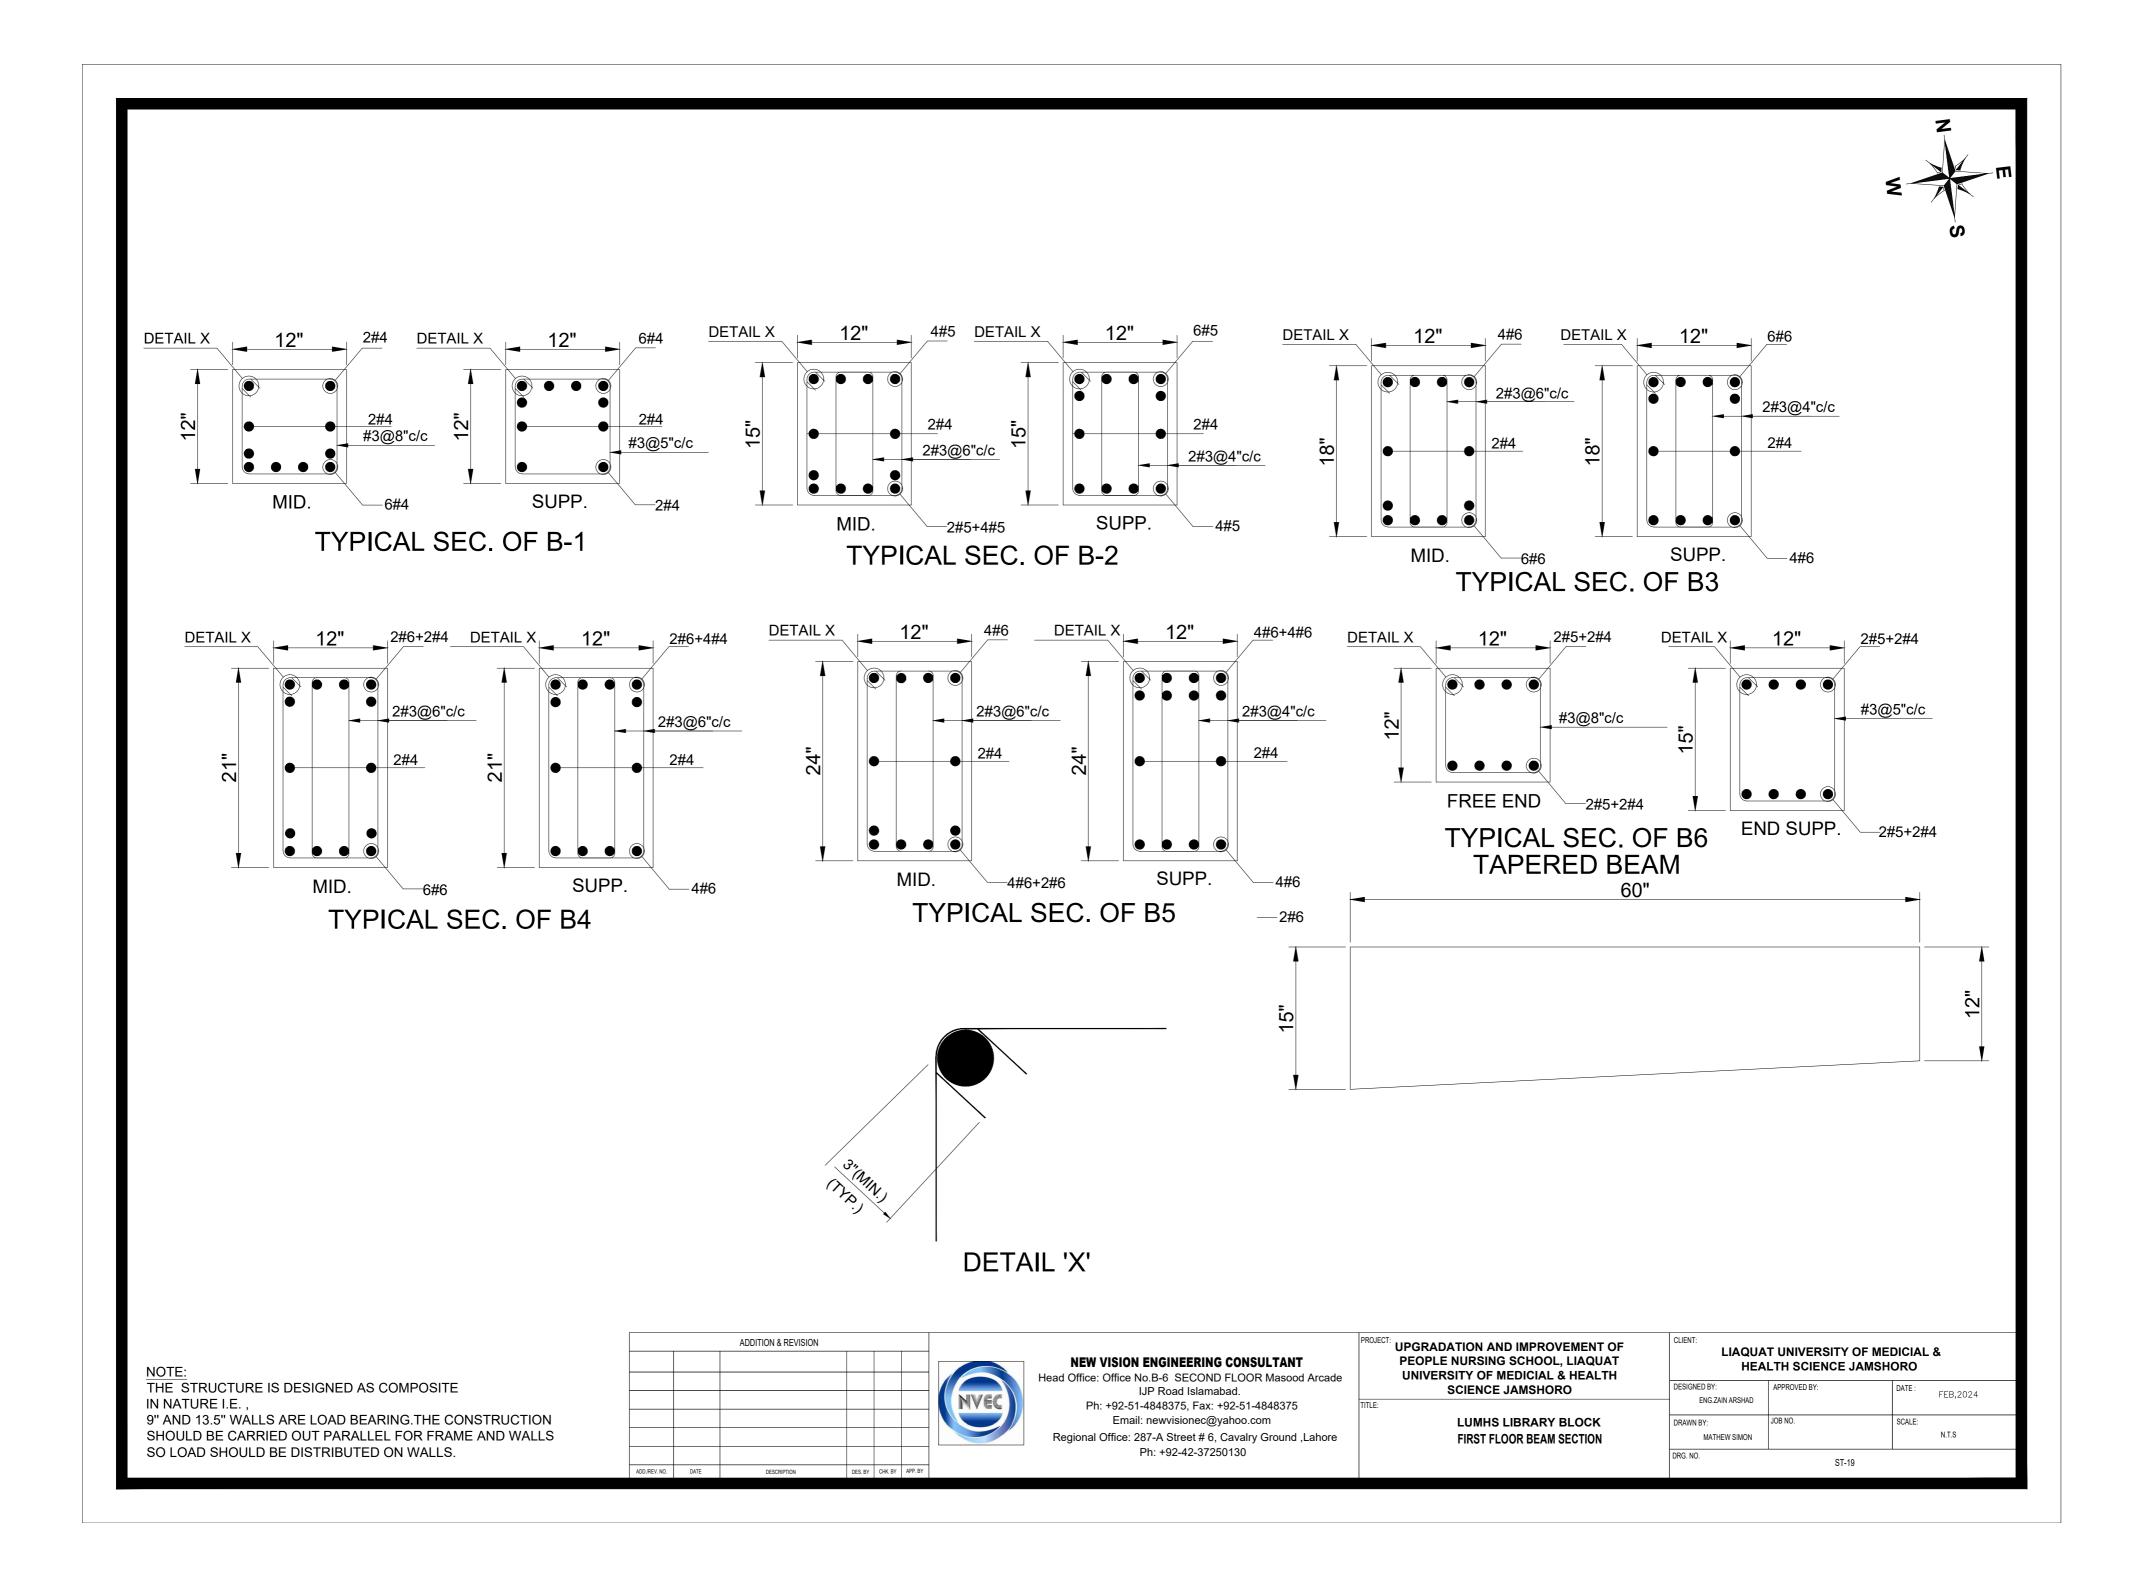

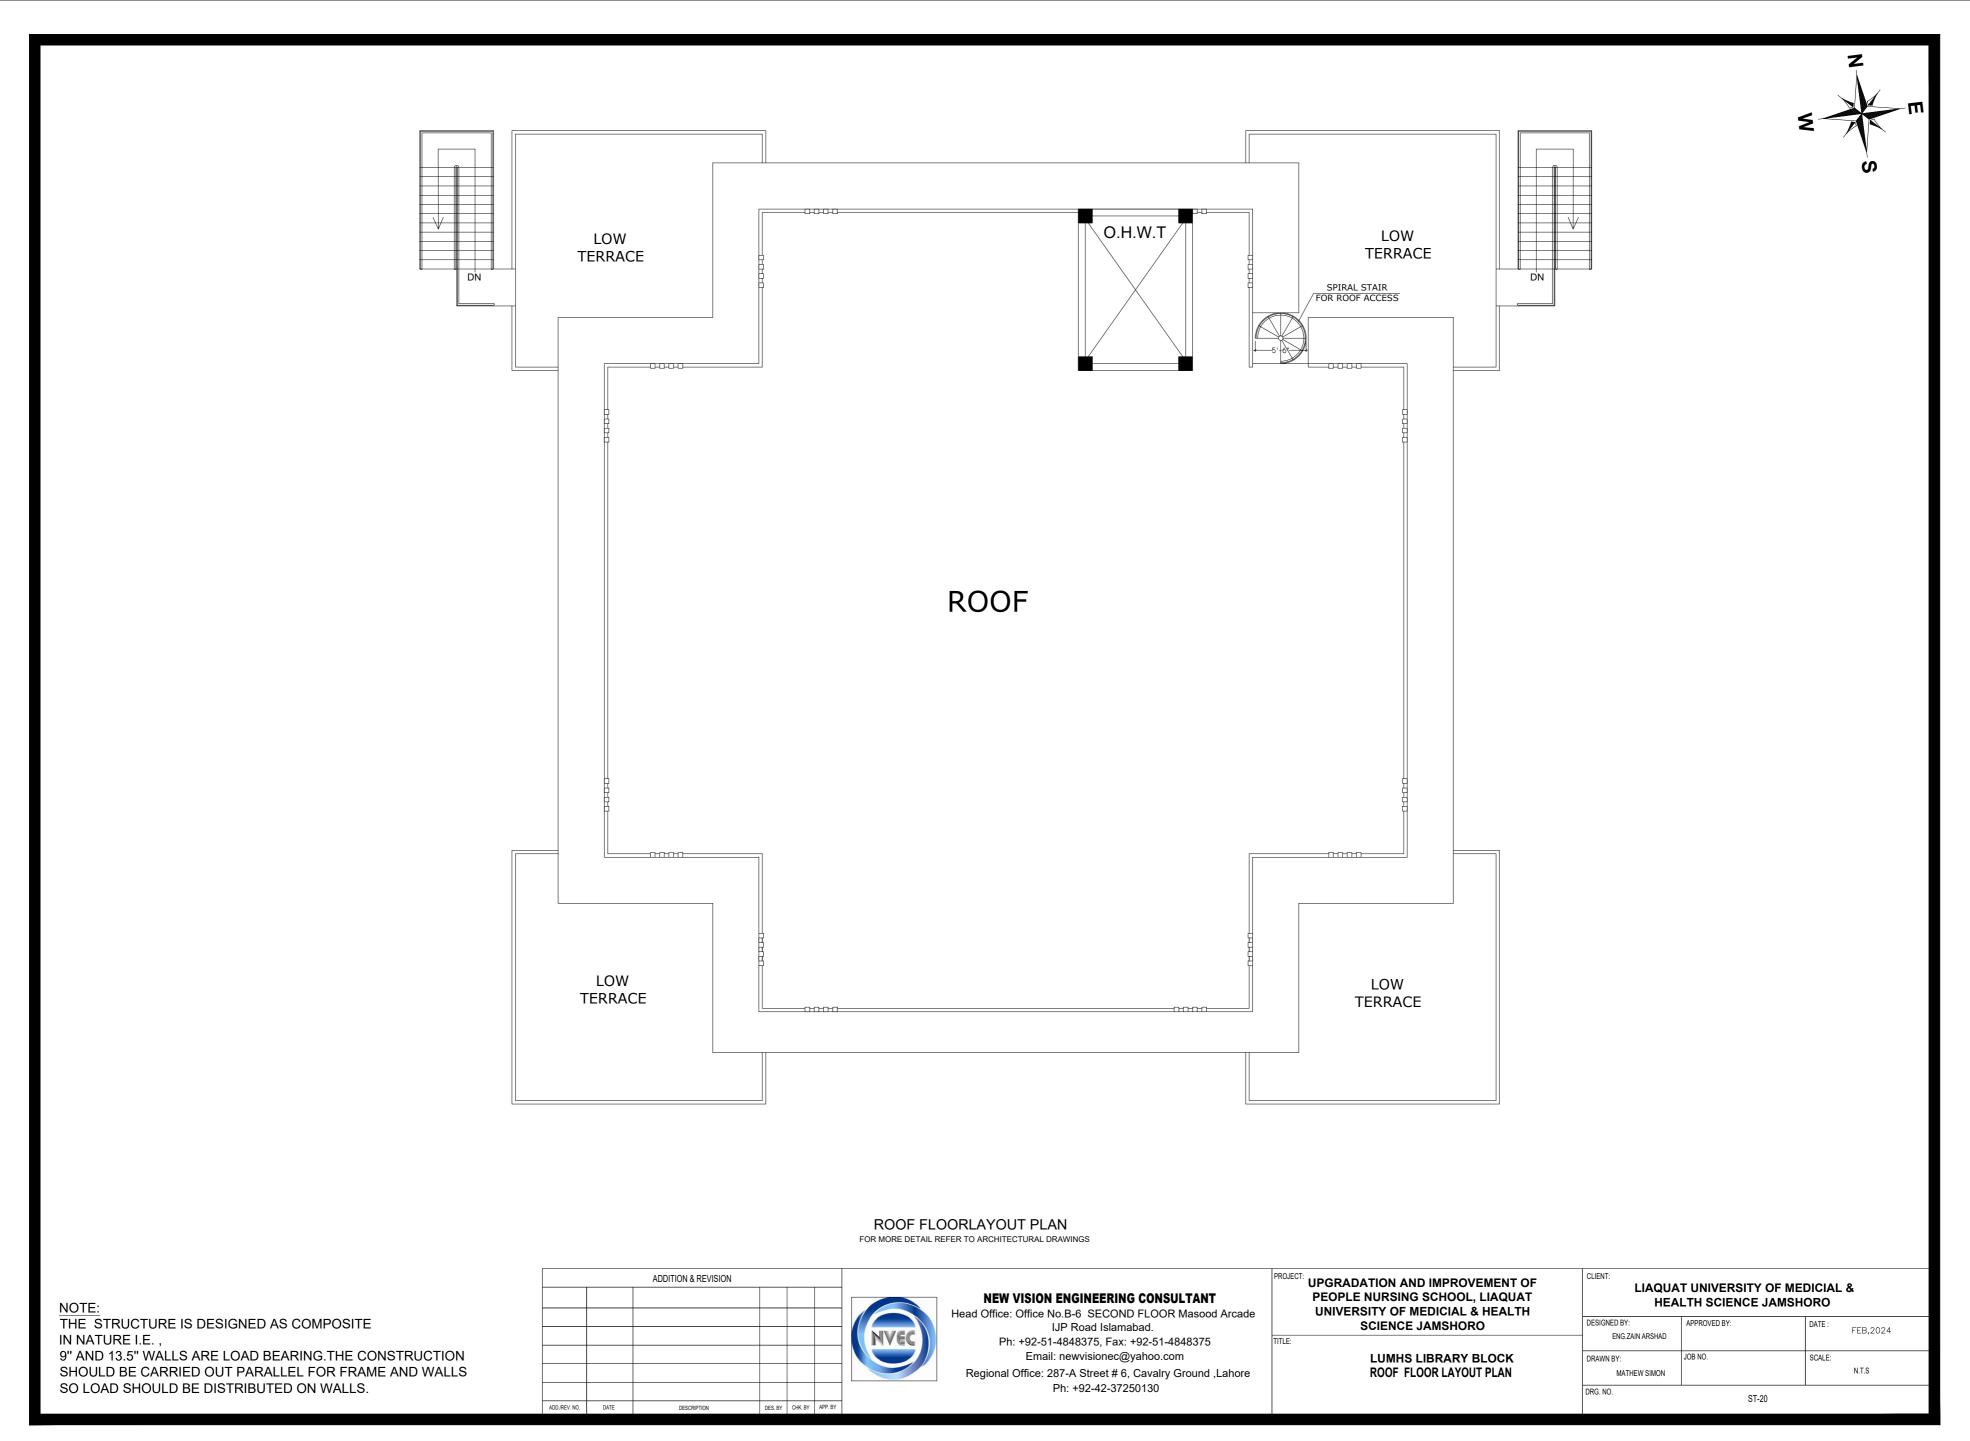

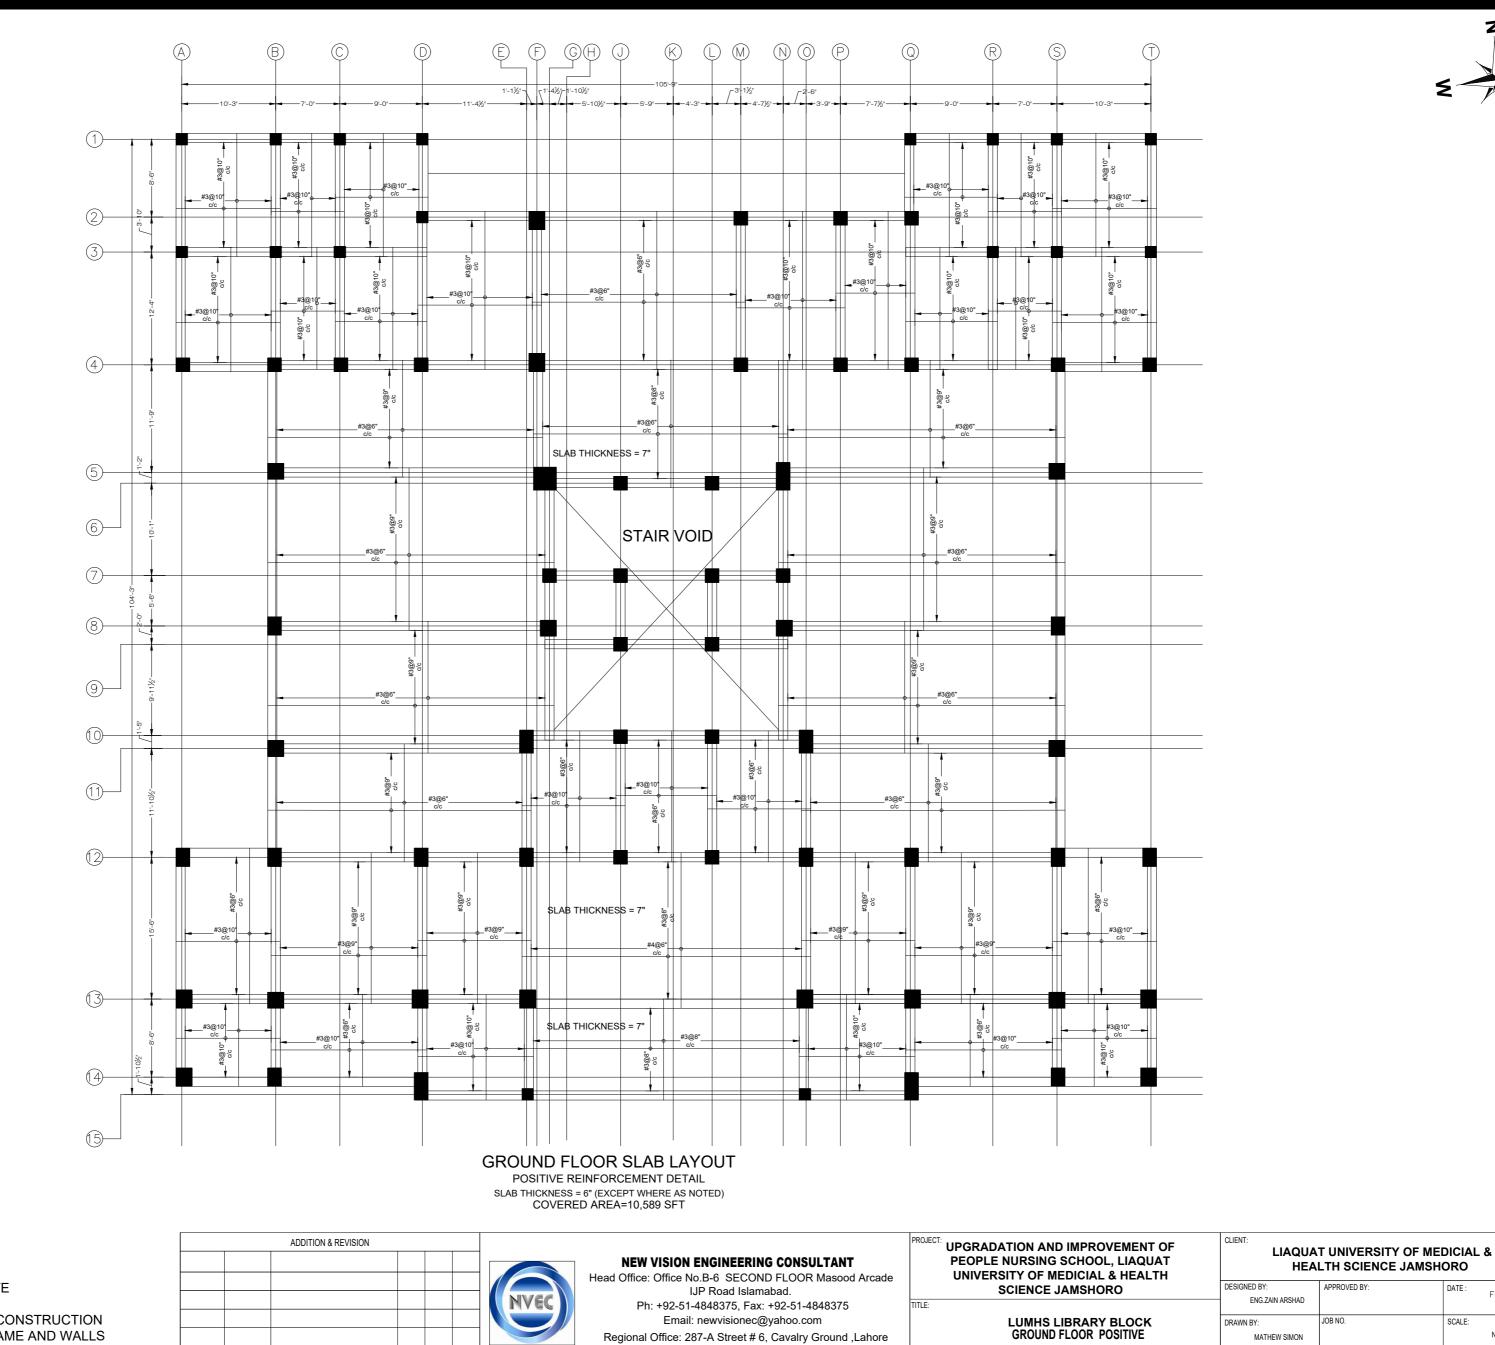Ph: +92-42-37250130

NOTE:

THE STRUCTURE IS DESIGNED AS COMPOSITE IN NATURE I.E., 9" AND 13.5" WALLS ARE LOAD BEARING. THE CONSTRUCTION

SHOULD BE CARRIED OUT PARALLEL FOR FRAME AND WALLS SO LOAD SHOULD BE DISTRIBUTED ON WALLS.

ADD./REV. NO.

DATE

DESCRIPTION


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LUMHS LIBRARY BLOCK GROUND FLOOR POSITIVE REINFORCEMENT PLAN

HEALTH SCIENCE JAMSHORO			
DESIGNED BY:	APPROVED BY:	DATE :	FED 0004
ENG.ZAIN ARSHAD			FEB,2024
DRAWN BY:	JOB NO.	SCALE:	
MATHEW SIMON			N.T.S
DPG NO	•		

ST-21



NOTE:

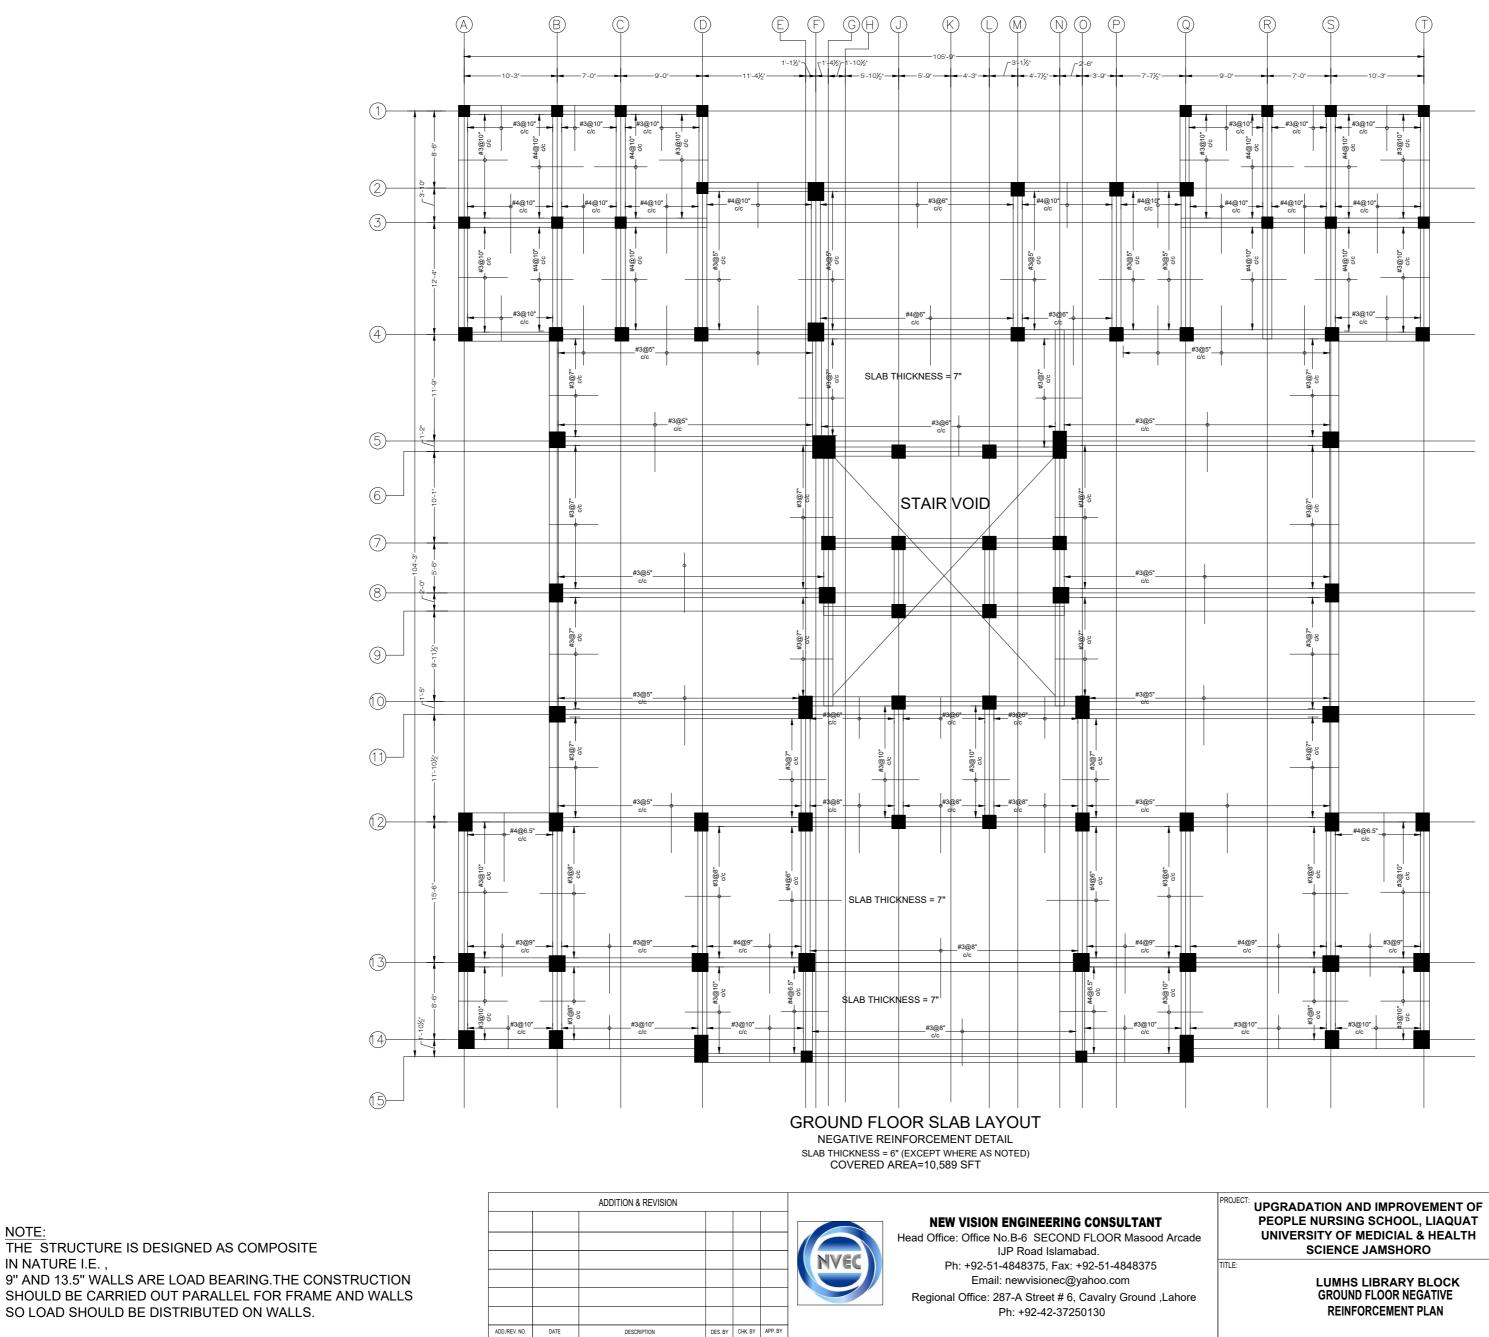IN NATURE I.E., 9" AND 13.5" WALLS ARE LOAD BEARING. THE CONSTRUCTION SHOULD BE CARRIED OUT PARALLEL FOR FRAME AND WALLS

PEOPLE NURSING SCHOOL, LIAQUAT UNIVERSITY OF MEDICIAL & HEALTH

	T UNIVERSITY OF MEI		&
DESIGNED BY: ENG.ZAIN ARSHAD	APPROVED BY:	DATE :	FEB,2024
DRAWN BY: MATHEW SIMON	JOB NO.	SCALE:	N.T.S


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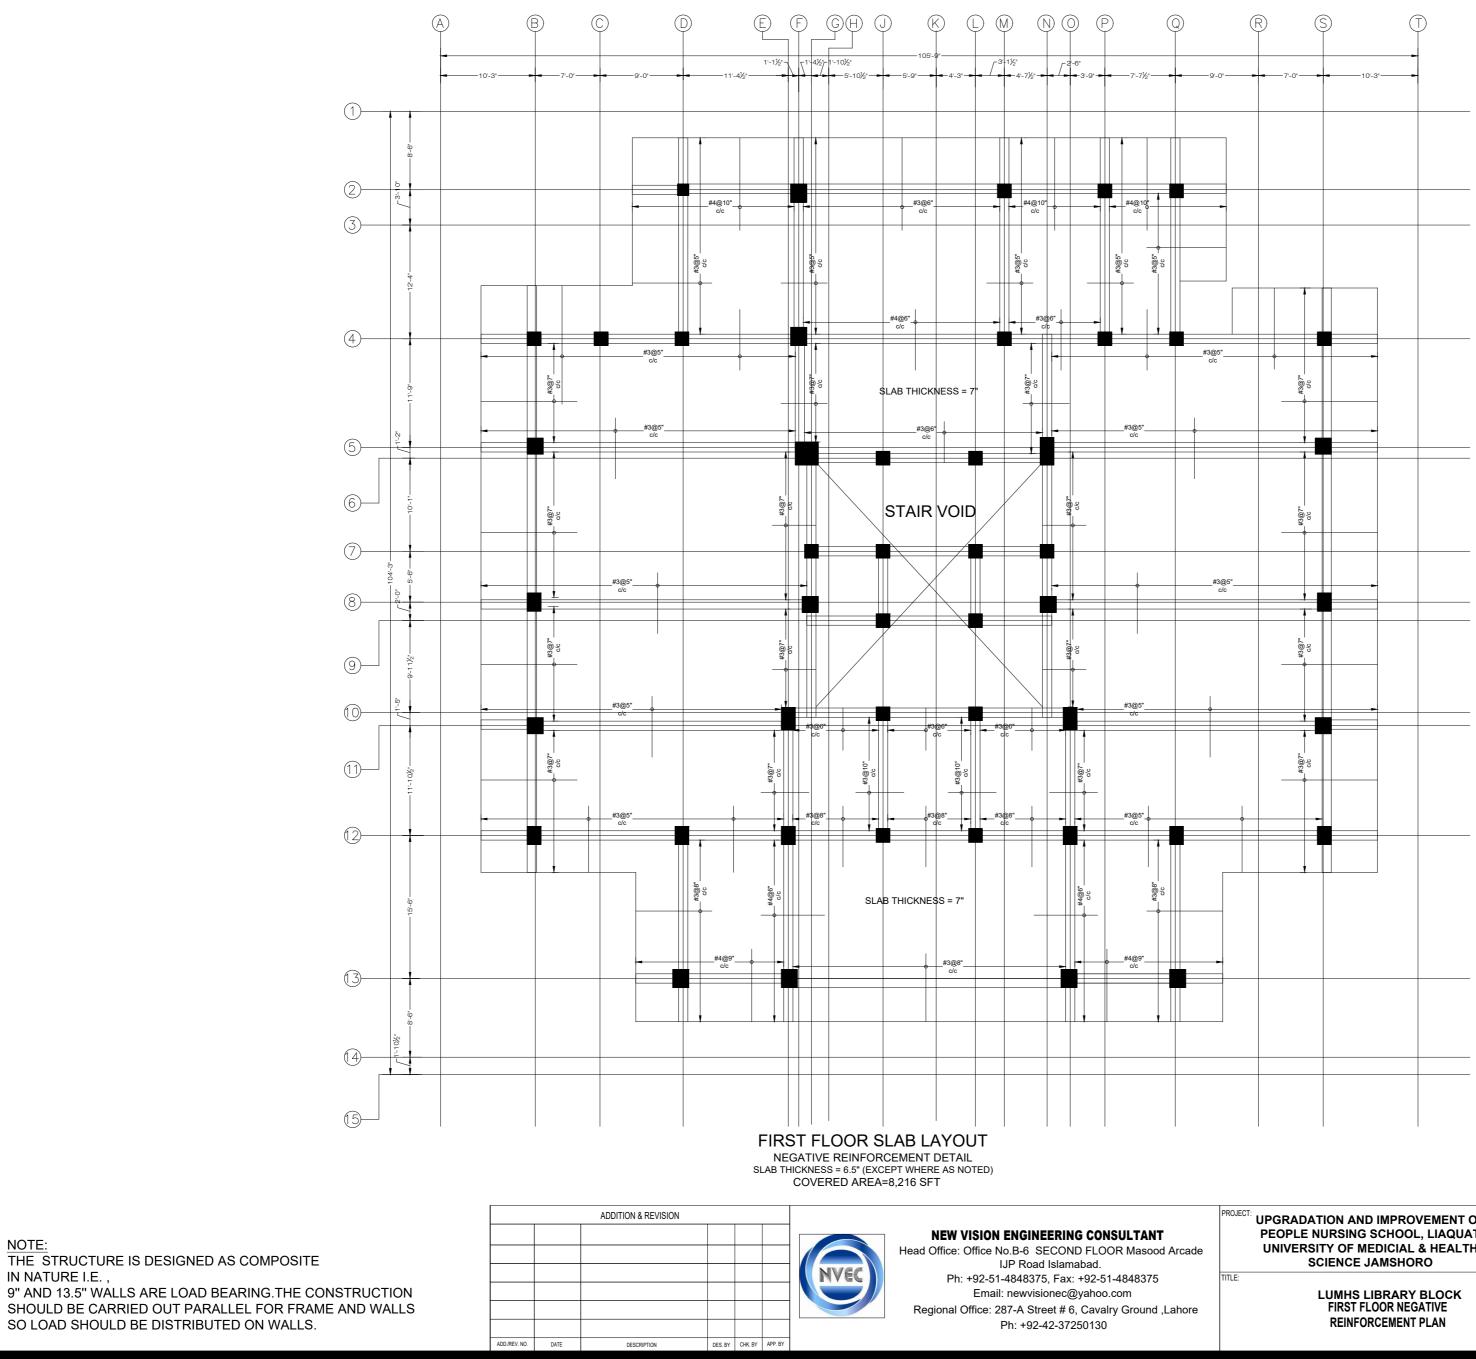


PEOPLE NURSING SCHOOL, LIAQUAT UNIVERSITY OF MEDICIAL & HEALTH

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DESIGNED BY:	APPROVED BY:	DATE :	FEB.2024
ENG.ZAIN ARSHAD			120,2021
DRAWN BY:	JOB NO.	SCALE:	
MATHEW SIMON			N.T.S
DRG. NO.	ST-23		

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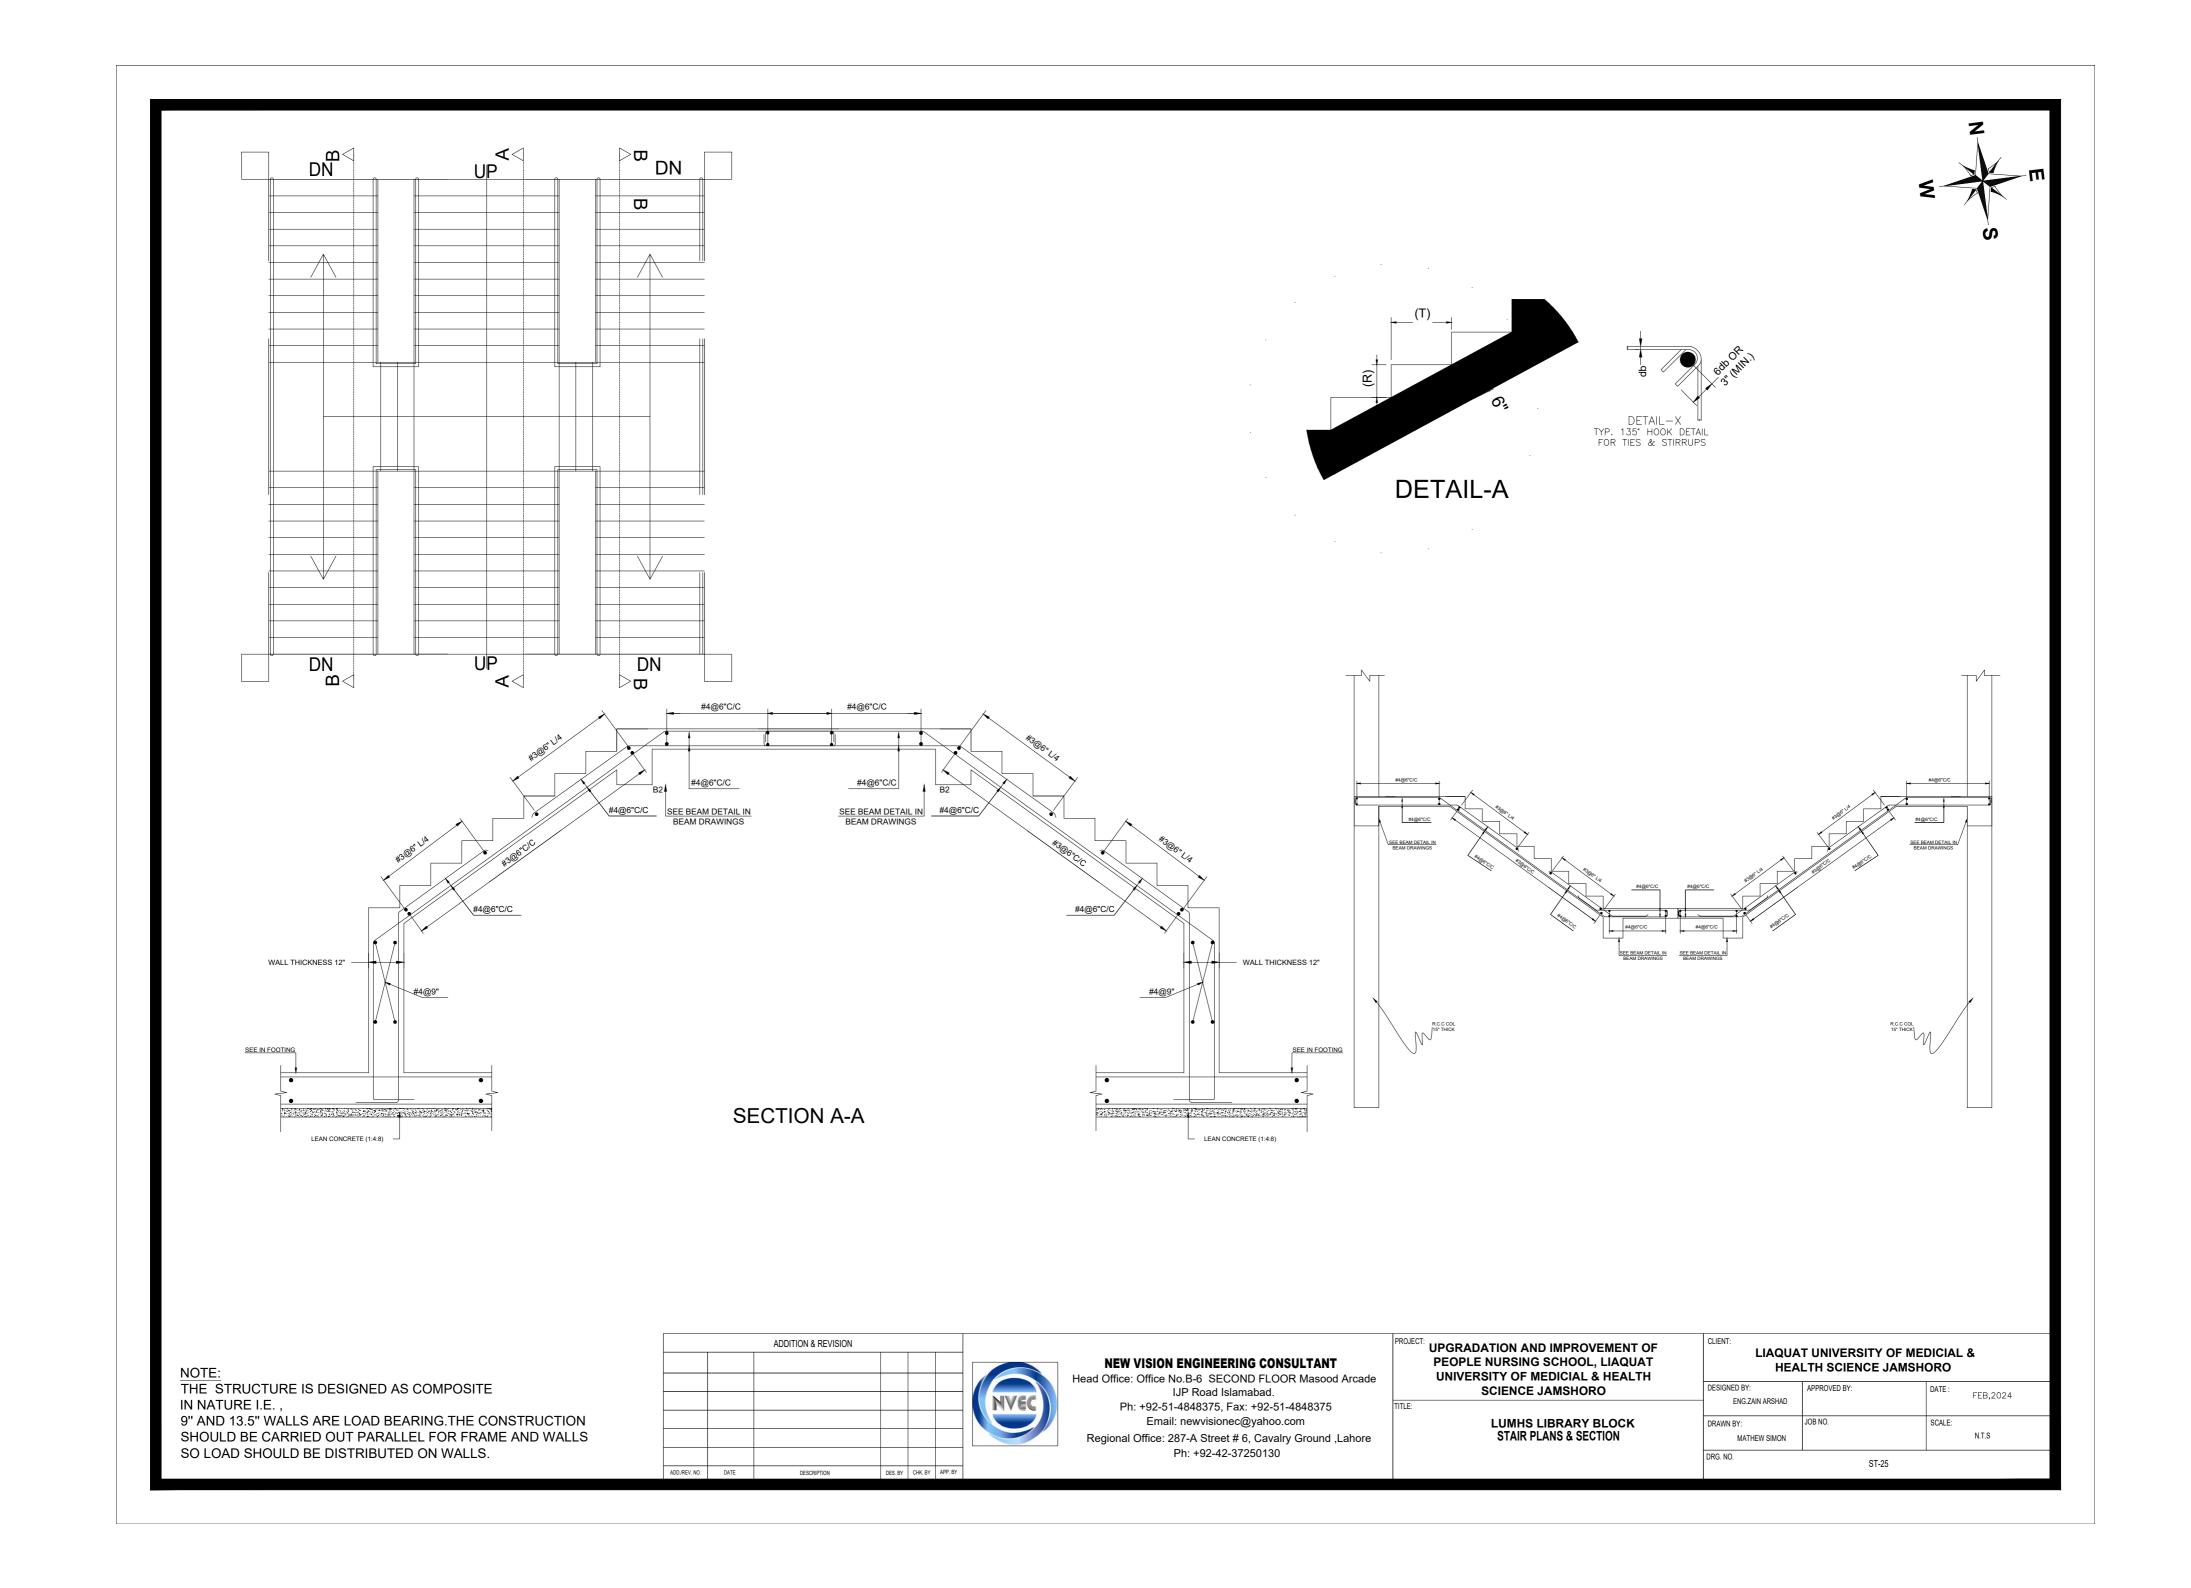
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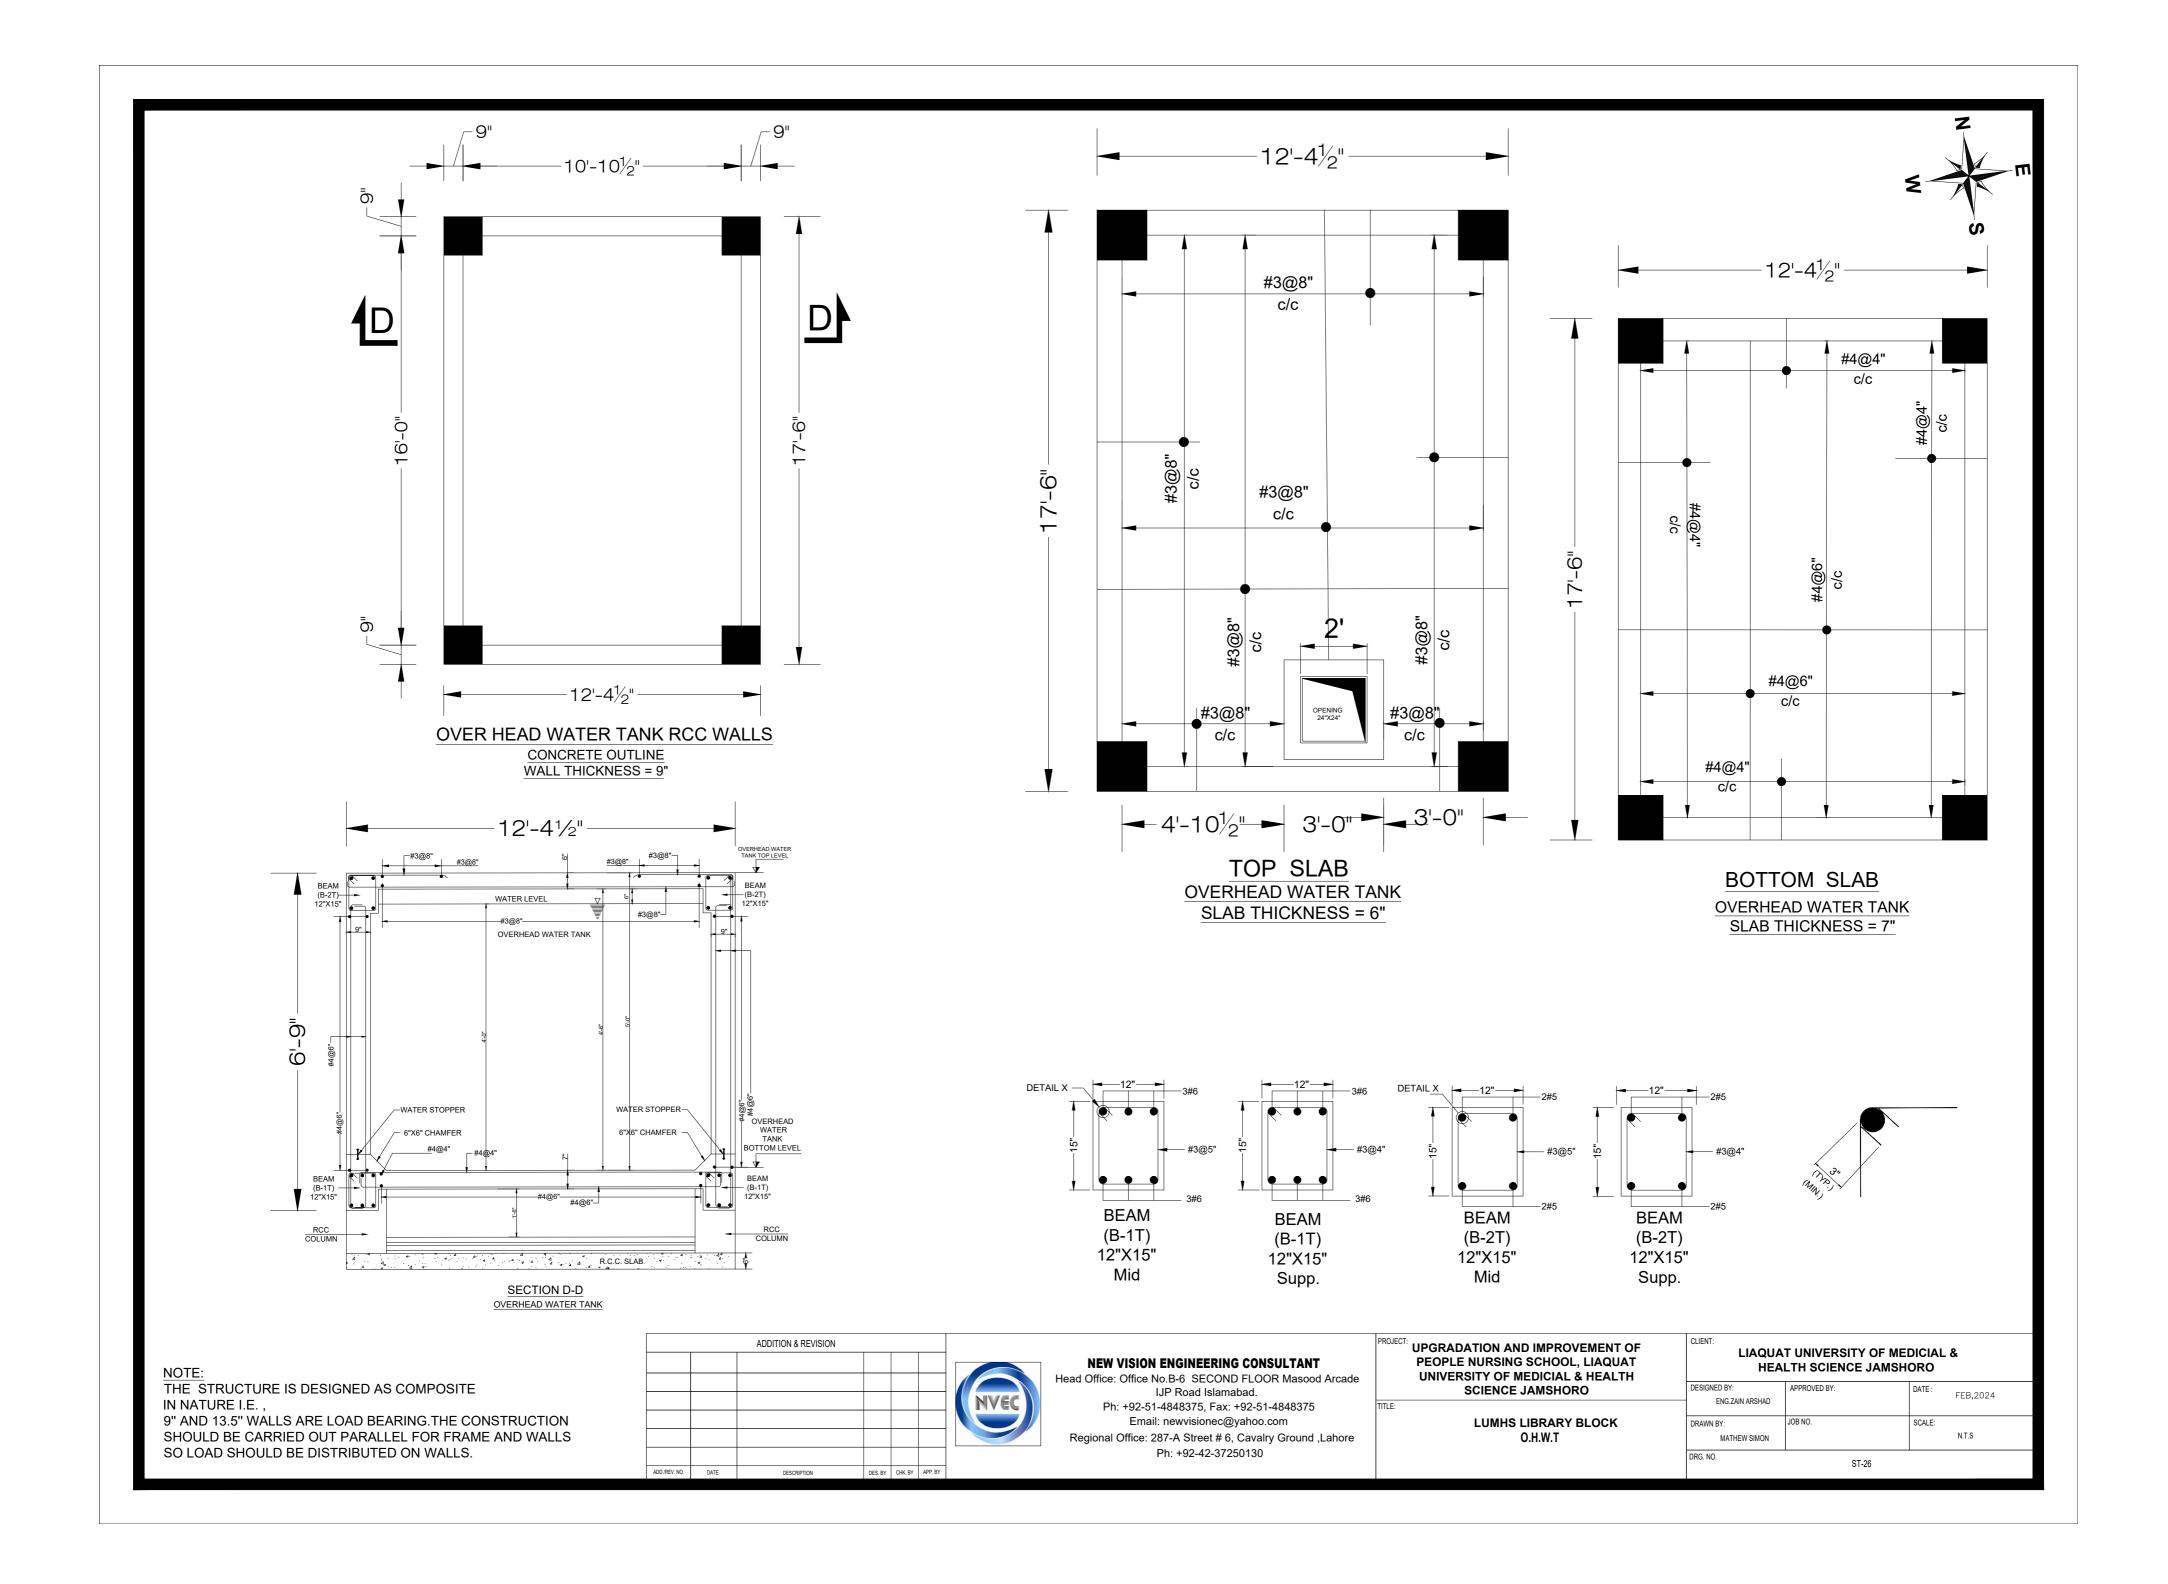
CONSULTANT	PROJECT: UPGRADATION AND IMPROVEMENT OF PEOPLE NURSING SCHOOL, LIAQUAT UNIVERSITY OF MEDICIAL & HEALTH		T UNIV
ad.	SCIENCE JAMSHORO	DESIGNED BY:	APPROVE
2-51-4848375	TITLE:	ENG.ZAIN ARSHAD	
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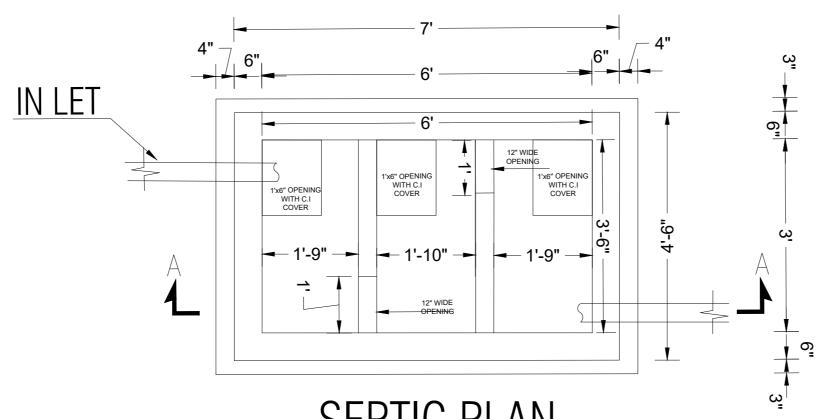
	LIAQUAT UNIVERSITY OF MEDICIAL & HEALTH SCIENCE JAMSHORO			
DESIGNED BY: ENG.ZAIN ARSHAD	APPROVED BY:	DATE :	FEB,2024	
DRAWN BY: MATHEW SIMON	JOB NO.	SCALE:	N.T.S	

ST-24

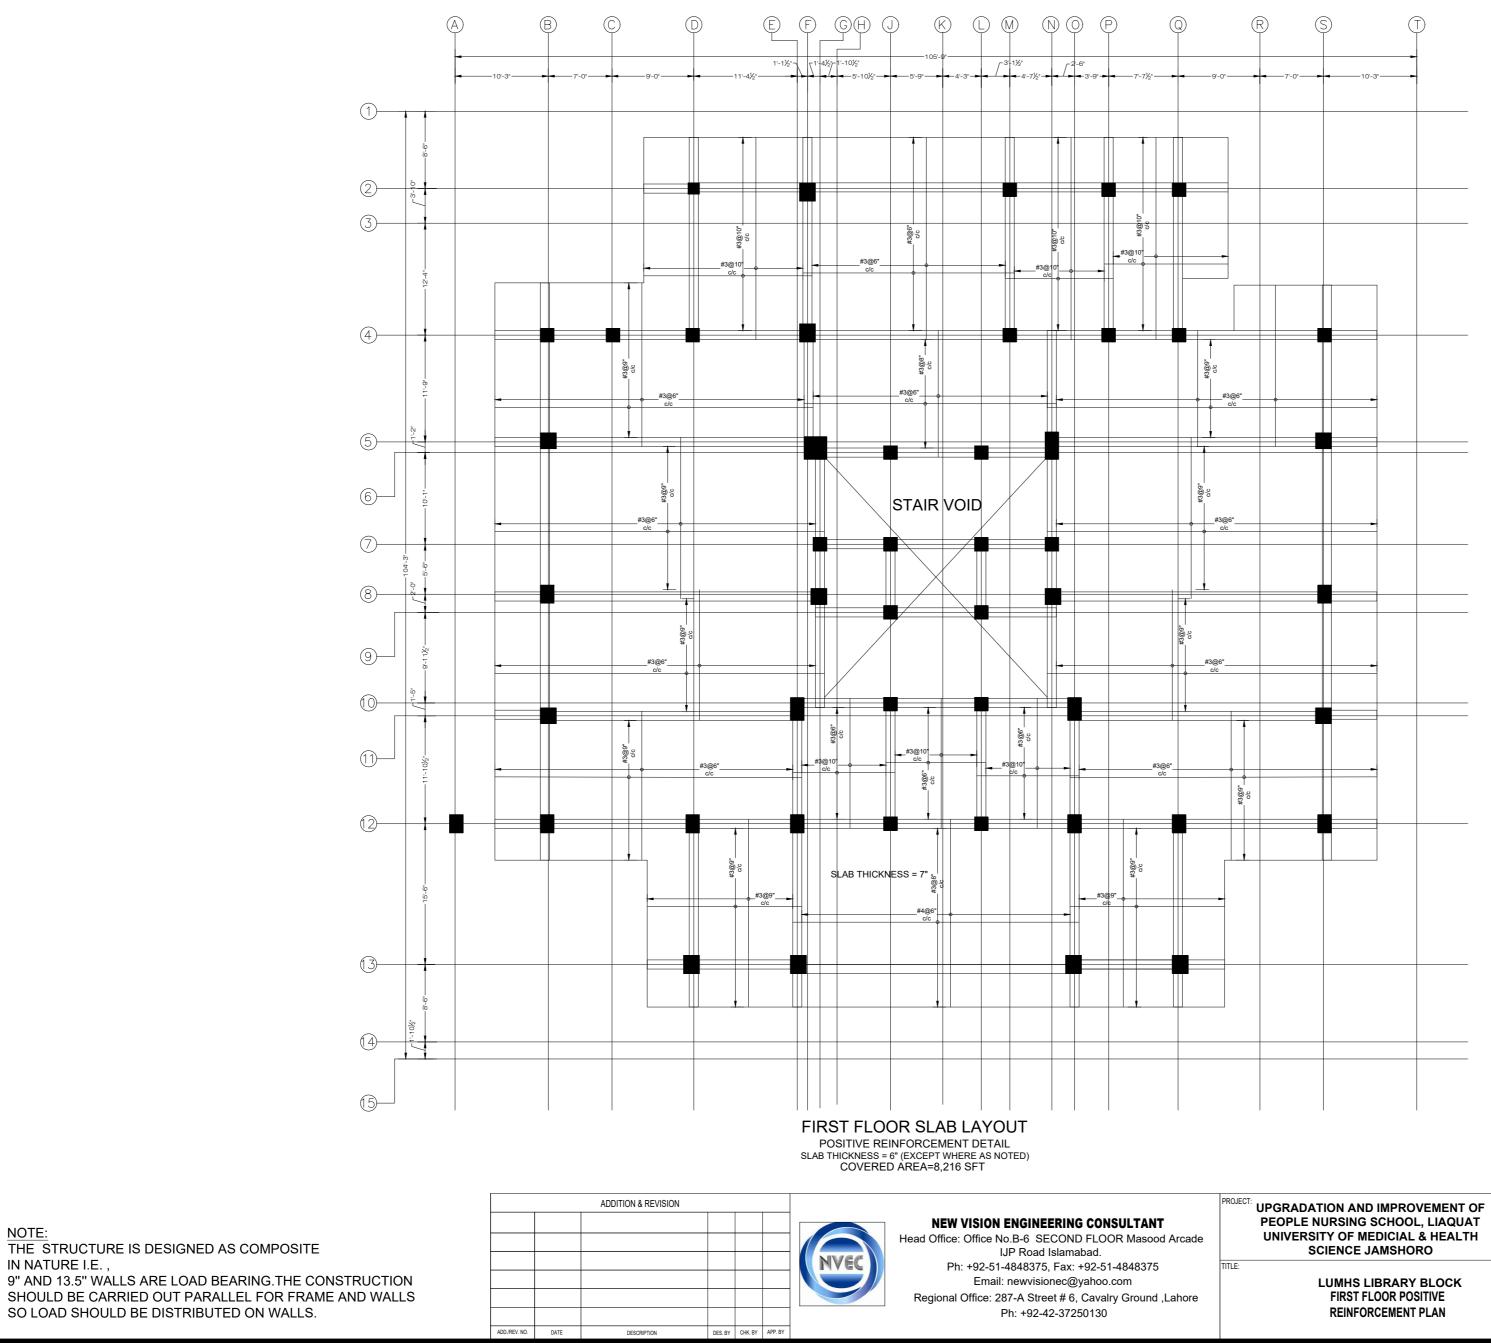
DRG. NO.







SEPTIC PLAN

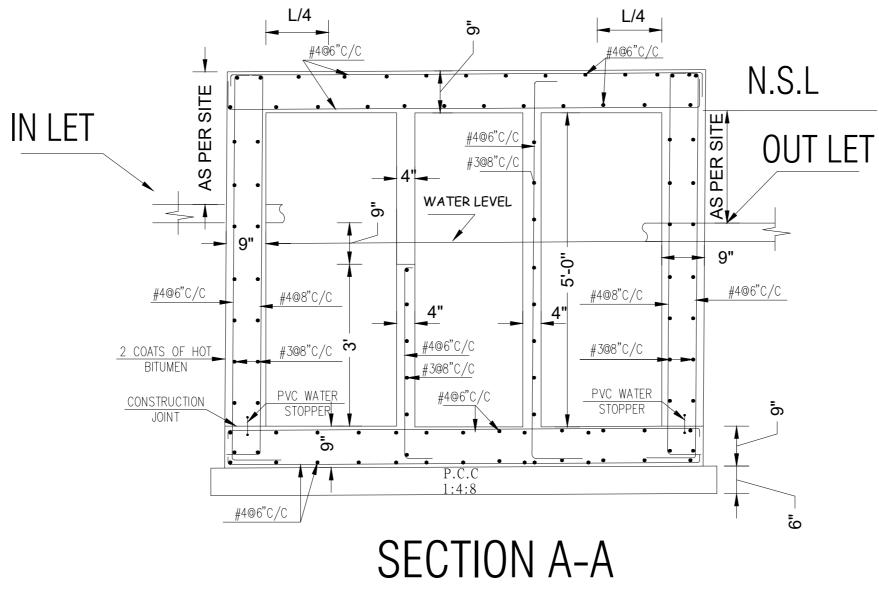

SECTION A-A SEPTIC TANK

E CONSTRUCTION RAME AND WALLS LS.				ADDITION & REVISION					
AUUMEV. NO. UKIE UESCHPIION UES. BY CRA. bt MPY. bt	CONSTRUCTION RAME AND WALLS	ADD/REV. NO.	DATE	DESCRIPTION	DES. BY	СНК. ВУ	APP. BY	NVEC	NEW VISION ENGINI Head Office: Office No.B-6 S IJP Road Ph: +92-51-484837 Email: newvisi Regional Office: 287-A Stre Ph: +92-


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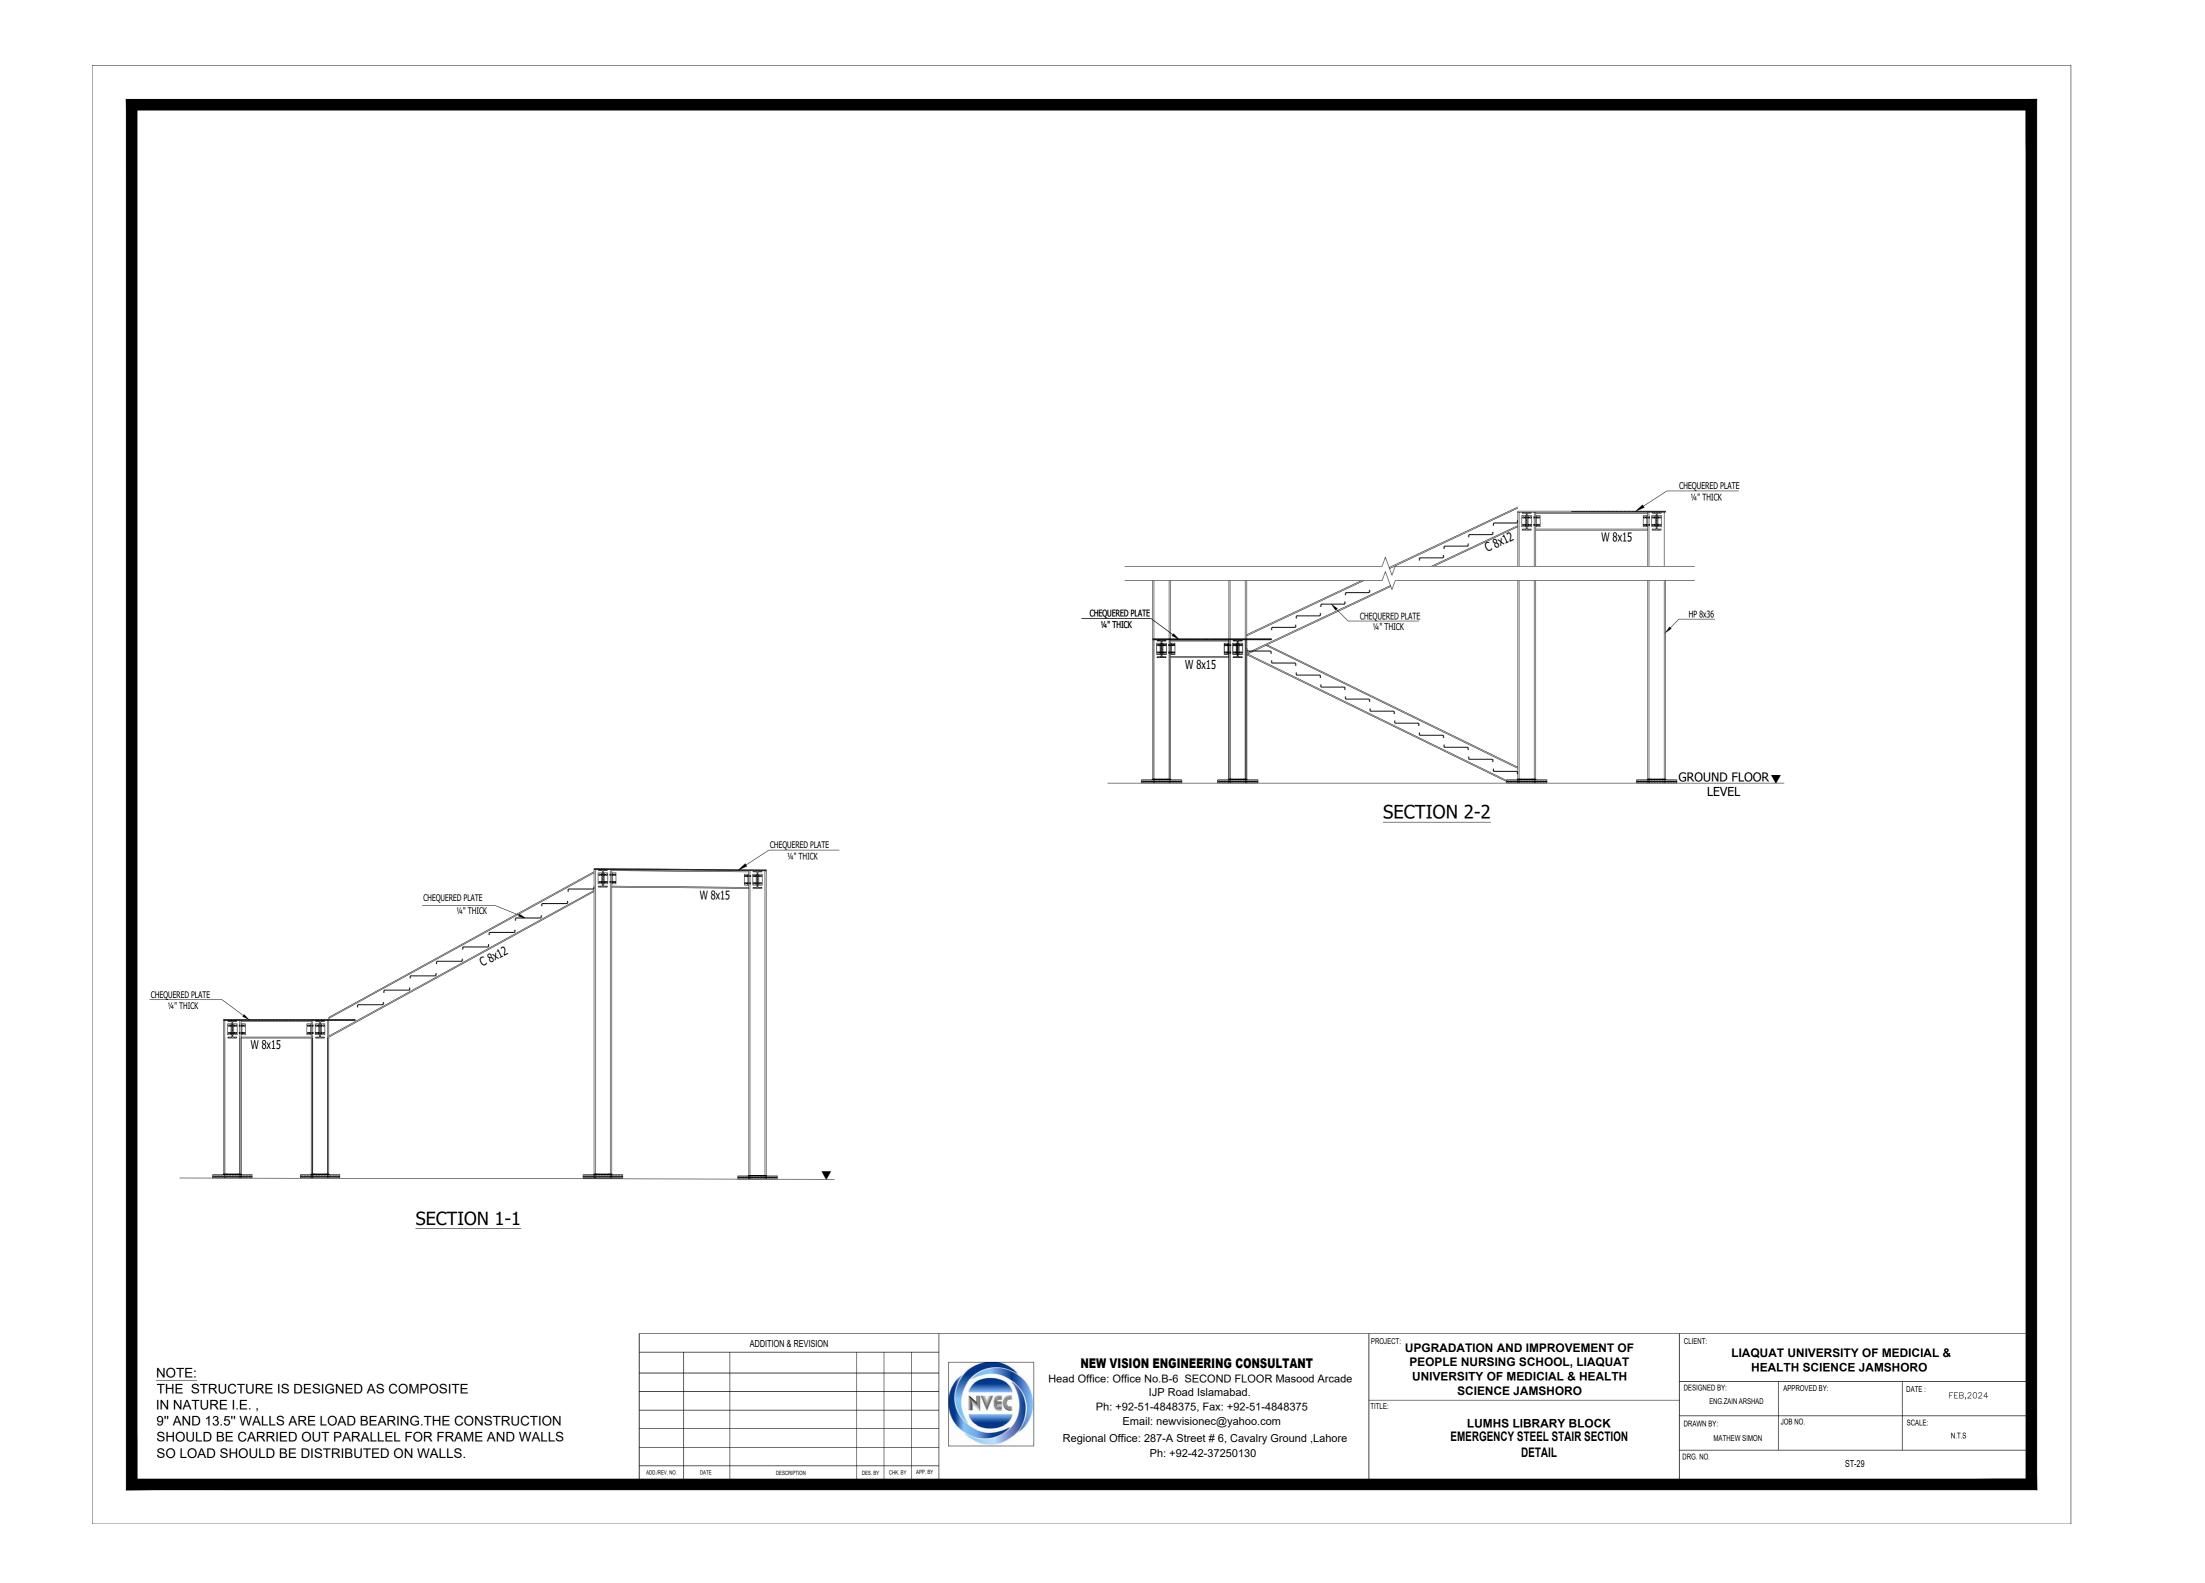
THE STRUCTURE IS DESIGNED AS COMPOSITE IN NATURE I.E., 9" AND 13.5" WALLS ARE LOAD BEARING.THE CONSTRUCTION SHOULD BE CARRIED OUT PARALLEL FOR FRAME AND WAL SO LOAD SHOULD BE DISTRIBUTED ON WALLS.


INEERING CONSULTANT SECOND FLOOR Masood Arcade	PROJECT: UPGRADATION AND IMPROVEMENT OF PEOPLE NURSING SCHOOL, LIAQUAT UNIVERSITY OF MEDICIAL & HEALTH		T UNIVERSITY OF ME		&
oad Islamabad. 375, Fax: +92-51-4848375	SCIENCE JAMSHORO	DESIGNED BY: ENG.ZAIN ARSHAD	APPROVED BY:	DATE :	FEB,2024
visionec@yahoo.com Street # 6, Cavalry Ground ,Lahore	LUMHS LIBRARY BLOCK SEPTIC TANK DETAIL	DRAWN BY: MATHEW SIMON	JOB NO.	SCALE:	N.T.S
92-42-37250130		DRG. NO.	ST-27		


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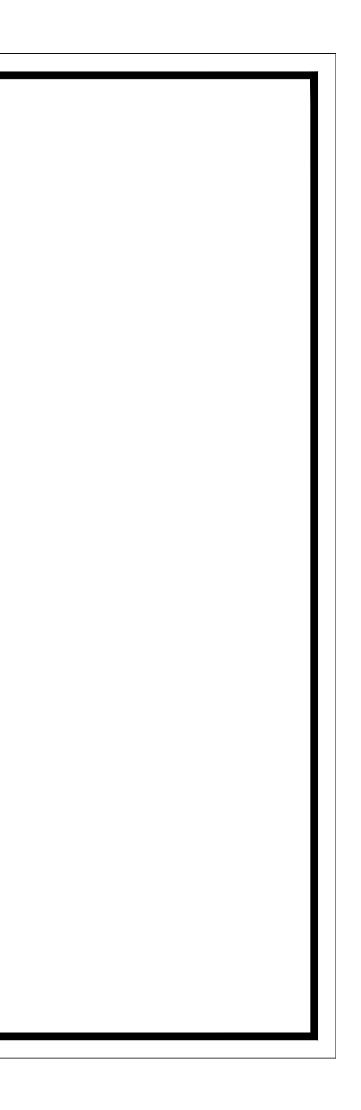


THE STRUCTURE IS DESIGNED AS COMPOSITE 9" AND 13.5" WALLS ARE LOAD BEARING. THE CONSTRUCTION SHOULD BE CARRIED OUT PARALLEL FOR FRAME AND WALLS SO LOAD SHOULD BE DISTRIBUTED ON WALLS.

NOTE:

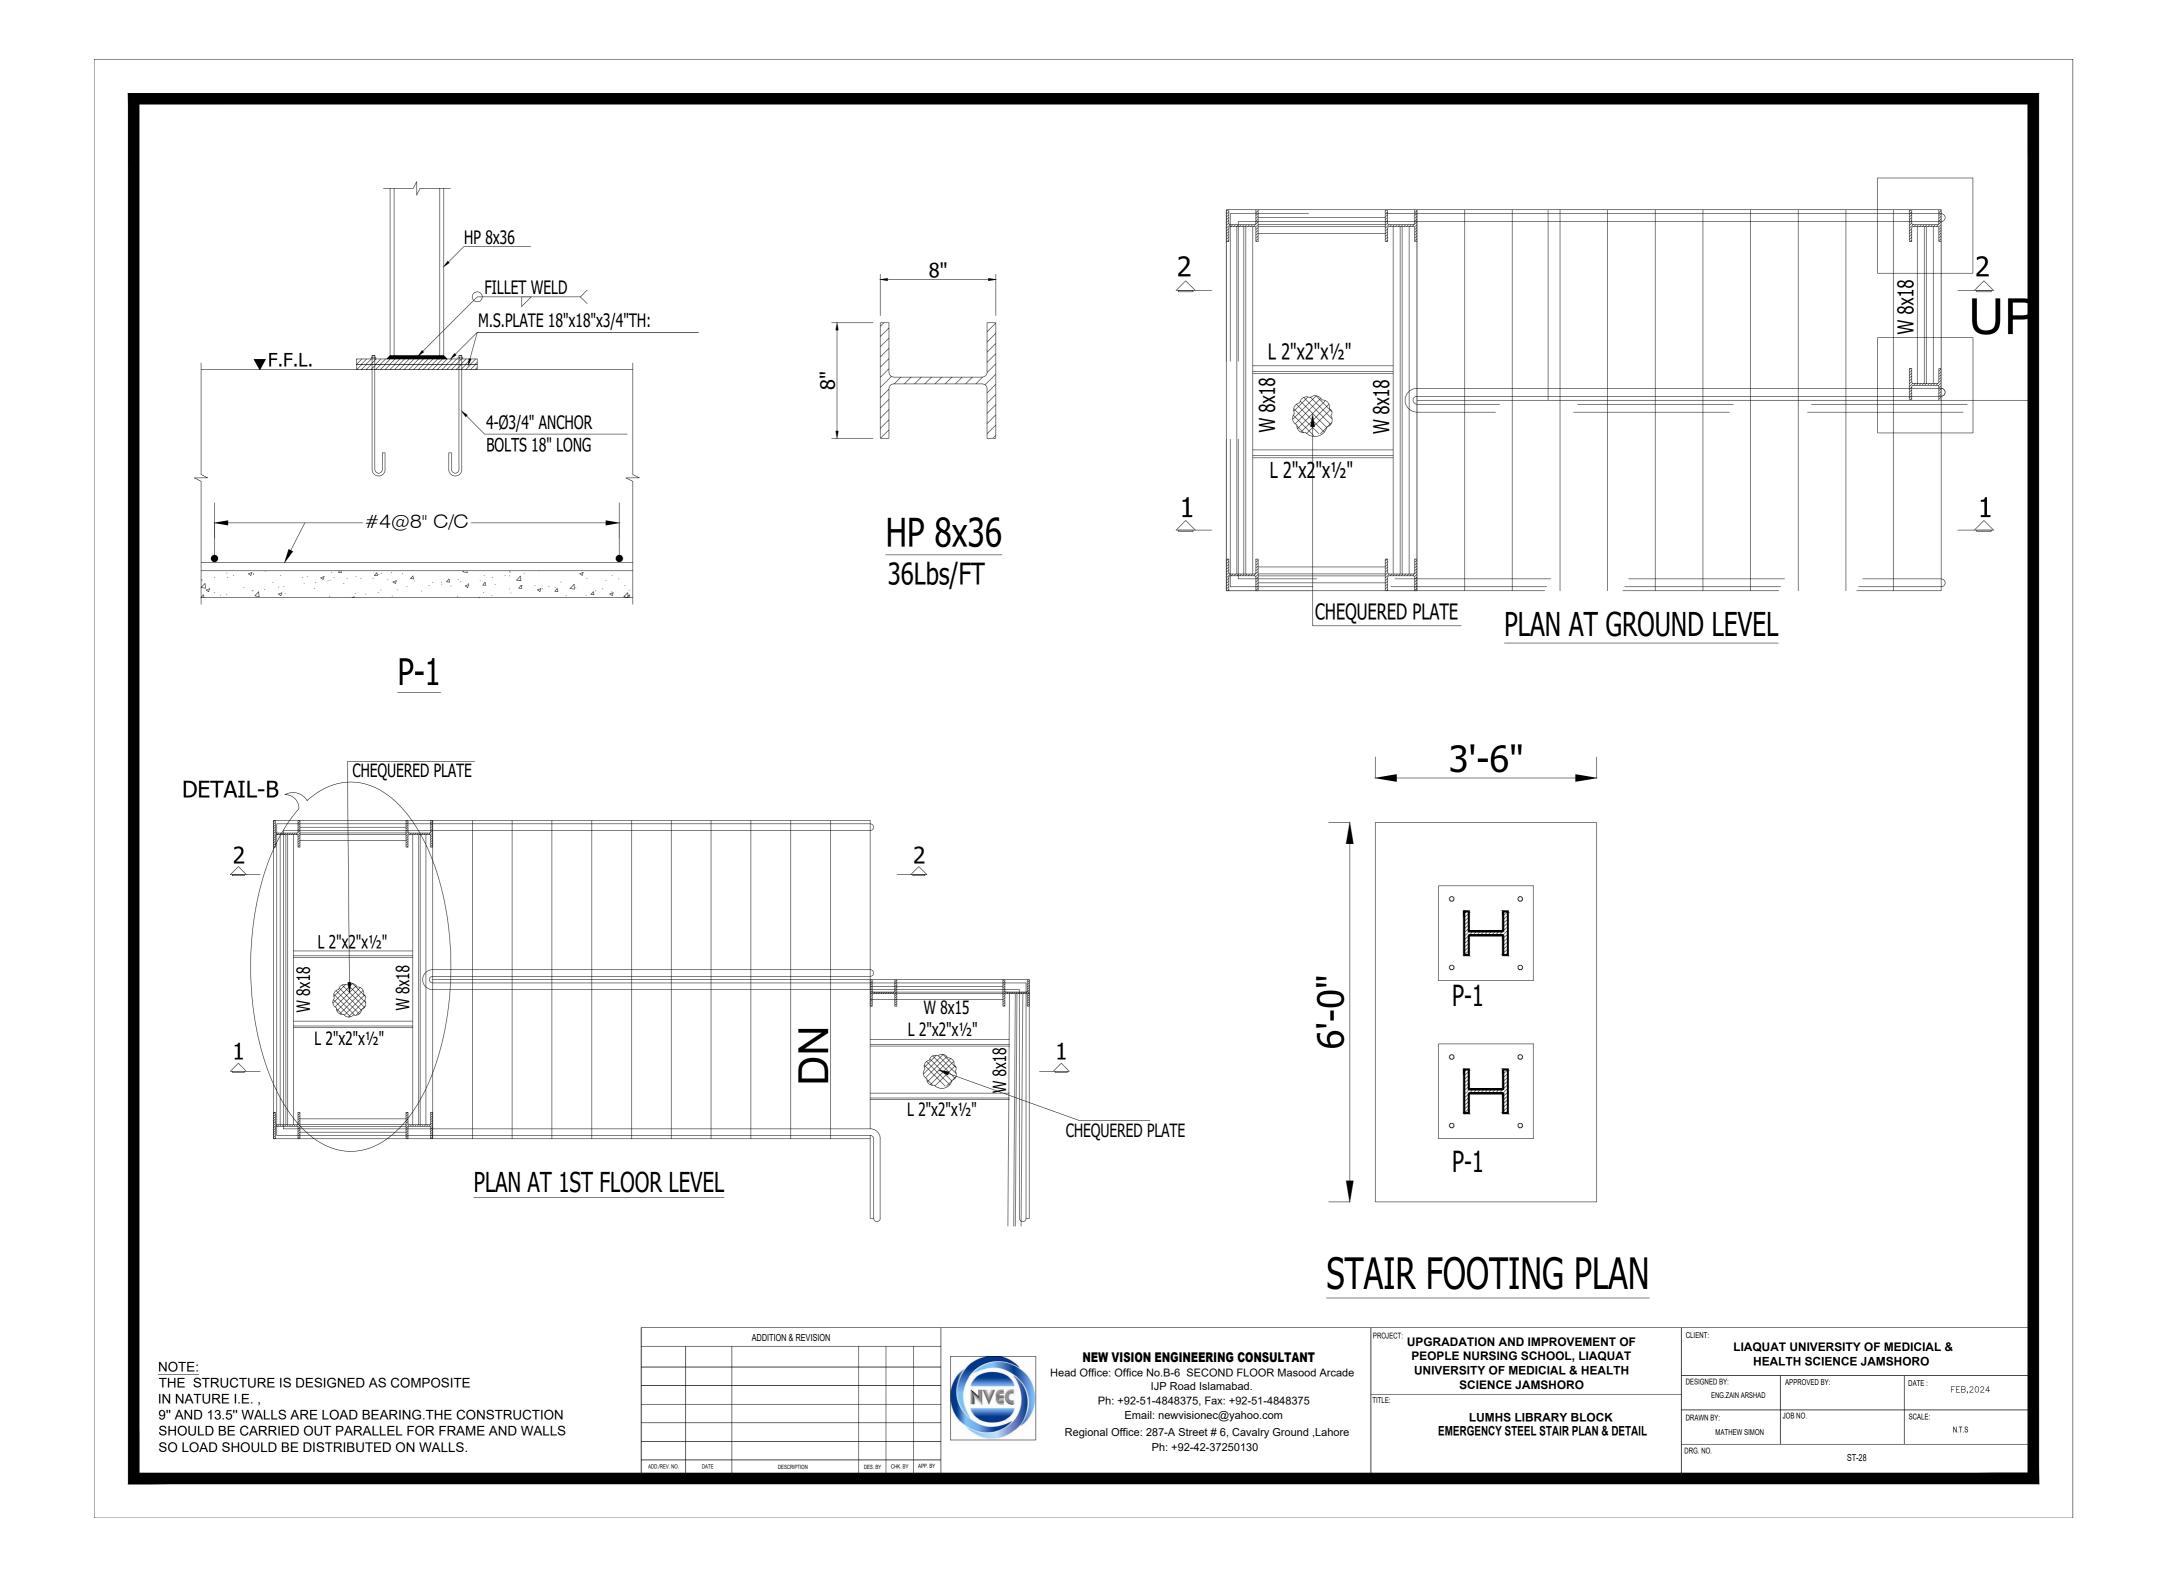IN NATURE I.E.,

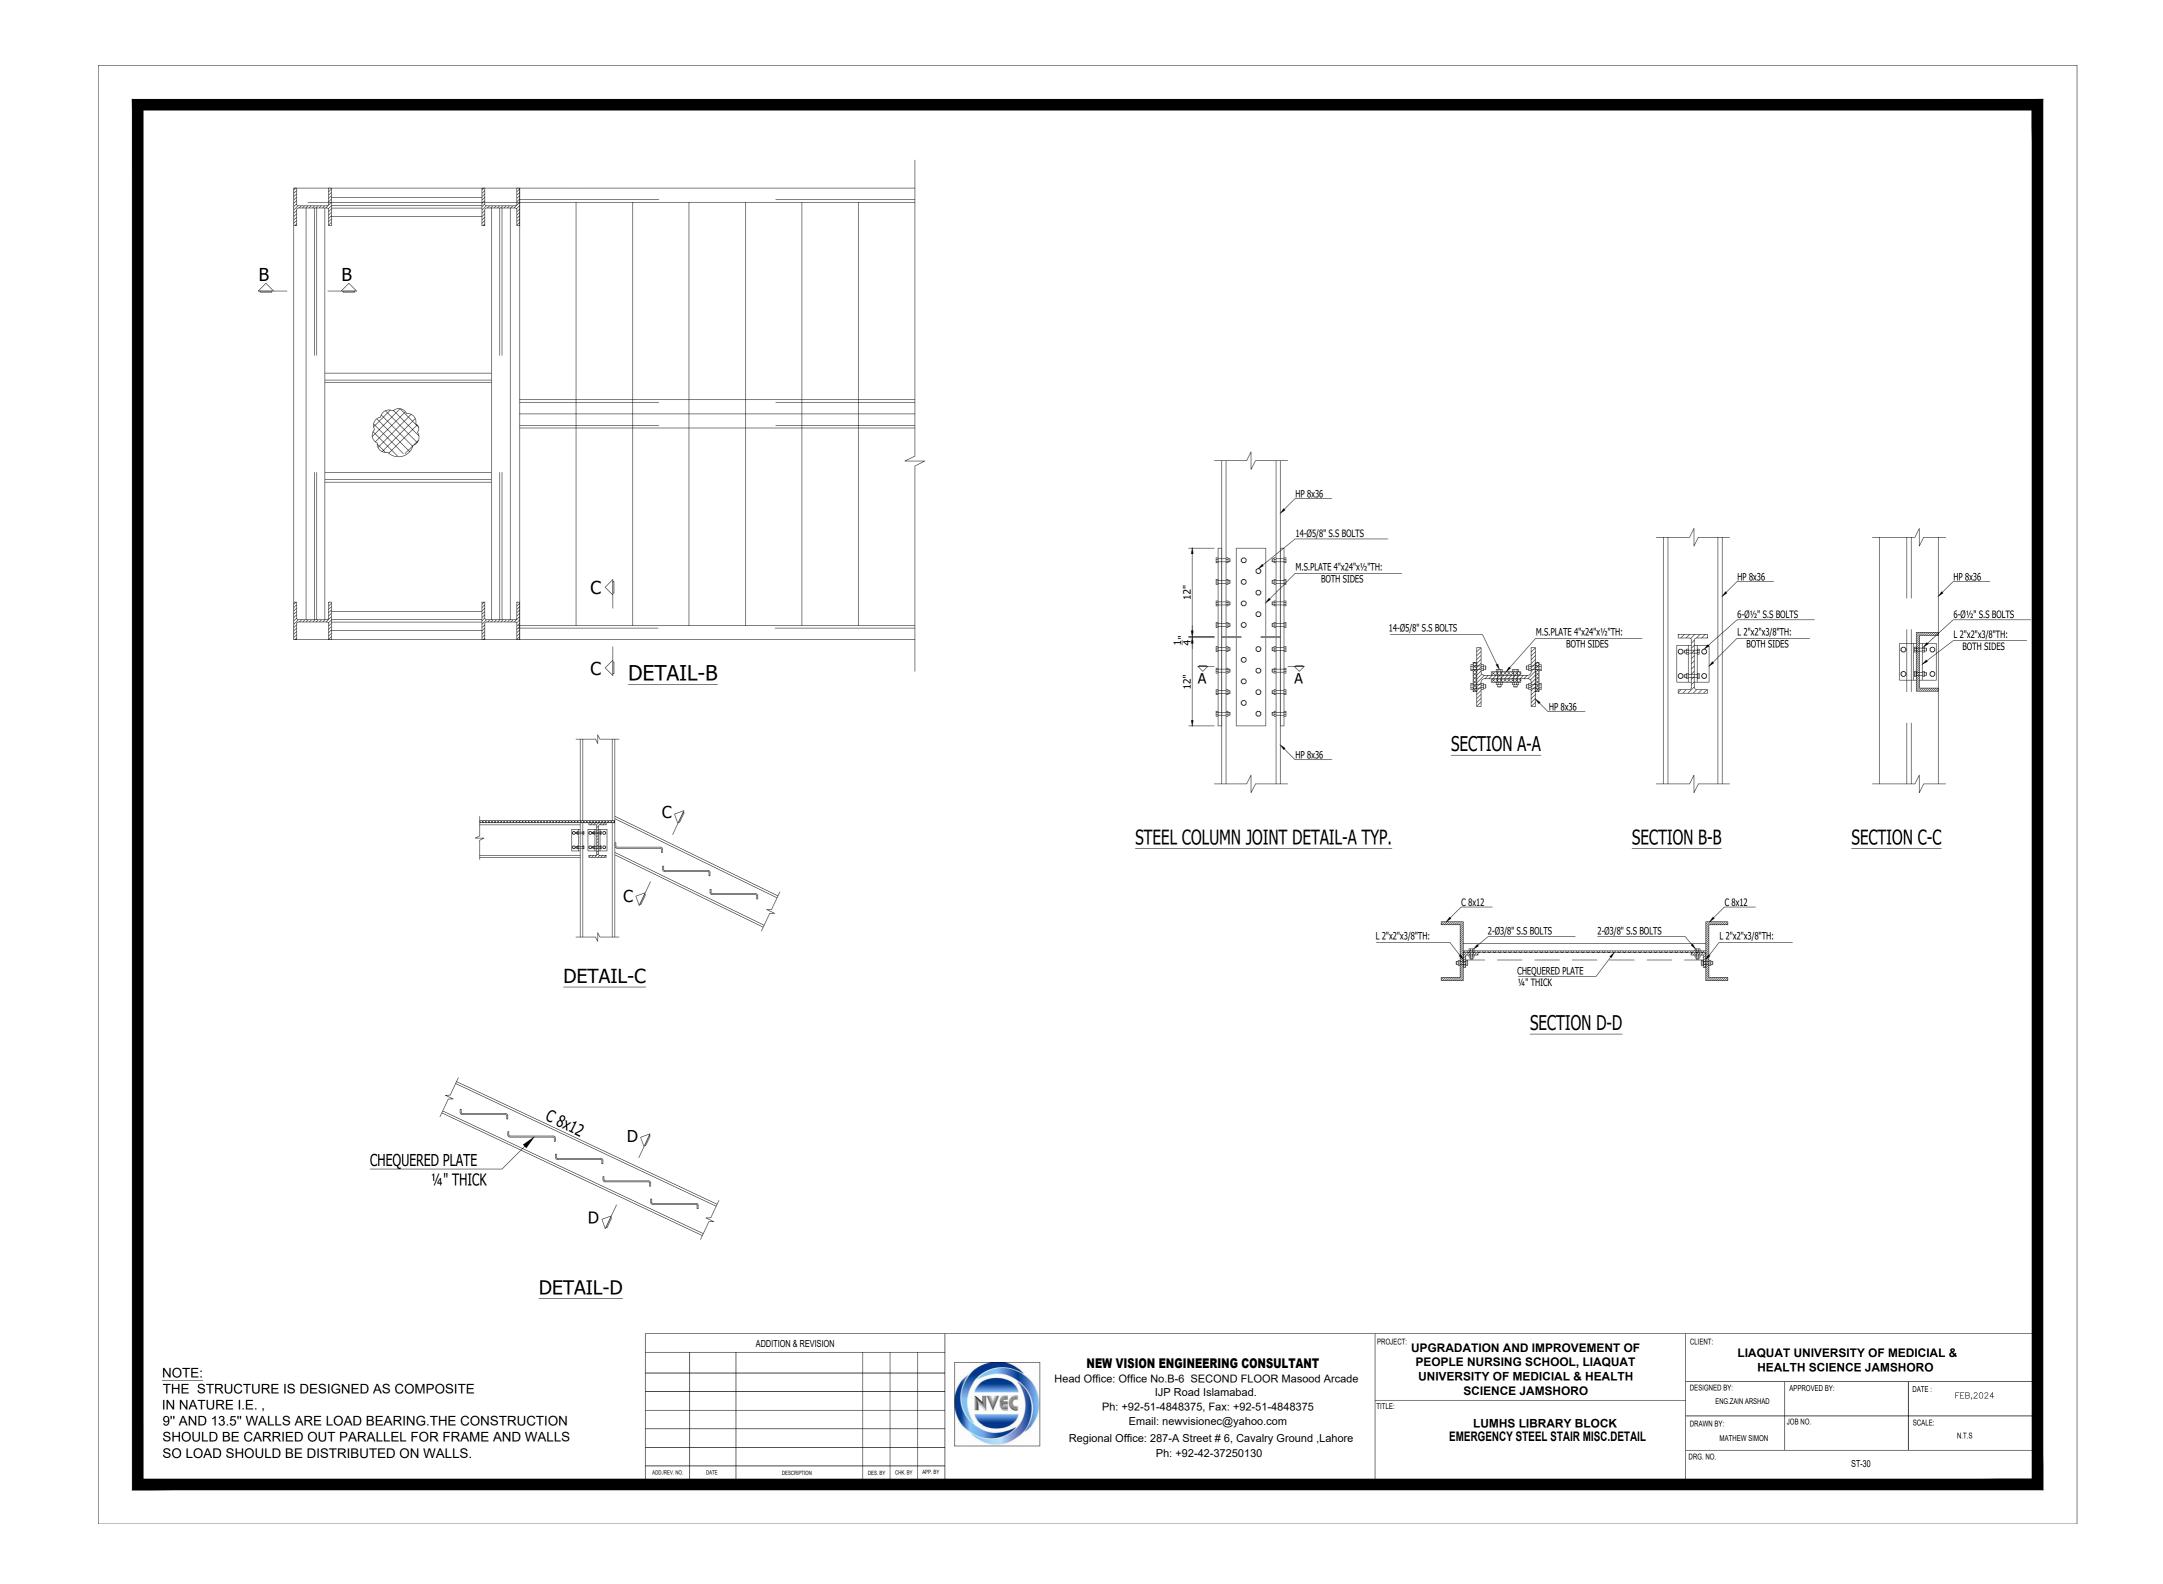ELECTRICAL

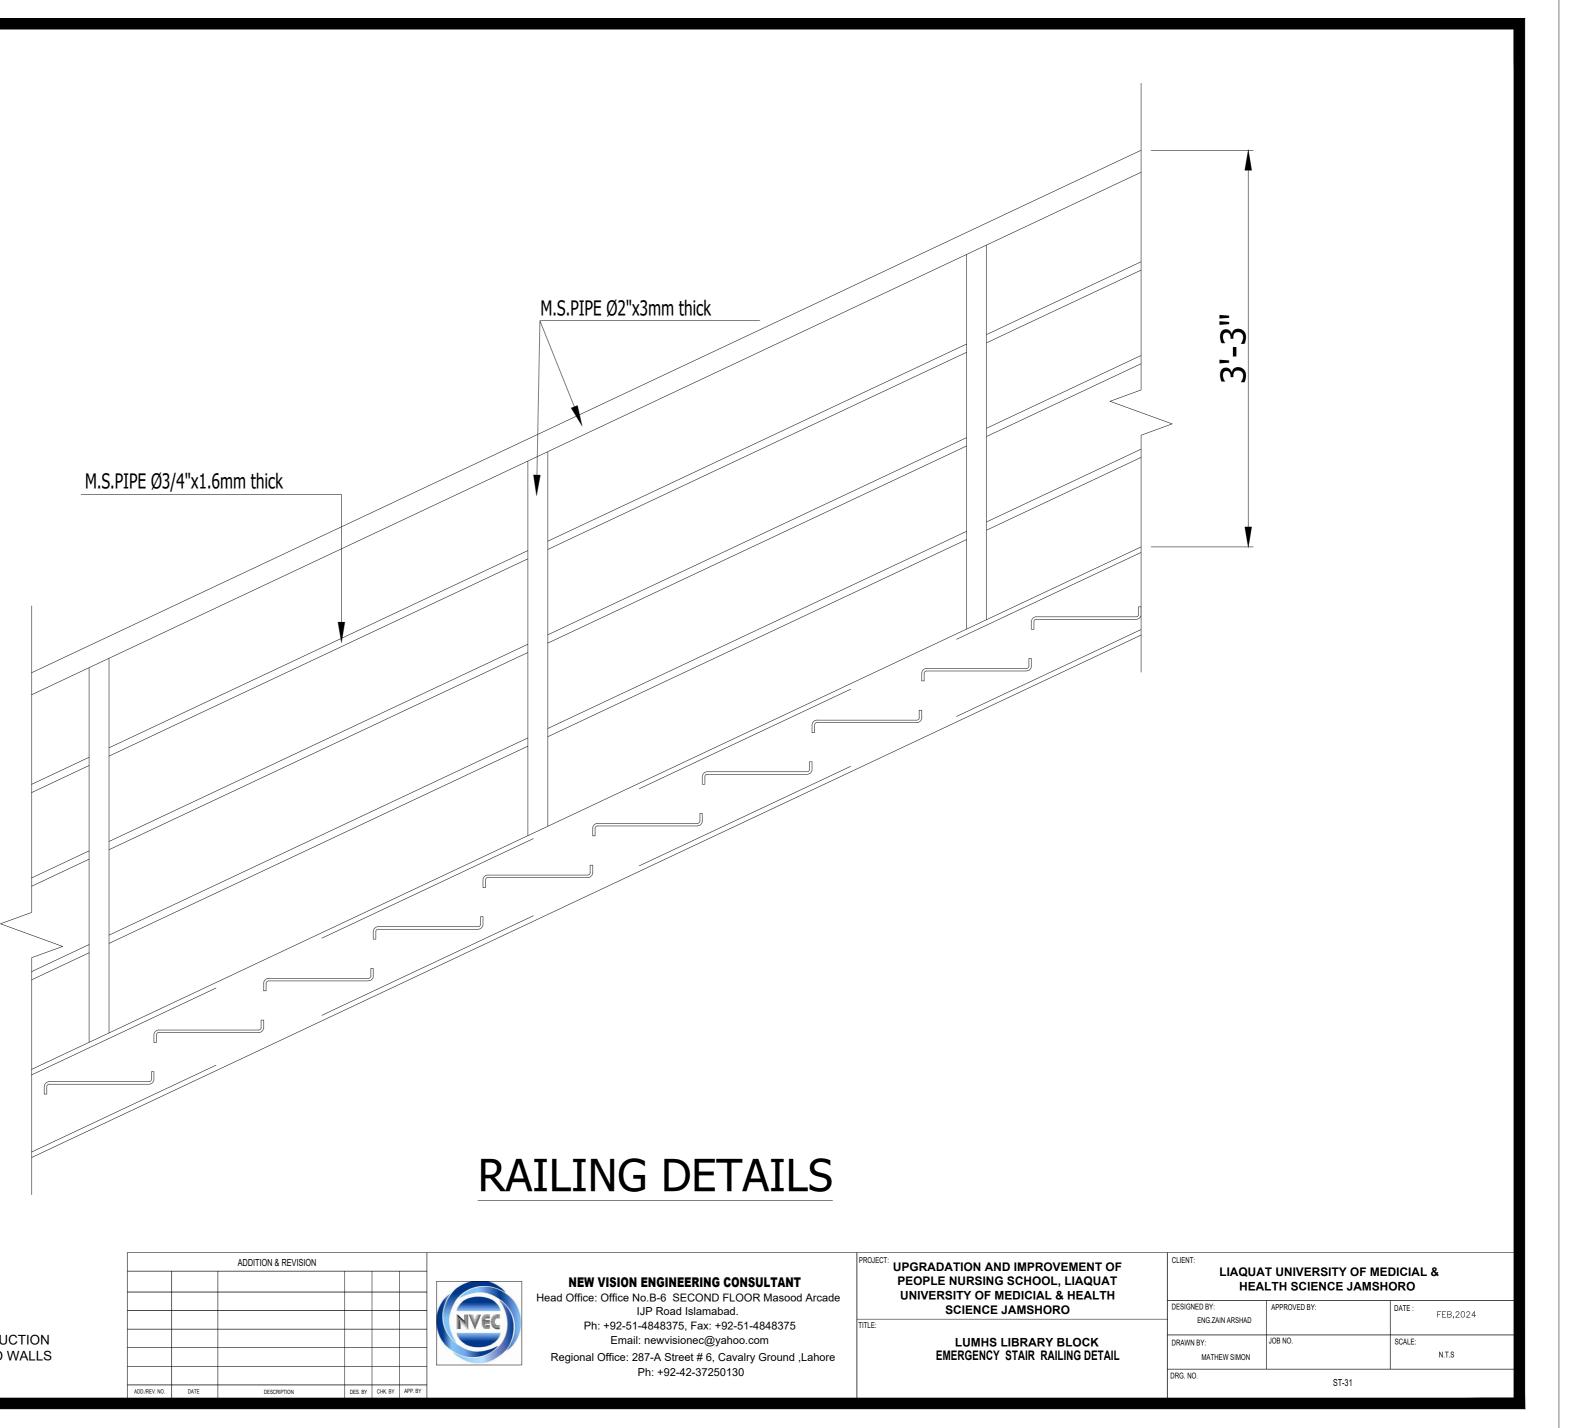

LIST OF DRAWINGS					
S.NO.	DRAWING TITLE	DRG. NO			
	ELECTRICAL DRAWINGS				
1	LIST OF DRAWING	EL-00			
2	GENERAL NOTES	EL-01			
3	FIRE ALARM TYPICAL DETAIL	EL-02			
4	MOUNTING HEIGHT OF FIXTURE DETAIL DETAIL	EL-03			
5	LEGEND AND SYMBOLS	EL-04			
6	EARTHING DETAIL	EL-05			
7	SLD OF DISTRIBUTION BOARDS	EL-06			
8	GROUND FLOOR LIGHTING LAYOUT	EL-07			
9	GROUND FLOOR LIGHTING LAYOUT	EL-08			
10	GROUND FLOOR POWER LAYOUT	EL-09			
11	FIRST FLOOR POWER LAYOUT	EL-10			
12	GROUND FLOOR FIRE ALARM SYSTEM LAYOUT	EL-11			
13	FIRST FLOOR FIRE ALARM SYSTEM LAYOUT	EL-12			
14	GROUND FLOOR CCTV LAYOUT	EL-13			
15	FIRST FLOOR CCTV LAYOUT	EL-14			

		ADDITION & REVISION				NEW VISION ENGINEERING CONSULTAN	
						Head Office: Office No.B-6 Second Floor Masood Arcade IJP Road Islamabad.	
						Ph: +92-51-4848375, Fax: +92-51-4848375 Email: newvisionec@yahoo.com	TITLE: LUMHS LIBRARY BLOCK
						Regional Office: 287-A Street # 6, Cavalry Ground ,Lahore	LIST OF DRAWING
						Ph: +92-42-37250130	CAD filename:
ADD./REV. NO.	DATE	DESCRIPTION	DES. BY	CHK. BY	APP. BY		CAD menane.

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VERSITY OF		NIVERSITY OF MEDICI SCIENCE JAMSHOR		
T OF PEOPLE VERSITY OF AMSHORO				
ERSITY OF	LIAQUAT UI DESIGNED BY: ENGR. SHADAB DRAWN BY:	SCIENCE JAMSHOR	DATE : JAN, 2024 SCALE:	
VERSITY OF	LIAQUAT UI DESIGNED BY: ENGR. SHADAB	SCIENCE JAMSHOR	DATE : JAN, 2024	

GENERAL NOTES

ELECTRICAL SYSTEMS

- FOLLOWING NOTES SHALL IN GENERAL APPLY TO ALL ELECTRICAL DRAWINGS. THE INSTRUCTIONS IN THESE NOTES SHALL BE FOLLOWED UNLESS STATED OTHERWISE
- 2. THESE NOTES SHALL BE APPLICABLE TO THE ENTIRE ELECTRICAL WORKS. IF THE SITE CONDITIONS NECESSITATE ANY ALTERATIONS OR DEVIATIONS THE DIRECTIONS OF THE ENGINEER SHALL BE OBSERVED AS FINAL INSTRUCTIONS.
- ALL ELECTRICAL DRAWINGS SHALL BE READ IN CONJUNCTION WITH BOQ, TECHNICAL SPECIFICATIONS, ARCHITECTURAL, STRUCTURAL, PLUMBING AND HVAC DRAWINGS & ALL OTHER RELEVANT DETAILS.
- DIMENSIONS/MEASUREMENTS GIVEN IN LAYOUT AND DETAILED DRAWINGS ARE APPROXIMATE. THE CONTRACTOR SHALL BE RESPONSIBLE TO CALCULATE THE ACTUAL DIMENSIONS/ MEASUREMENTS ACCORDING TO STRUCTURAL AND ARCHITECTURAL DRAWINGS.
- THE CONTRACTOR SHALL SUBMIT SHOP DRAWINGS WITH ALL RELEVANT DETAILS TO THE ENGINEER FOR APPROVAL ACCORDING TO THE GENERAL CONDITIONS OF CONTRACT WELL IN TIME BEFORE COMMENCEMENT OF THAT WORK
- PROPER CO-ORDINATION OF ELECTRICAL WORKS WITH OTHER SERVICES SHALL BE CARRIED OUT AT SITE
- ALL NON CURRENT CARRYING PARTS i.e. OUTER CASINGS OF EQUIPMENT SUCH AS HT & LT PANELS. DISTRIBUTIONS BOARDS, CABLE TRAYS, AUXILIARY CONSTRUCTIONS FOR EQUIPMENT ETC. SHALL BE CONNECTED TO THE GROUNDING/ EARTHING SYSTEM AT REQUIRED NUMBER OF POINTS WITH SPECIFIED SIZES OF CONDUCTORS. WATER PIPES ALONG ELECTRICAL LINE SHALL BE BONDED TO THE EARTHING SYSTEM WITH 10 sq.mm, SINGLE CORE, COPPER CONDUCTOR PVC CABLE,
- ELECTRICAL POINTS FOR EQUIPMENT SHALL BE INSTALLED IN CO-ORDINATION WITH THE RELEVANT DRAWINGS OF OTHER SERVICES, SUCH AS COMMUNICATION SYSTSMS, HVAC, PLUMBING ETC. THE LOCATION ON ELECTRICAL DRAWINGS IS ONLY INDICATIVE.
- ARRANGEMENT OF ELECTRICAL EQUIPMENTS ON ELECTRICAL DRAWINGS ARE TENTATIVE. EXACT ARRANGEMENT OF EQUIPMENTS SHALL BE MADE IN VIEW OF ITS PHYSICAL DIMENSIONS AND EASE OF MAINTENANCE. AND AS PER SITE REQUIREMENTS.
- 10. LOADS ON ALL PHASES SHALL BE BALANCED AT THE TESTING/ COMMISSIONING STAGE.
- 1. CONDUIT/DUCT RUN UNDER FLOOR SHALL HAVE A MINIMUM COVER OF
- TWO INCHES FROM TOP OF CONDUIT/DUCT TO FINISH FLOOR LEVEL.
- 12. RUN GREEN-YELLOW OR GREEN SINGLE CORE PVC INSULATED COPPER CONDUCTOR CABLE OF SPECIFIED SIZES AS PROTECTIVE EARTH CONDUCTOR (ECC) ALL ALONG LIGHT AND POWER WIRING. WHEREVER THE SIZE IS NOT SPECIFIED THE FOLLOWING CRITERIA SHALL BE OBSERVED TO DETERMINE MINIMUM CROSS SECTIONAL AREA OF EARTH CONTINUITY CONDUCTOR (ECC) IN RELATION TO THE AREA OF ITS PHASE CONDUCTORS. RUN SEPARATE ECC FOR EACH CIRCUIT. - ECC & PHASE CONDUCTOR OF SAME SIZE FOR UPTO AND INCLUDING 16 SQMM CABLES - 16 SQMM ECC FOR PHASE CONDUCTOR OF 16 SQMM, 25SQMM & 35 SQMM CABLES - FOR CABLES OF 50 SQMM AND ABOVE SIZES, ECC IS HALF SIZE OF PHASE CONDUCTOR. MAXIMUM SIZE OF ECC IS 70 SQMM.

ELEC TRICAL SYSTEMS

13. THE MAXIMUM CAPACITY OF PVC CONDUITS FOR SIMULTANEOUS DRAWING OF PVC INSULATED CABLES SHALL BE DETERMINED AS PER BS 4607. THE FOLLOWING TABLE SHALL BE USED TO DETERMINE THE MAXIMUM NUMBER OF CABLES.

S. #	NOMINAL CONDUCTOR SIZE(SQMM)	NO. & DIA OF WIRES	NOMINAL OVERALL DIA	20 MM DIA (3/4" DIA)	25 MM DIA (1" DIA)	32 MM DIA (1/ " DIA)
1	1.5	1/1.38	3.1	10	18	30
2	2.5	1/1.78	3.5	8	14	23
3	2.5	7/0.67	3.8	7	12	20
4	4	7/0.85	4.3	5	9	15
5	6	7/1.04	4.9	4	7	12
6	10	7/1.35	6.2	2	4	7
7	16	7/1.70	7.3	-	3	5
8	25	7/2.14	9.0	-	2	3
9	35	19/1.53	10.3	-	-	2

14. NORMAL & EMERGENCY CIRCUITS SHALL RUN IN SEPARATE CONDUITS.

- 15. ALL WIRING FOR CONTROLS SHALL BE CARRIED OUT WITH 1 CORE PVC CABLES OF SPECIFIED VOLTAGE GRADE AND SIZES.
- 16. THE WIRING SHALL BE CONTINUOUS LOOPING-IN TYPE AND NO JOINT IN WIRES SHALL BE ALLOWED.
- 17. THE WIRING SYSTEM SHALL BE CARRIED OUT ONLY AFTER THE CONDUIT SYSTEM IS COMPLETELY INSTALLED AND ALL OUTLET BOXES, ETC. ARE FIXED IN POSITION.
- 18. MOUNTING HEIGHTS OF ELECTRICAL FITTINGS WHEN MEASURED FROM FINISHED FLOOR LEVEL (F.F.L.) TO THE BOTTOM OF FITTINGS SHALL BE AS UNDER, UNLESS OTHERWISE SHOWN OR INSTRUCTED.

MAIN SWITCH BOARD	48 INCHES
DISTRIBUTION BOARD	48 INCHES
CONTROL PANEL	48 INCHES
ON/OFF PUSH BUTTON STATION	48 INCHES
DIMMER CONTROL UNIT	48 INCHES
LIGHT CONTROL SWIT(CINE WAY/TWO WAY)	48 INCHES
5A SOCKET OUTLETS IN GENERAL AREAS	10 INCHES
15A SOCKET OUTLETS IN GENERAL AREAS	10 INCHES
20A SOCKET OUTLETS IN GENERAL AREAS	10 INCHES
15A SOCKET OUTLETS IN KITCHEN (ABOVE COUNTER)	10 INCHES
15A SOCKET OUTLETS IN TOILETS	66 INCHES
16A TP 5PIN INDUSTRIAL SOCKET OUTLETS IN LABS.	48 INCHES
32A TP 5PIN INDUTRIAL SOCKET OUTLETS IN LABS	48 INCHES
63A TP 5PIN INDUTRIAL SOCKET OUTLETS IN LABS.	48 INCHES
CEILING FAN	96 INCHES
WALL FAN	84 INCHES
EXHAUST FAN	REFER ARCH. DRGS.

COMMUNICATION SYSTE


- FOLLOWING NOTES SHALL IN GENERAL APPLY TO ALL COMMUNICATION SYSTEMS DRAWINGS. THE INSTRUCTIONS IN THESE NOTES SHALL B FOLLOWED UNLESS STATED OTHERWISE
- THESE NOTES SHALL BE APPLICABLE TO THE ENTIRE COMMUNICATION SYSTEMS WORKS. IF THE SITE CONDITIONS NECESSITATE ANY ALTERATIONS OR DEVIATIONS THE DIRECTIONS OF THE ENGINEER SHALL BE OBSERVED AS FINAL INSTRUCTIONS.
- ALL COMMUNICATION SYSTEMS DRAWINGS SHALL BE READ IN CONJUNCTION WITH TECHNICAL SPECIFICATIONS, ITEMS OF B.O.Q., ARCHITECTURAL STRUCTURAL, HVAC, PLUMBING DRAWINGS AND AL OTHER RELEVANT DETAILS.
- DIMENSIONS/MEASUREMENTS GIVEN IN LAYOUT AND DETAILED DRAWINGS ARE APPROXIMATE. THE CONTRACTOR SHALL BE RESPONSIBLE TO CALCULATE THE ACTUAL DIMENSIONS/MEASUREME ACCORDING TO STRUCTURAL AND ARCHITECTURAL DRAWINGS.
- THE CONTRACTOR SHALL SUBMIT SHOP DRAWINGS WITH ALL RELEVA DETAILS TO THE ENGINEER FOR APPROVAL ACCORDING TO THE GENERAL CONDITIONS OF CONTRACT WELL IN TIME BEFORE COMMENCEMENT OF THAT WORK.
- PROPER CO-ORDINATION OF COMMUNICATION SYSTEMS WORKS WI OTHER SERVICES SHALL BE CARRIED OUT AT SITE.
- TELEPHONE SYSTEM SHALL BE COMPLETE WITH INSTRUMENTS. EQUIPMENT AND INTERCONNECTING WIRING. TELEPHONE EXCHANG TELEPHONE OUTLETS, JUNCTION BOXES, CONDUITS OF SPECIFIED SIZES IN THE BUILDING, AND UNDERGROUND PIPES OF SPECIFIED SIZES SHOWN ON DRAWINGS SHALL BE PROVIDED. WHERE SIZE OF CONDUIT/PIPE IS NOT SPECIFIED SUITABLE SIZE SHALL BE INSTALLED AS DIRECTED BY THE ENGINEER.
- POINTS FOR COMMUNICATION SYSTEMS EQUIPMENT SHALL BE INSTALLED IN CO-ORDINATION WITH THE RELEVANT DRAWINGS OF OTHER SERVICES. SUCH AS ELECTRICAL. HVAC. PLUMBING ETC. THE LOCATION ON COMMUNICATION SYSTEMS DRAWINGS IS ONLY INDICATIVE.
- ARRANGEMENT OF COMMUNICATION SYSTEMS EQUIPMENTS ON DRA ARE TENTATIVE EXACT ARRANGEMENT OF EQUIPMENTS SHALL BE MA IN VIEW OF ITS PHYSICAL DIMENSIONS AND EASE OF MAINTENANCE.
- 10. CONDUIT/DUCT RUN UNDER FLOOR SHALL HAVE A MINIMUM COVER 2 INCHES FROM TOP OF CONDUIT/DUCT TO FINISH FLOOR LEVEL
- 11. RUN GREEN-YELLOW OR GREEN SINGLE CORE PVC INSULATED. COPP CONDUCTOR CABLE OF SPECIFIED SIZES AS PROTECTIVE EARTH CONDUCTOR (ECC) ALL ALONG COMMUNICATION SYSTEMS WIRING.
- 12. ALL WIRING FOR CONTROLS SHALL BE CARRIED OUT WITH 1 CORE PV CABLES OF SPECIFIED VOLTAGE GRADE AND SIZES.
- 13. THE WIRING SHALL BE CONTINUOUS LOOPING-IN TYPE AND NO JOINT IN WIRES SHALL BE ALLOWED
- 14. THE WIRING SYSTEM SHALL BE CARRIED OUT ONLY AFTER THE CONDUIT SYSTEM IS COMPLETELY INSTALLED AND ALL OUTLET BOXES ETC. ARE FIXED IN POSITION.
- 15. MOUNTING HEIGHTS OF ELECTRICAL FITTINGS WHEN MEASURED FRO FINISHED FLOOR LEVEL (F.F.L.) TO THE BOTTOM OF FITTINGS SHALL BE AS UNDER, UNLESS OTHERWISE SHOWN OR INSTRUCTED.

TELEPH TELEPH


TELEPHONE JUNCTION BOX	10 INCH
TELEPHONE OUTLET	10 INCH
INTERCOM CONTROL PACK	10 INCH
INTERCOM STATION (WALL MOUNTED)	36 INCH
FA SYSTEM CONTROL PANEL	36 INCH
FA SYSTEM JUNCTION BOX	10 INCH
MANUAL CALL STATION	42 INCH
AUDIO ALARM	100 INC

		ADDITION & REVISION				N	EW VISION ENGINEERING CONSULTANT	PROJECT: UPGRADATION AND IMPROVEMEN
							Head Office: Office No.B-6 Second Floor Masood Arcade IJP Road Islamabad.	NURSING SCHOOL, LIAQUAT UN MEDICIAL & HEALTH SCIENCE
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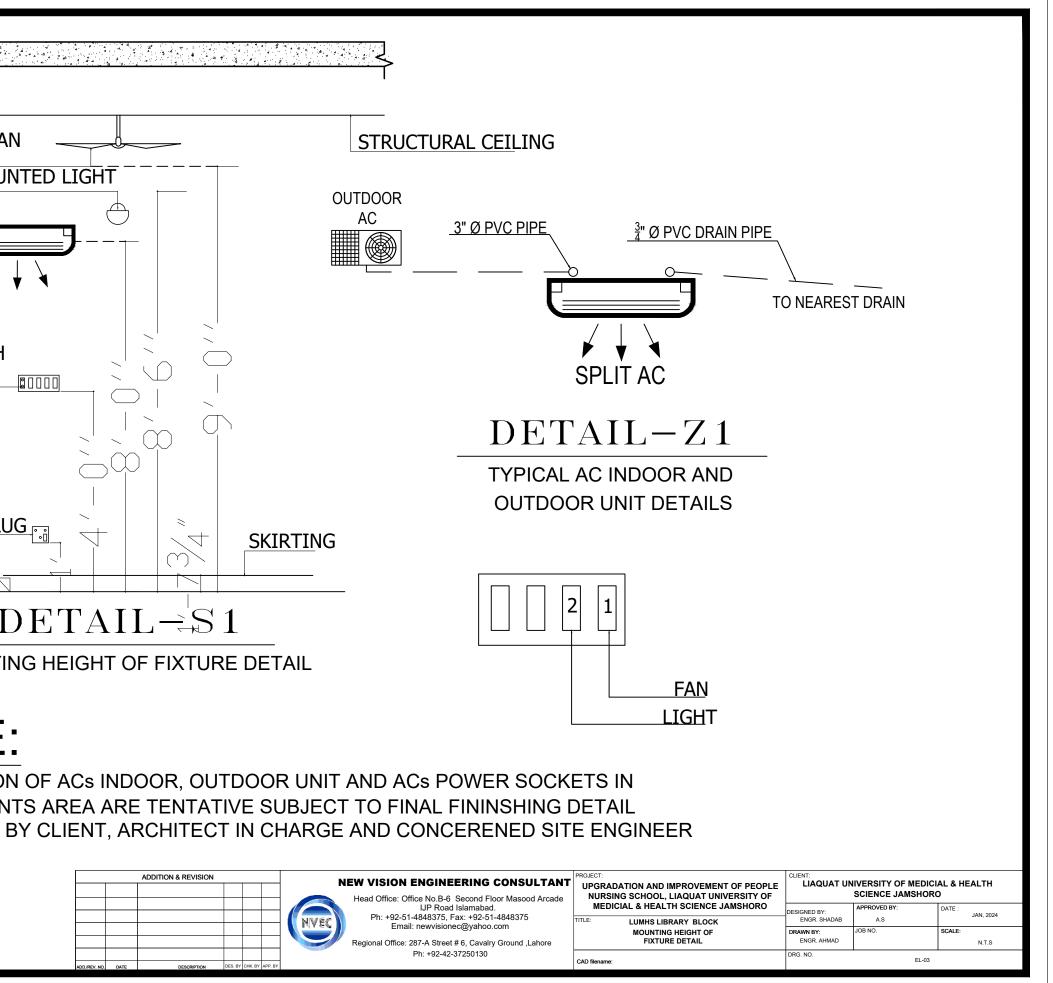
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NOTE:

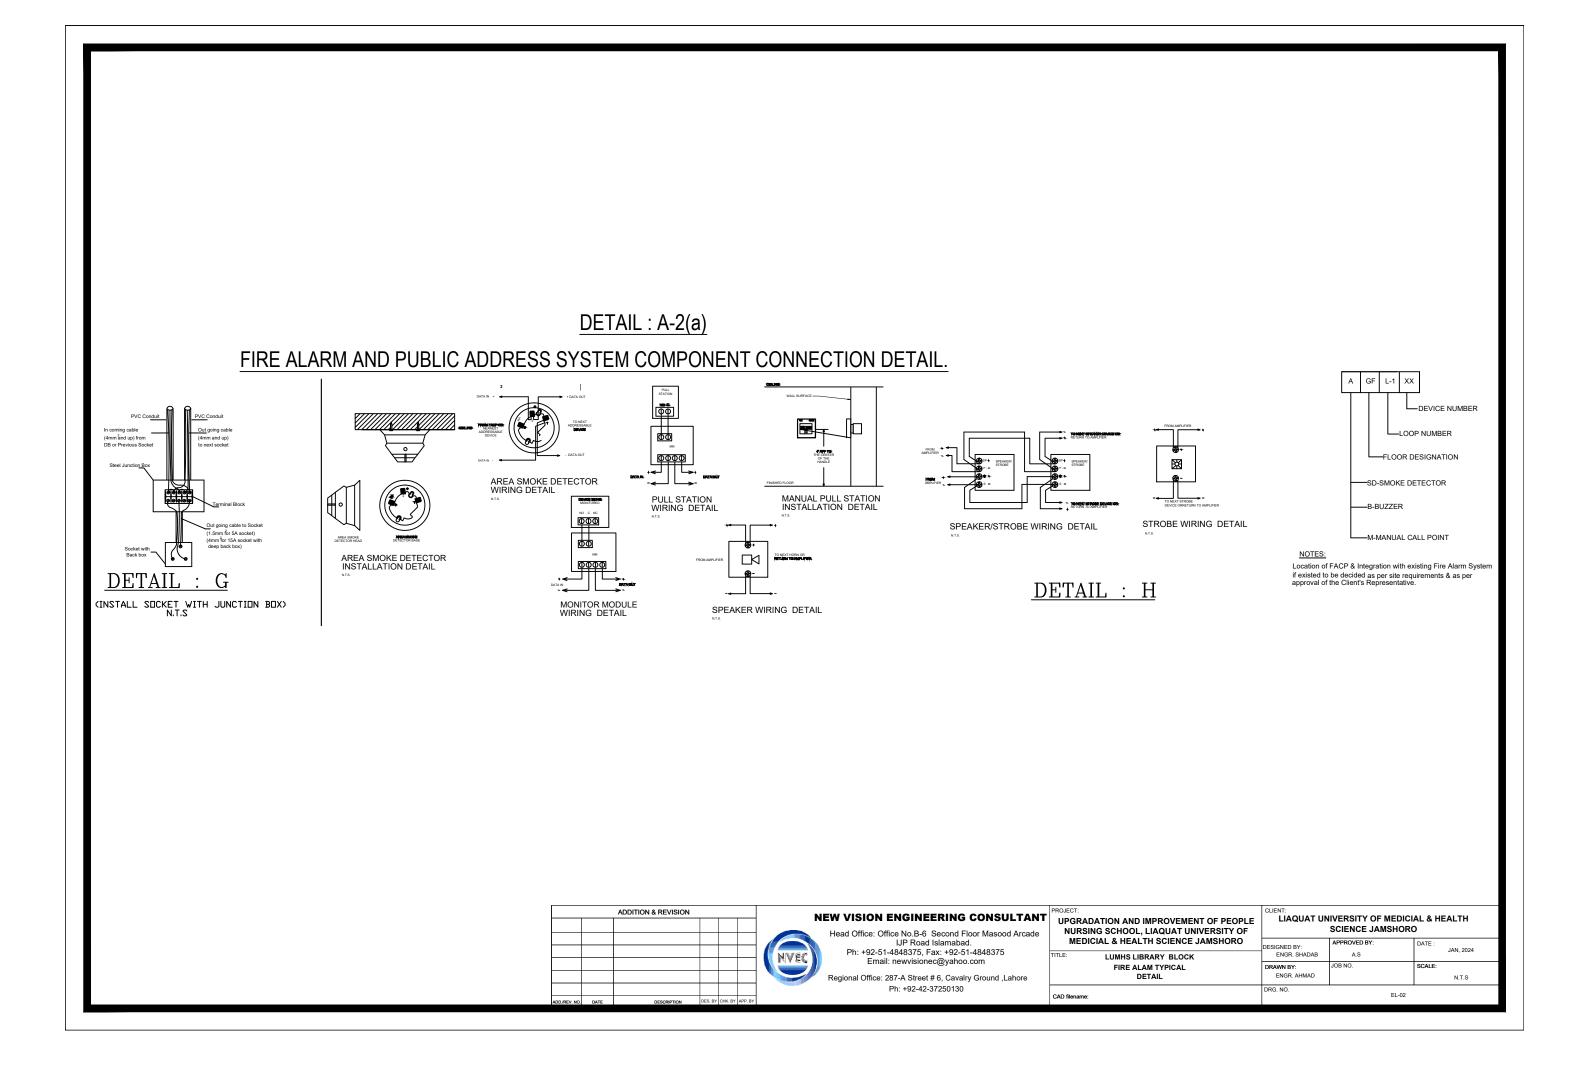

LIGHTING AND POWER

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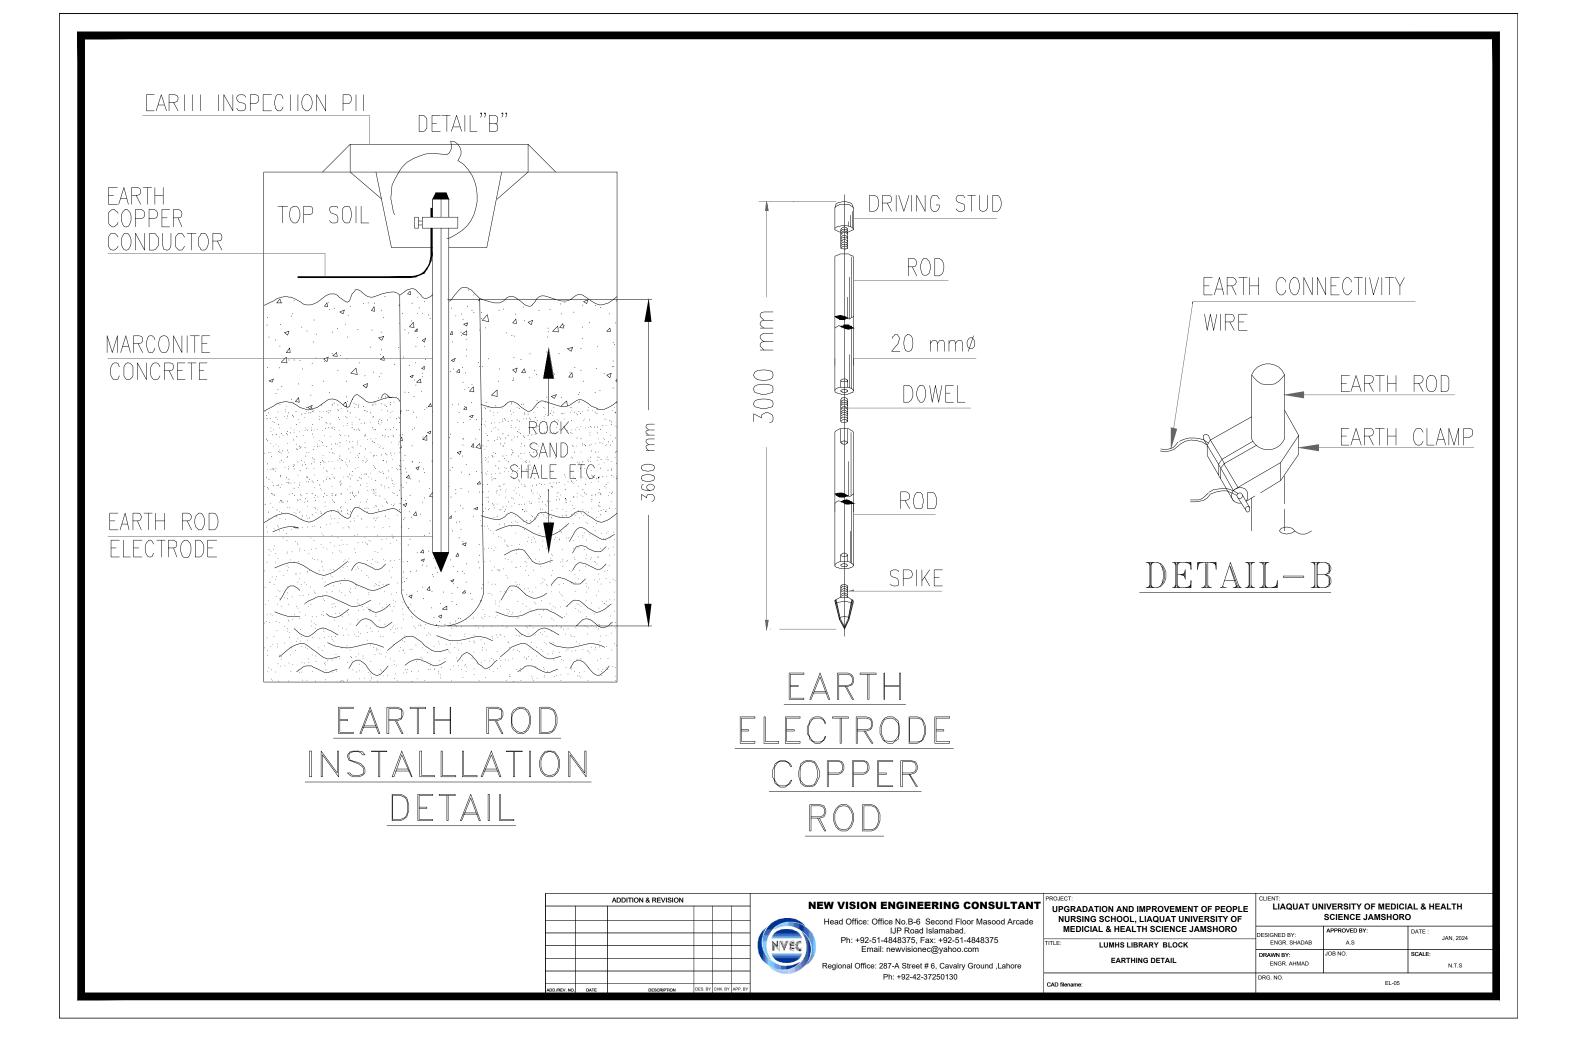
\$.NO	SYMBOLS	DESCRIPTION
1		24 WATT LED/SMD LIGHT FIXTURE OR EQUIVALENT
2	۲	18 WATT LED LIGHT FIXTURE SURFACE/RECESSED MOUNTED OR EQUIVALENT.
3	Ø	12 WATT LED LIGHT FIXTURE SURFACE/RECESSED MOUNTED, IP-44 RATED OR EQUIVALENT.
4	${\color{black}}$	10 " DIA EXHAUST FAN WITH PLASTIC BODY,FAN BLADES AND LOUVERS
5	\checkmark	48" OR 56" DIA CEILING FAN
6	è	INDICATES GANG TYPE SWITCH 10 AMPS, INDICATES NUMBER OF SWITCHES ON SWITCH PLATE
7		INDICATES 3 PIN COMBINED SWITCH SOCKET 10-13 AMPS, ON PLASTIC BACK BOX
8	٥	COMPUTER SOCKET OUTLET RJ45
9	6	INDICATES ROUND PIN 15 AMPS SOCKET, ON PLASTIC BACK BOX
10	8	20 Watt Flood Light
11	DB-XXX	DISTRIBUTION BOARD(DB-XXX) XXX-DENOTES NAME
12	\sum_{D-}	A.C 40 TP AMPS SWITCH & Unit (4 Ton)
13	Å	A.C 20 SP AMPS SWITCH & unit(2 Ton)
14	Ø	Camera
15	Data Cabinet	Data cabinet

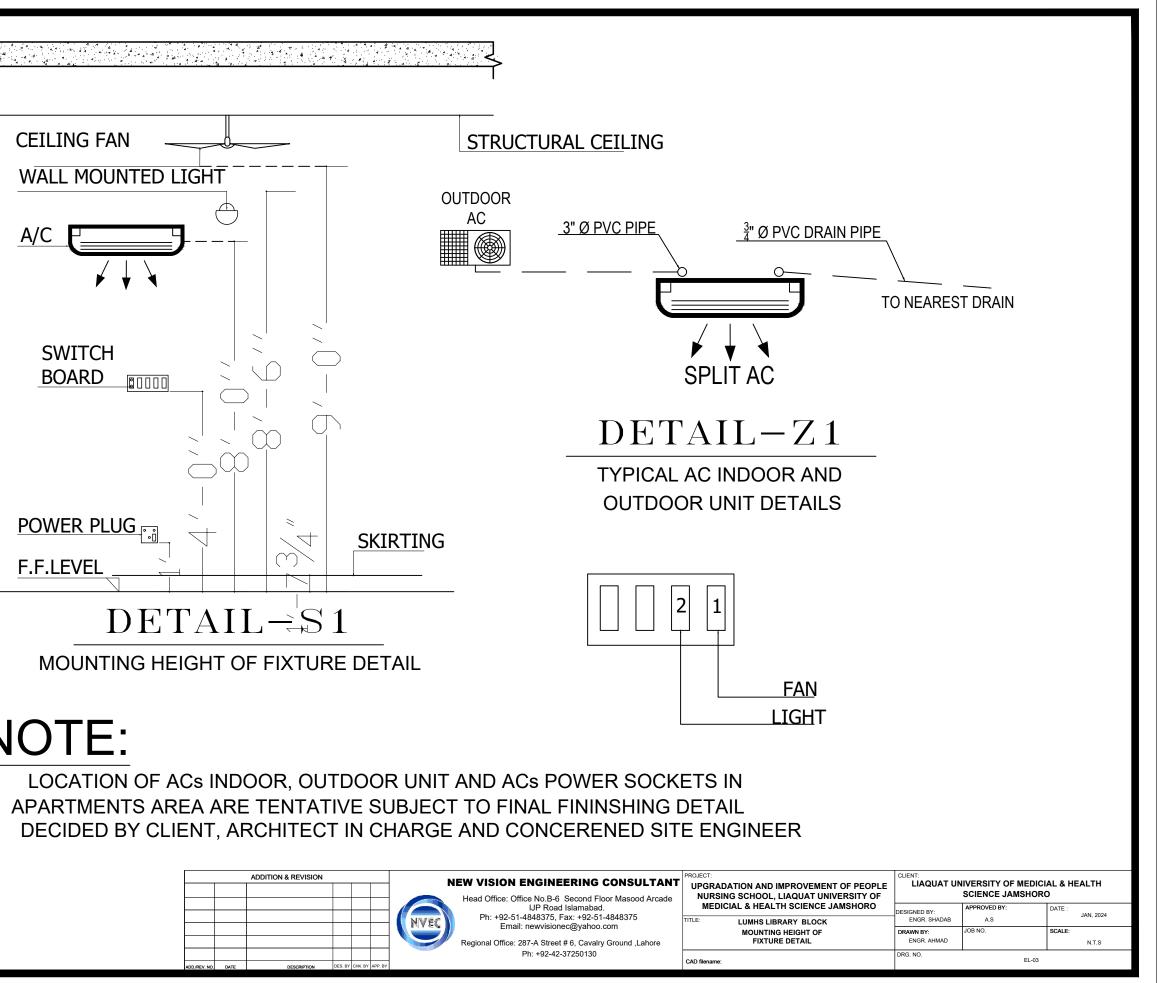



S.N	C SYMBOLS	DESCRIPTION
1	FACP	FIRE ALARM CONTROL PANEL
2	SD	SMOKE DETECTOR NON IONISATION TYPE.
3	M & S	MANUAL STATION & ALARM SOUNDER

		ADDITION & REVISION					PROJECT:
						Head Office: Office No.B-6 Second Floor Masood Arcade UP Road Islamabad. Ph: +92-51-4848375, Fax: +92-51-4848375 Email: newvisionec@yahoo.com Regional Office: 287-A Street # 6, Cavalry Ground ,Lahore Ph: +92-42-37250130	UPGRADATION AND IMPROVEMENT NURSING SCHOOL, LIAQUAT UNIV MEDICIAL & HEALTH SCIENCE J/ TITLE: LUMHS LIBRARY BLOCK LEGEND AND SYMBOLS
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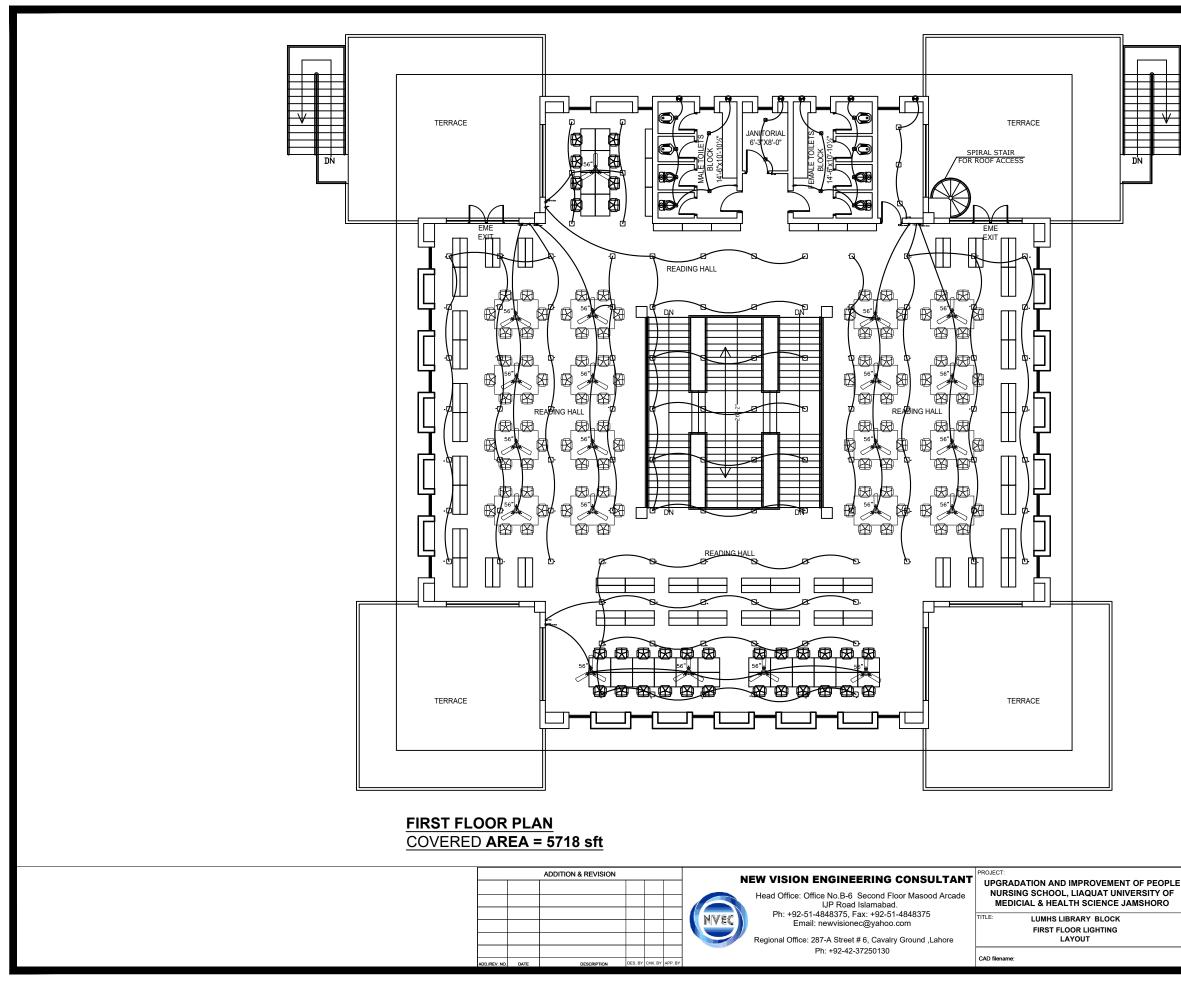




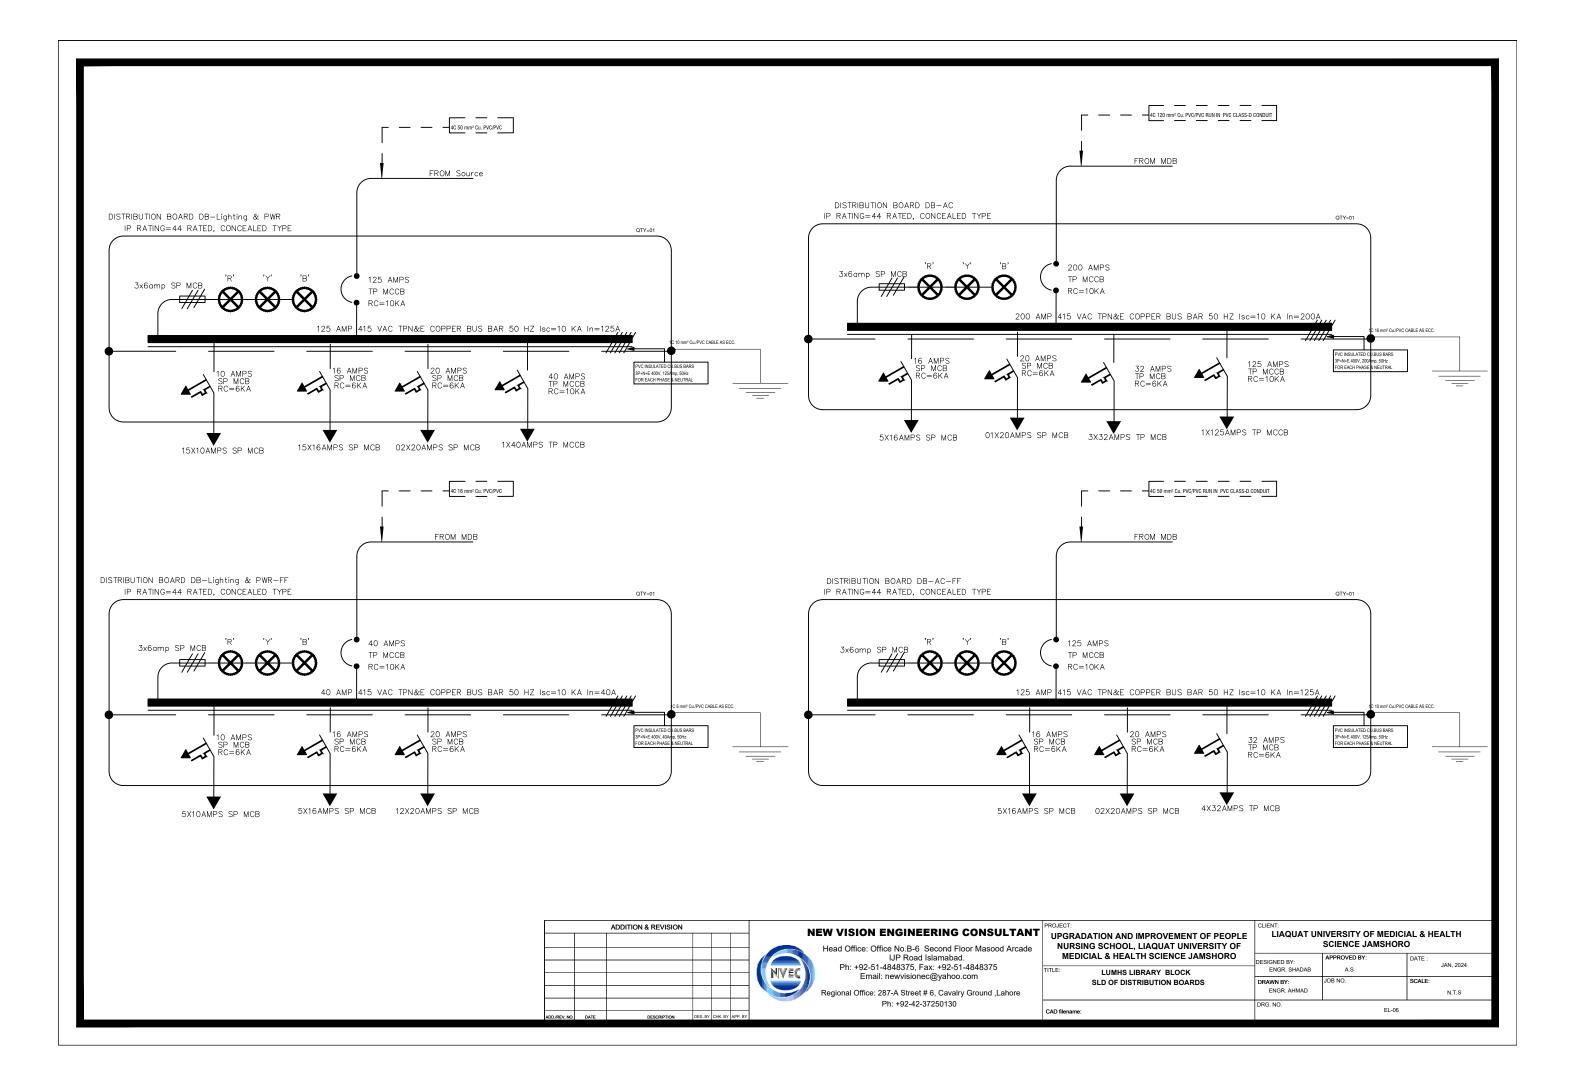


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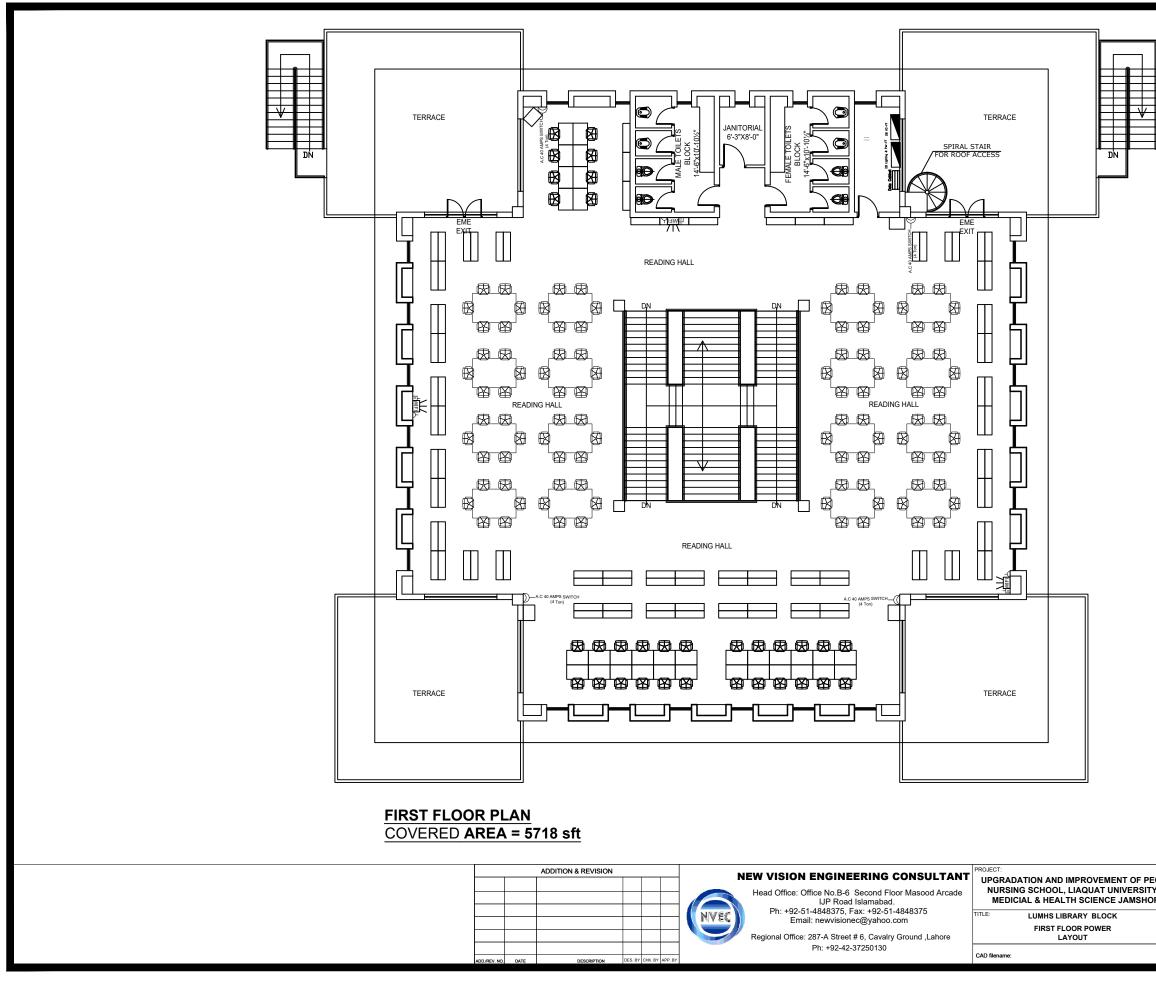
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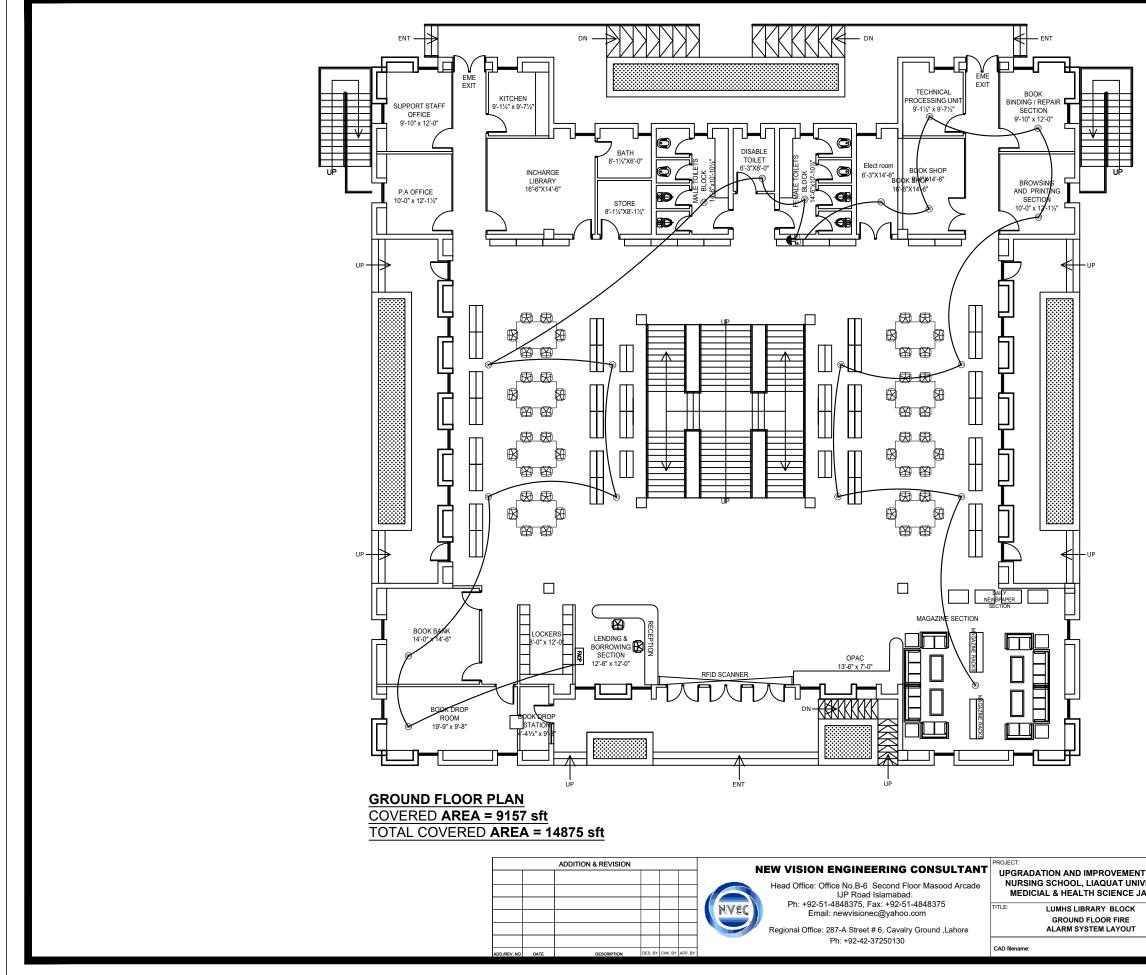
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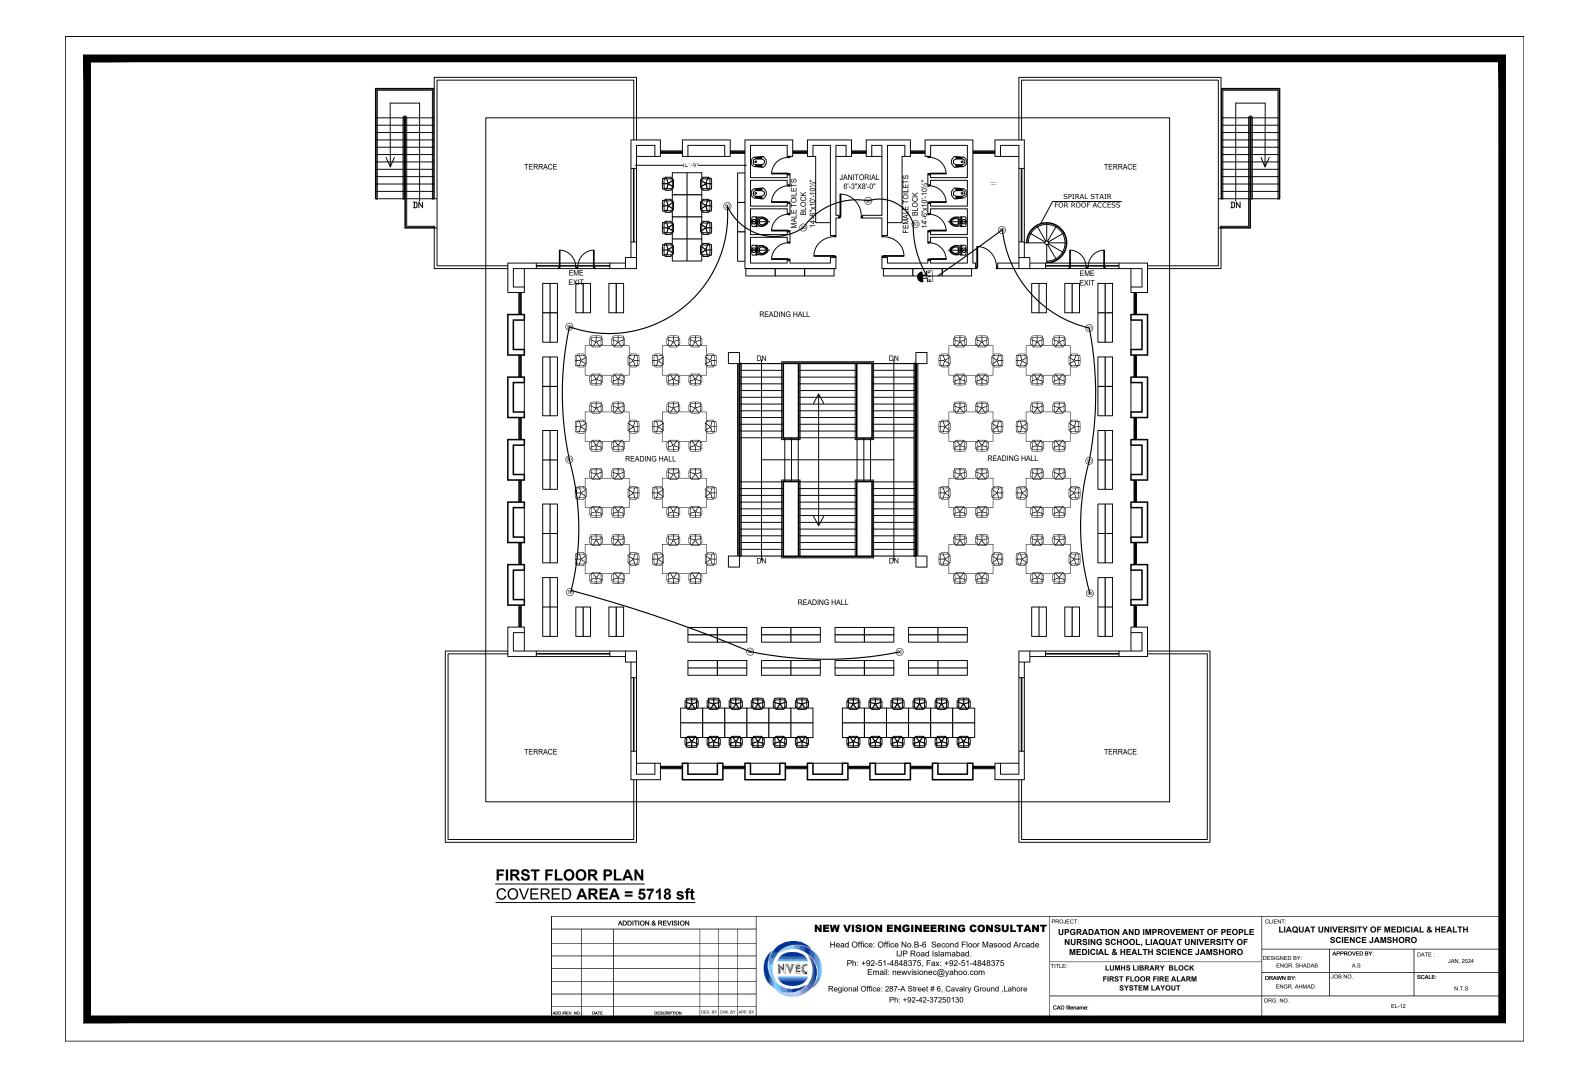
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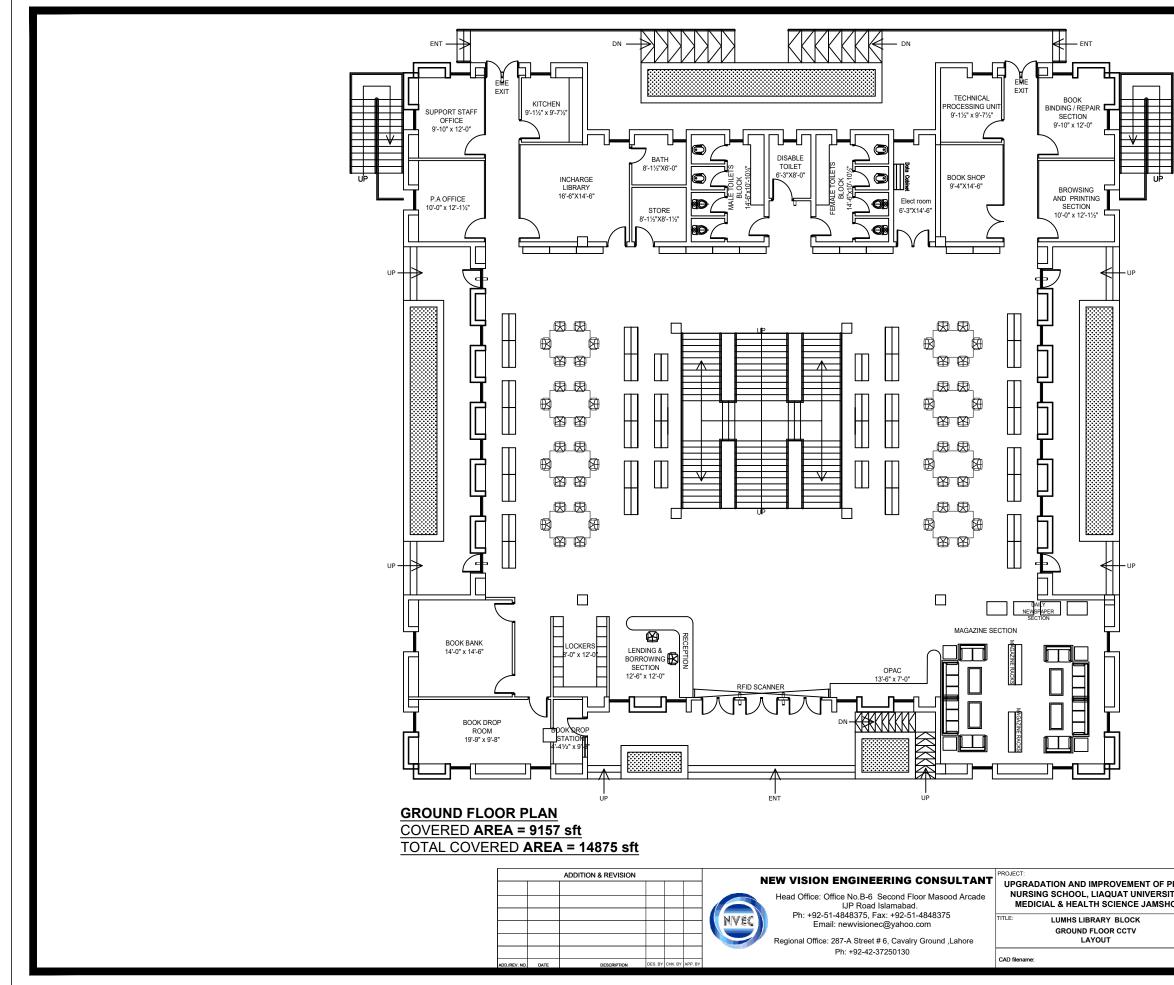

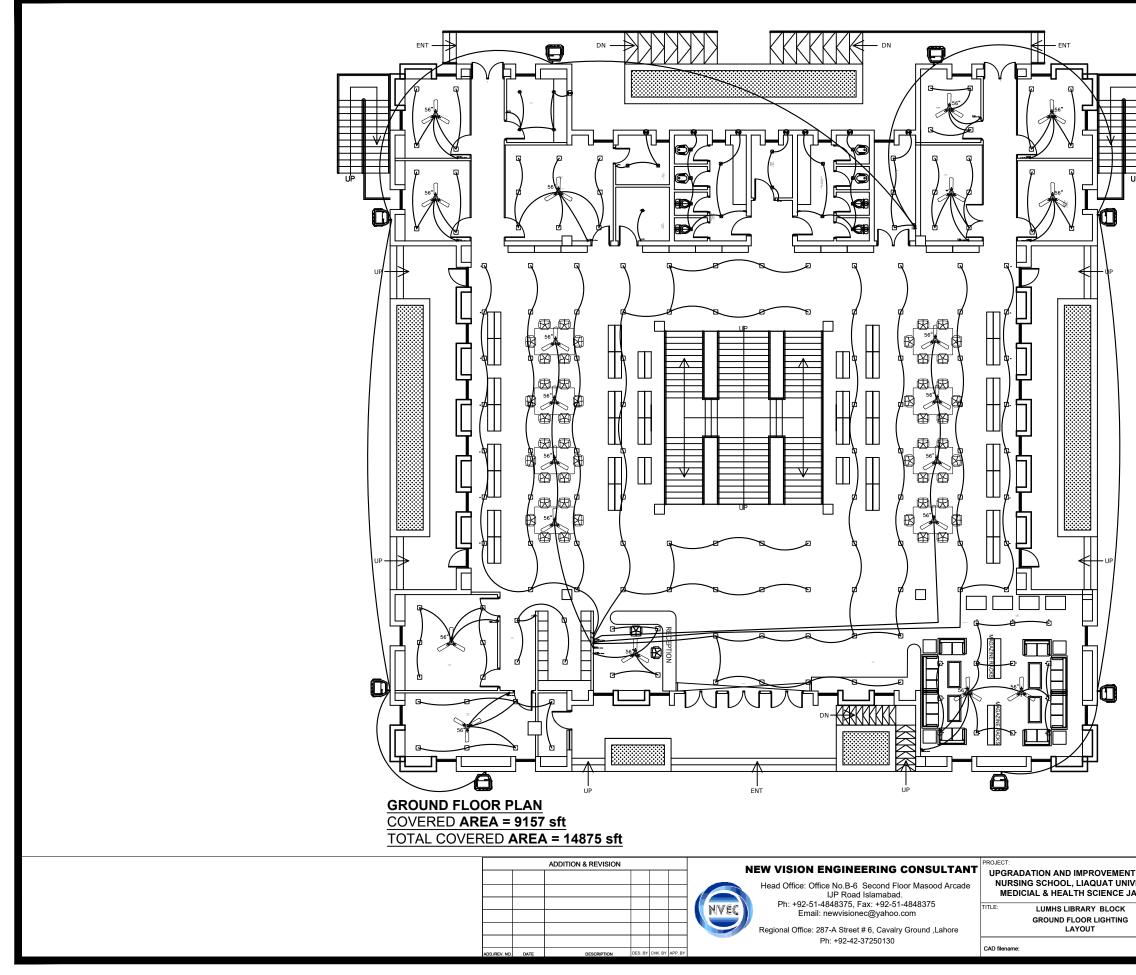
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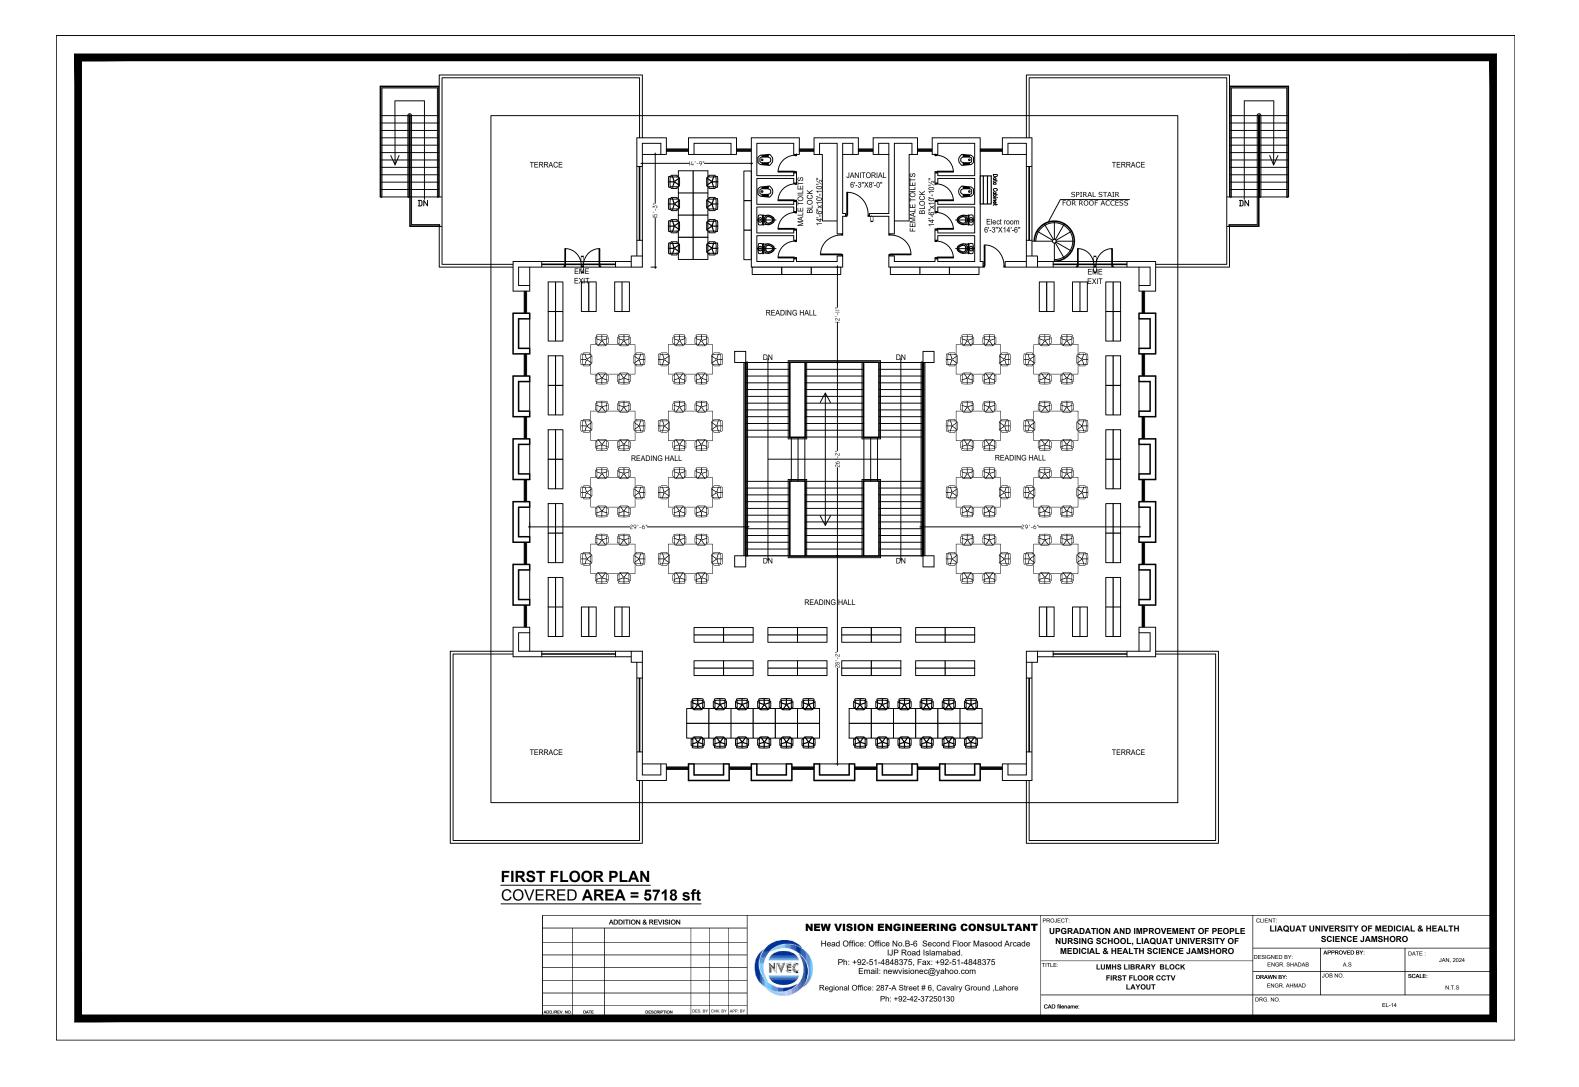


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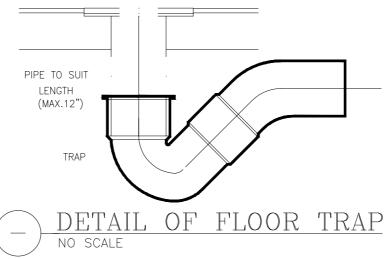
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IGINEERING CONSULTANT B-6 SECOND FLOOR Masood Arcade	PROJECT: UPGRADATION AND IMPROVEMENT OF PEOPLE NURSING SCHOOL, LIAQUAT UNIVERSITY OF	CLIENT: LIAQUAT UN	NIVERSITY OF MEDICI. SCIENCE JAMSHORO	
P Road Islamabad. 848375, Fax: +92-51-4848375	MEDICIAL & HEALTH SCIENCE JAMSHORO	DESIGNED BY: AHMED JANGANHEER	APPROVED BY:	DATE : FEB,2024
ewvisionec@yahoo.com -A Street # 6, Cavalry Ground ,Lahore h: +92-42-37250130	LIST OF DRAWINGS	DRAWN BY: HANIF	JOB NO.	SCALE: N.T.S
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<u>GENERAL NOTES.</u>


- 1 PIPE PASSING THROUGH WALL, FLOOR OR ROOF SHALL BE PROTECTED WITH SLEEVES
- 2 PIPE SIZES & DIMENSIONS ARE IN INCHES, UNLESS OTHERWISE MENTIONED
- 3 PLUMBING SERVICES, SHALL BE CO-ORDINATED WITH OTHER SERVICES SUCH AS ELECTRICAL, ETC. TO AVOID CONFLIT OR INTERFERENCE WITH THEM.
- 4 SIZE OF FLOOR DRAIN UNLESS OTHERWISE STATED SHALL BE SAME AS THE SIZE OF OUTLET DRAIN PIPE.
- 5 WHEREVER FLOOR DRAIN/TRAP IS SHOWN, SLOPE FLOOR TOWARDS DRAIN/TRAP.
- 6 HORIZONTAL DRAINAGE PIPING OF 3 INCH DIAMETER & LESS SHALL BE INSTALLED WITH A SLOPE OF NOT LESS THEN 1/4 INCH PER FOOT, LARGER ONES WITH A SLOPE OF NOT LESS THAN 1/8 INCH PER FOOT.
- 7 EXTENSION OF VENT PIPES THROUGH A ROOF SHALL BE TERMINATED AT LEAST 6 INCHES ABOVE FINISHED ROOF LEVEL. EACH VENT TERMINAL SHALL BE MADE WATER TIGHT WITH THE ROOF BY PROPER FLASHING
- 8 SIZE OF ANYTHING GIVEN ON PLUMBING DRAWING MEANS ITS CLEAR DIMENSIONS (CAPACITY), UNLESS OTHERWISE MENTIONED.
- 9 THE "VERTICAL DISTANCE" FROM FIXTURE OUTLET TO THE TRAP WEIR SHALL PREFERABLY BE NOT MORE THAN 12 INCHES. HOWEVER, THIS "VERTICAL DISTANCE" FROM THE FIXTURE OUTLET TO THE TRAP WEIR SHALL NOT EXCEED 24 INCHES.
- 10 WHERE THE CHANGE OF DIRECTION IS 45° OR LESS, IT IS NOT NECESSARY TO PROVIDE A CLEAN OUT. BUT WHEN THE CHANGE IN DIRECTION IS MORE THAN 45°, A CLEAN OUT SHOULD BE REQUIRED.
- 11 ALL TRAPS AND FLOOR DRAINS SHALL HAVE A WATER SEAL NOT LESS THAN 2 INCHES.
- 12 (EXTERNAL SERVICES) THE BOTTOM OF WATER-SERVICES PIPE, AT ALL POINTS, SHALL BE AT LEAST 12 INCHES ABOVE THE TOP OF THE SEWER LINE AT ITS HIGHEST POINT.
- 13 NO "T" FITTING IS ALLOWED IN SANITARY DRAINAGE LAYOUT. USE ONLY "Y" FITTINGS.

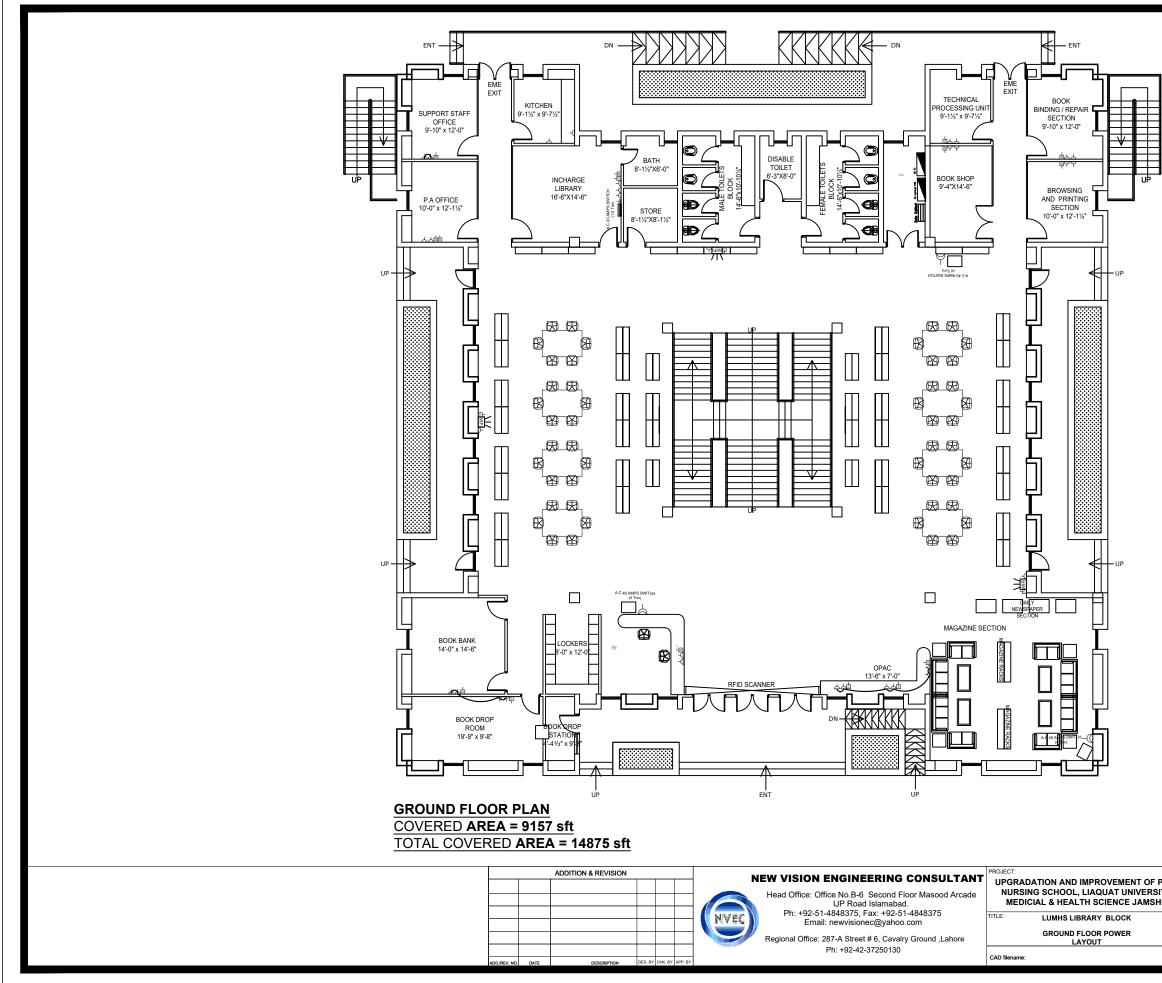ABBREV.	DESCRIPTION
SP	SOIL PIPE
WP	WASTE PIPE
SS	SOIL STACK
WS	WASTE STACK
VP	VENT PIPE
VS	VENT STACK
T/A	TO ABOVE
F/A	FROM ABOVE
T/B	TO BELOW
F/B	FROM BELOW
	STRAINER




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					IJP Road Islamabad.		MEDICIAL & HEALTH SCIENCE JAMSHORO	DESIGNED BY:		DATE :	
				NVEC	Ph: +92-51-4848375, Fax: +92-51-4848375 Email: newvisionec@yahoo.com	TI	ITLE:	AHMED JANGANHEER		FE	EB,2024
					Regional Office: 287-A Street # 6, Cavalry Ground ,Lahore			DRAWN BY:	JOB NO.	SCALE:	
					Ph: +92-42-37250130		GENERAL NOTES	HANIF		N.	T.S
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TABLE-1

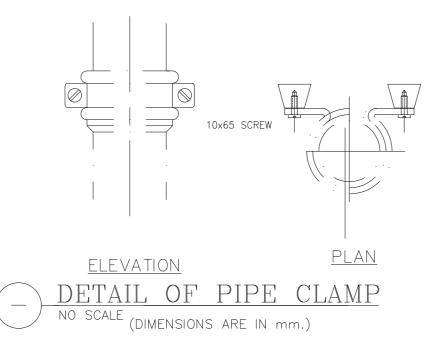

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-	ABLE-2
ABBREV.	DESCRIPTION
GV	GATE VALVE
WP	WASTE PIPE
SP	SOIL PIPE
HS	HAND SHOWER
G.T	GULLY TRAP
Gr.T	GREASE INTERCEPTOR
MFT	MULTI FLOOR TRAP
<u>FT</u>	FLOOR TRAP
O.H.W.T	OVERHEAD WATER TANK
U.G.W.T	UNDERGROUND WATER TANK
WC	WATER CLOSD
SH	SHOWER
T/A	TO ABOVE
F/A	FROM ABOVE
T/B	TO BELOW
F/B	FROM BELOW




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Head Office: Of Ph: +9 E Regional Office	APP. BY	СЫК ВУ		DESCRIPTION	DATE	ADD/REV. NO.
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IJP Road Islamabad.	MEDICIAL & HEALTH SCIENCE JAMSHORO	DESIGNED BY:	APPR
2-51-4848375, Fax: +92-51-4848375	TITLE:	AHMED JANGANHEER	
mail: newvisionec@yahoo.com	GROUND FLOOR PLAN	DRAWN BY:	JOB N

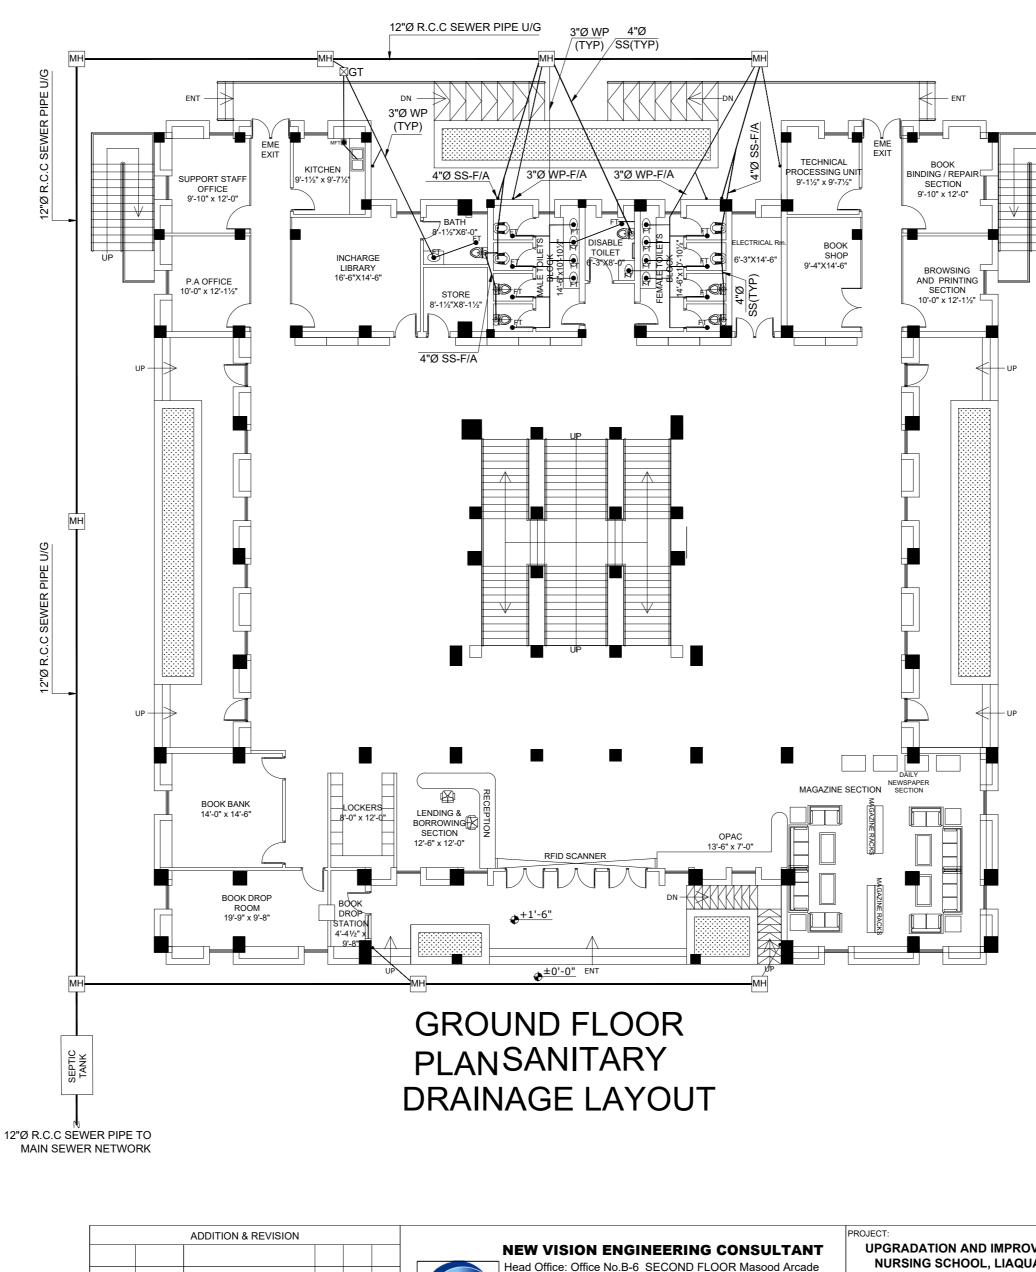fice: 287-A Street # 6, Cavalry Ground ,Lahore Ph: +92-42-37250130

JKUUND FLUUF SANITARY DRAINAGE LAYOUT


≣	CLIENT: LIAQUAT UNIVERSITY OF MEDICIAL & HEALTH SCIENCE JAMSHORO						
	DESIGNED BY:	APPROVED BY:	DATE :				
	AHMED JANGANHEER			FEB,2024			
	DRAWN BY:	JOB NO.	SCALE:				
	HANIF			N.T.S			
	DRG. NO.	PL-02					

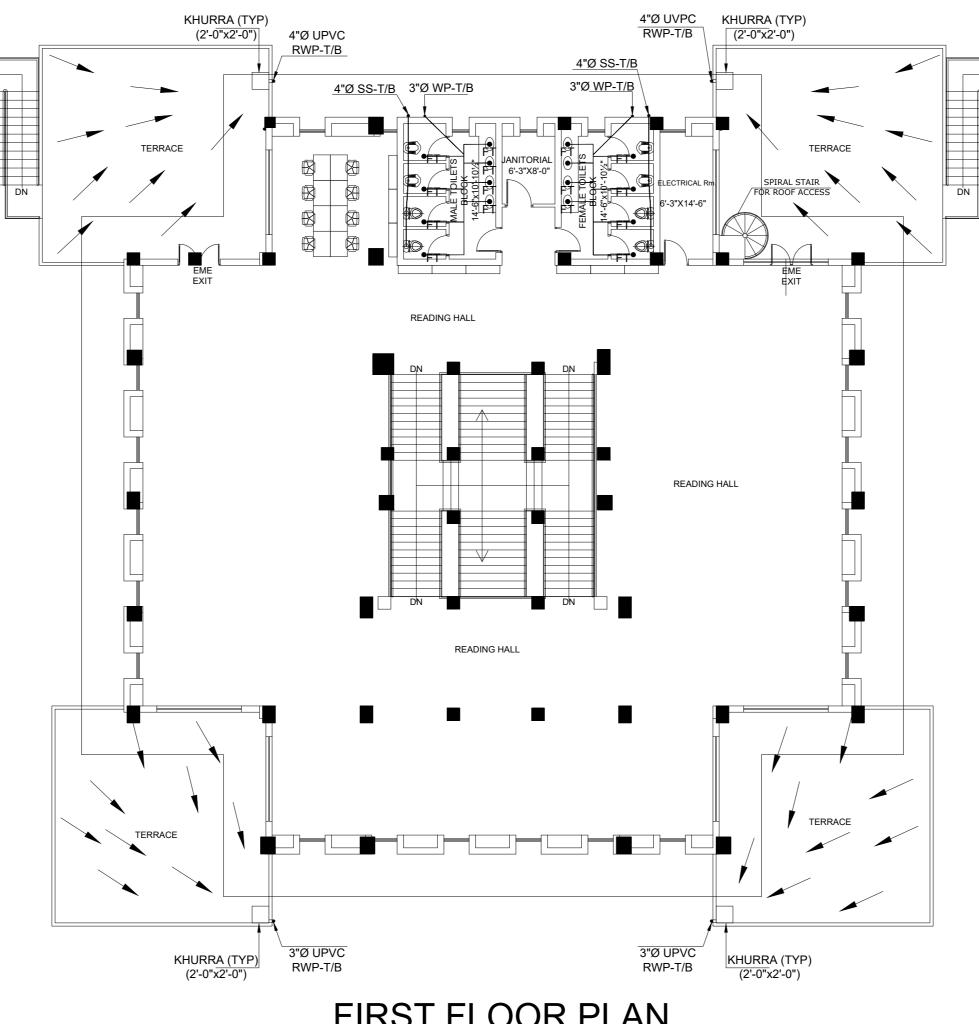

FIRST FLOOR PLAN SANITARY DRAINAGE LAYOUT

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					NVEC	IJP Road Islamabad. Ph: +92-51-4848375, Fax: +92-51-4848375 Email: newvisionec@yahoo.com Regional Office: 287-A Street # 6, Cavalry Ground ,Lahore Ph: +92-42-37250130	MEDICIAL & HEALTH SCIENCE JAMSHORO	DESIGNED BY: AHMED JANGANHEER DRAWN BY: HANIF	JOB NO.	DATE : FEB,2024 SCALE: N.T.S
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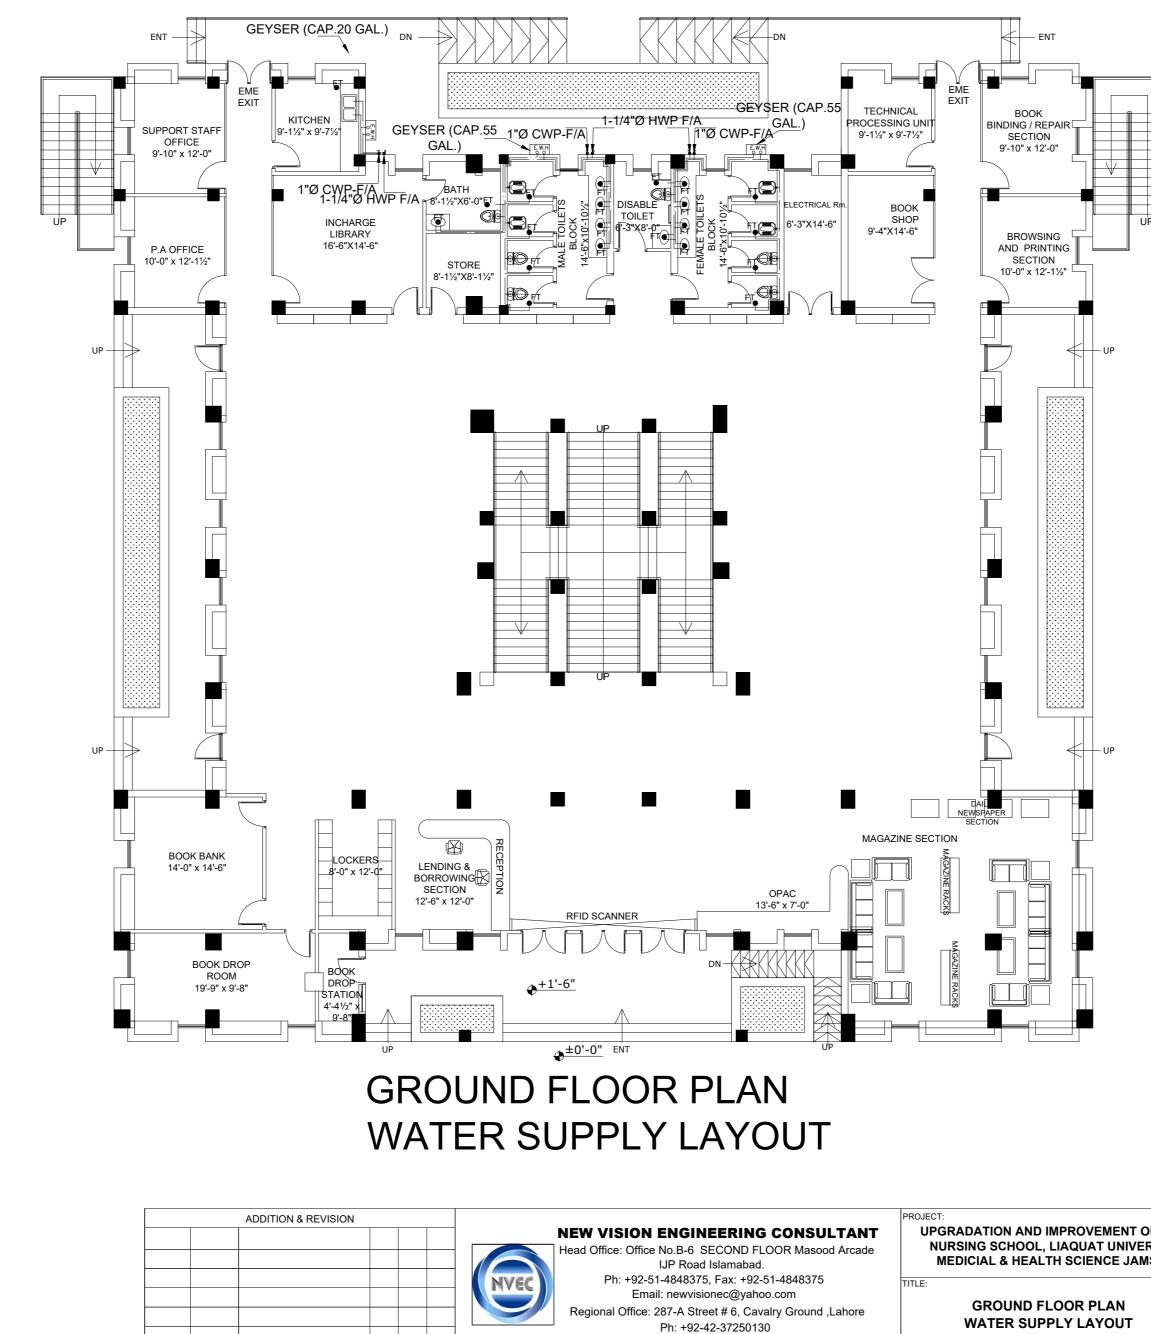


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ENGINEERING CONSULTANT No.B-6 SECOND FLOOR Masood Arcade	PROJECT: UPGRADATION AND IMPROVEMENT OF PEOPLE NURSING SCHOOL, LIAQUAT UNIVERSITY OF	CLIENT: LIAQUAT UNIVERSITY OF MEDICIAL & HEALTH SCIENCE JAMSHORO			
IJP Road Islamabad. 1-4848375, Fax: +92-51-4848375 ill: newvisionec@yahoo.com	MEDICIAL & HEALTH SCIENCE JAMSHORO	DESIGNED BY: AHMED JANGANHEER DRAWN BY:	APPROVED BY: JOB NO.	DATE : FEB,2024 SCALE:	
287-A Street # 6, Cavalry Ground ,Lahore Ph: +92-42-37250130	SANITARY DRAINAGE LAYOUT	HANIF DRG. NO.	PL-04	N.T.S	

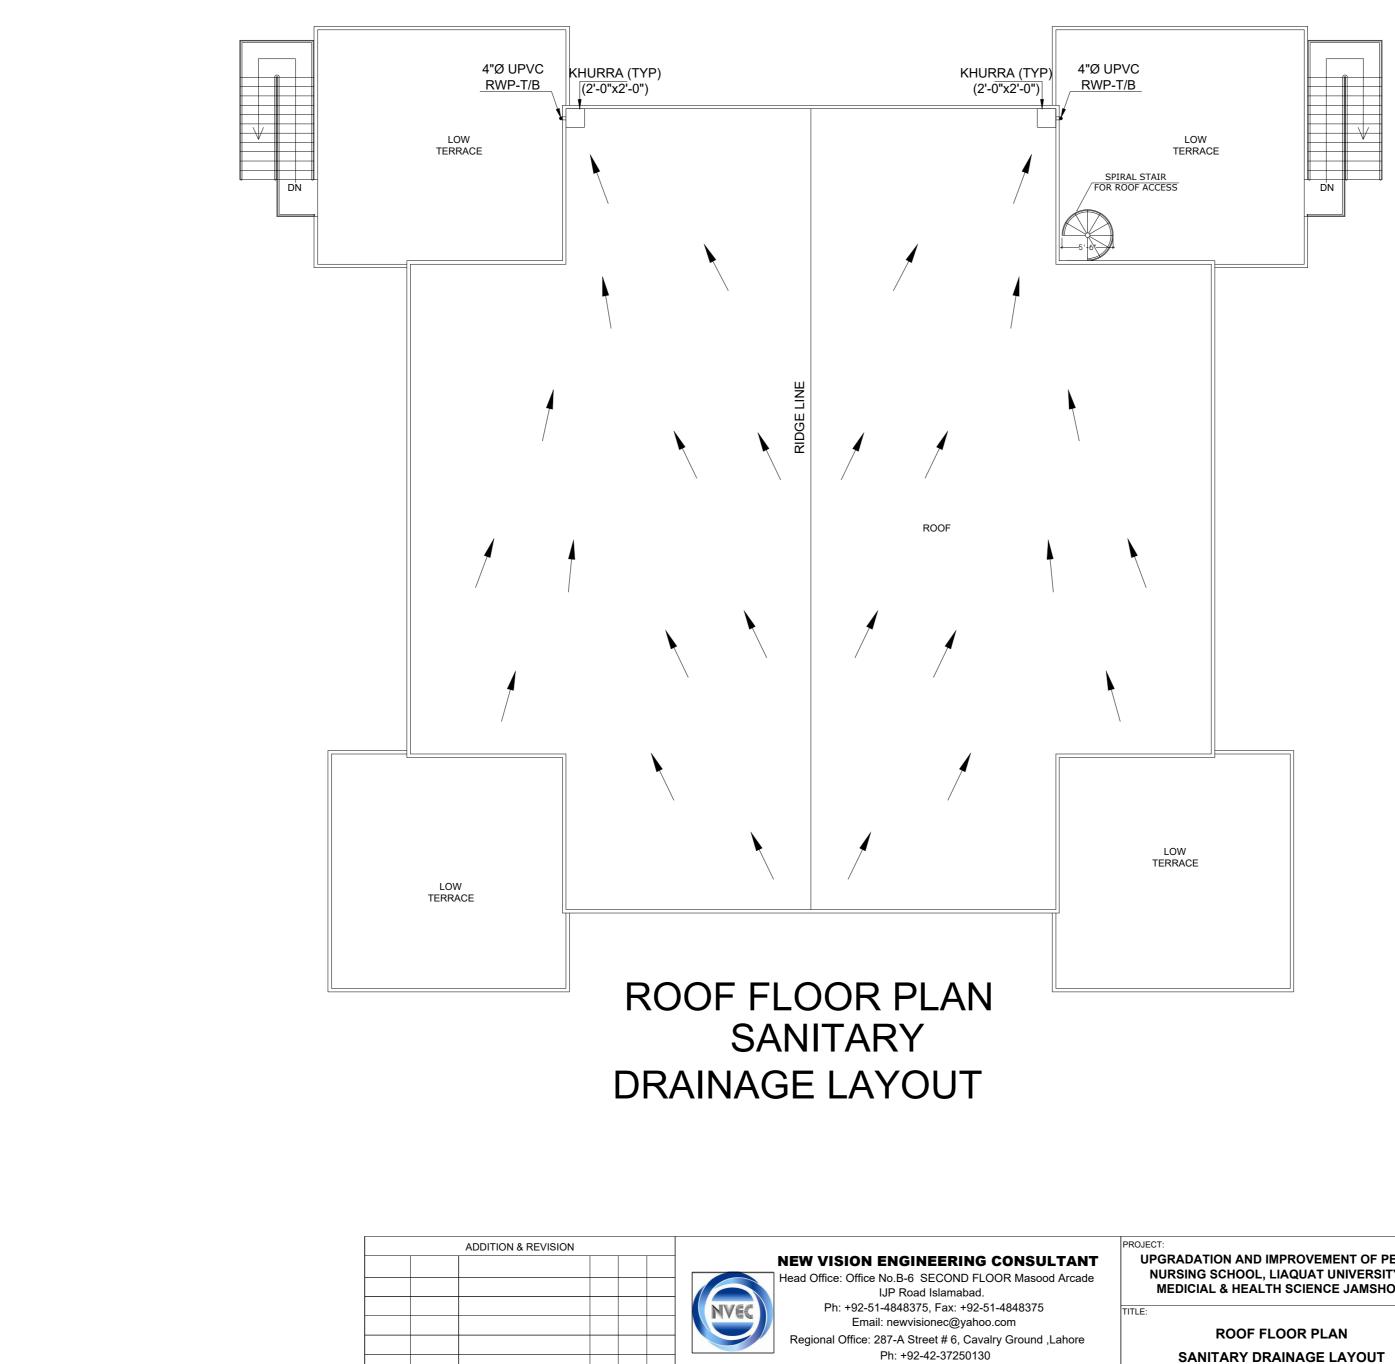


ADD./REV. NO. DATE

DESCRIPTION

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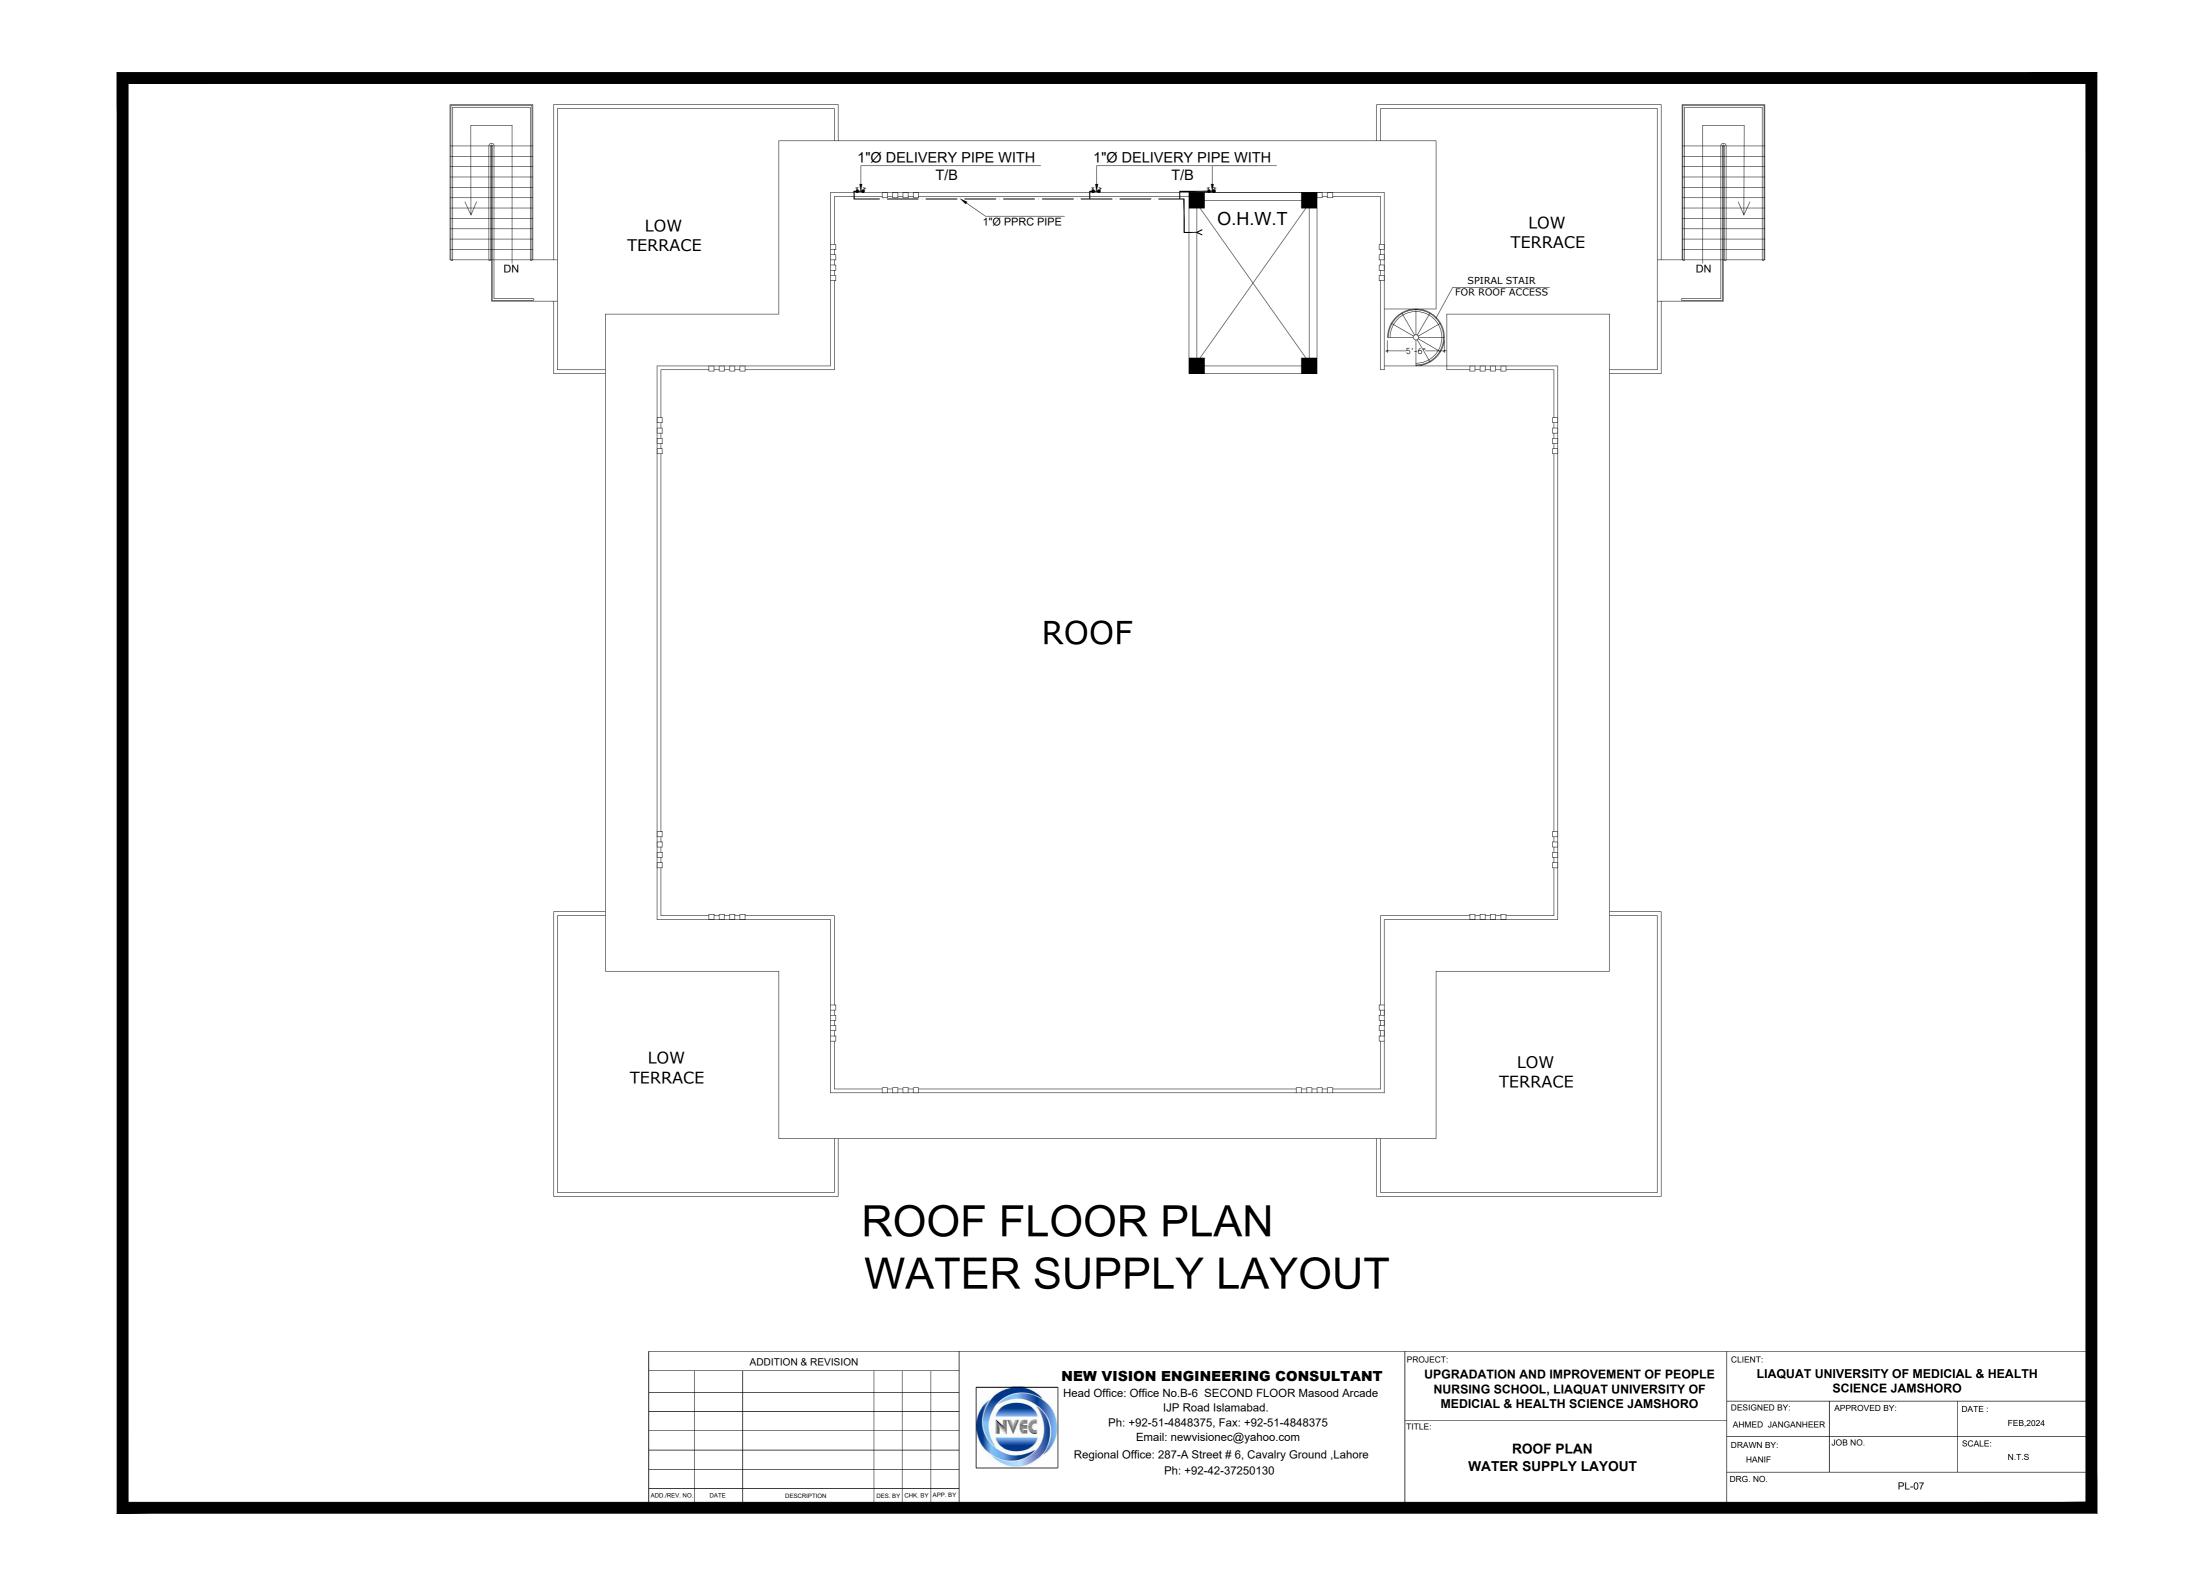
UPGRADATION AND IMPROVEMENT OF PEOPLE NURSING SCHOOL, LIAQUAT UNIVERSITY OF MEDICIAL & HEALTH SCIENCE JAMSHORO


CLIENT: LIAQUAT UNIVERSITY OF MEDICIAL & HEALTH SCIENCE JAMSHORO					
DESIGNED BY:	APPROVED BY:	DATE :			
AHMED JANGANHEER			FEB,2024		
DRAWN BY: HANIF	JOB NO.	SCALE:	N.T.S		
DRG. NO.	PL-05				

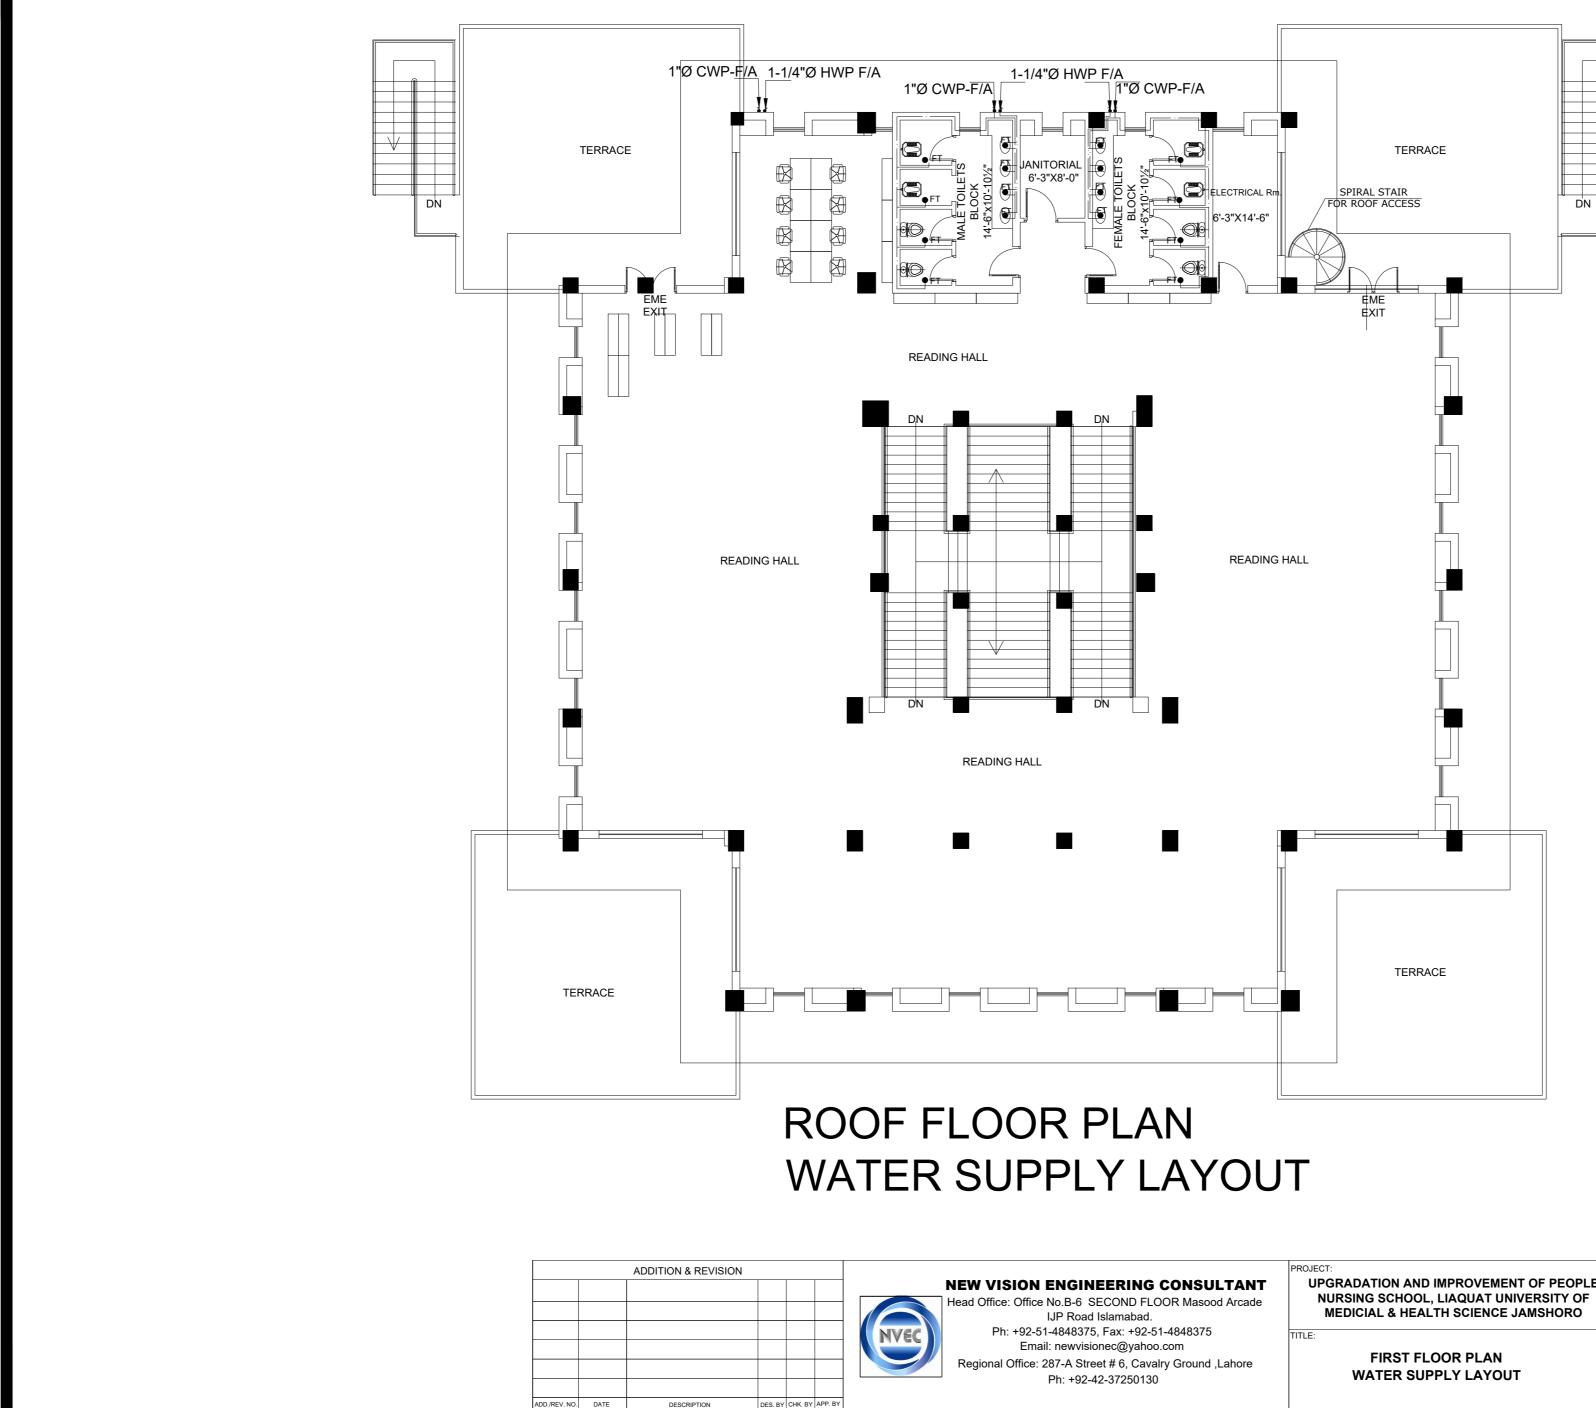


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E	CLIENT: LIAQUAT UNIVERSITY OF MEDICIAL & HEALTH SCIENCE JAMSHORO					
	DESIGNED BY: AHMED JANGANHEER	APPROVED BY:	DATE :	FEB,2024		
	DRAWN BY: HANIF	JOB NO.	SCALE:	N.T.S		
	DRG. NO.	PL-06				





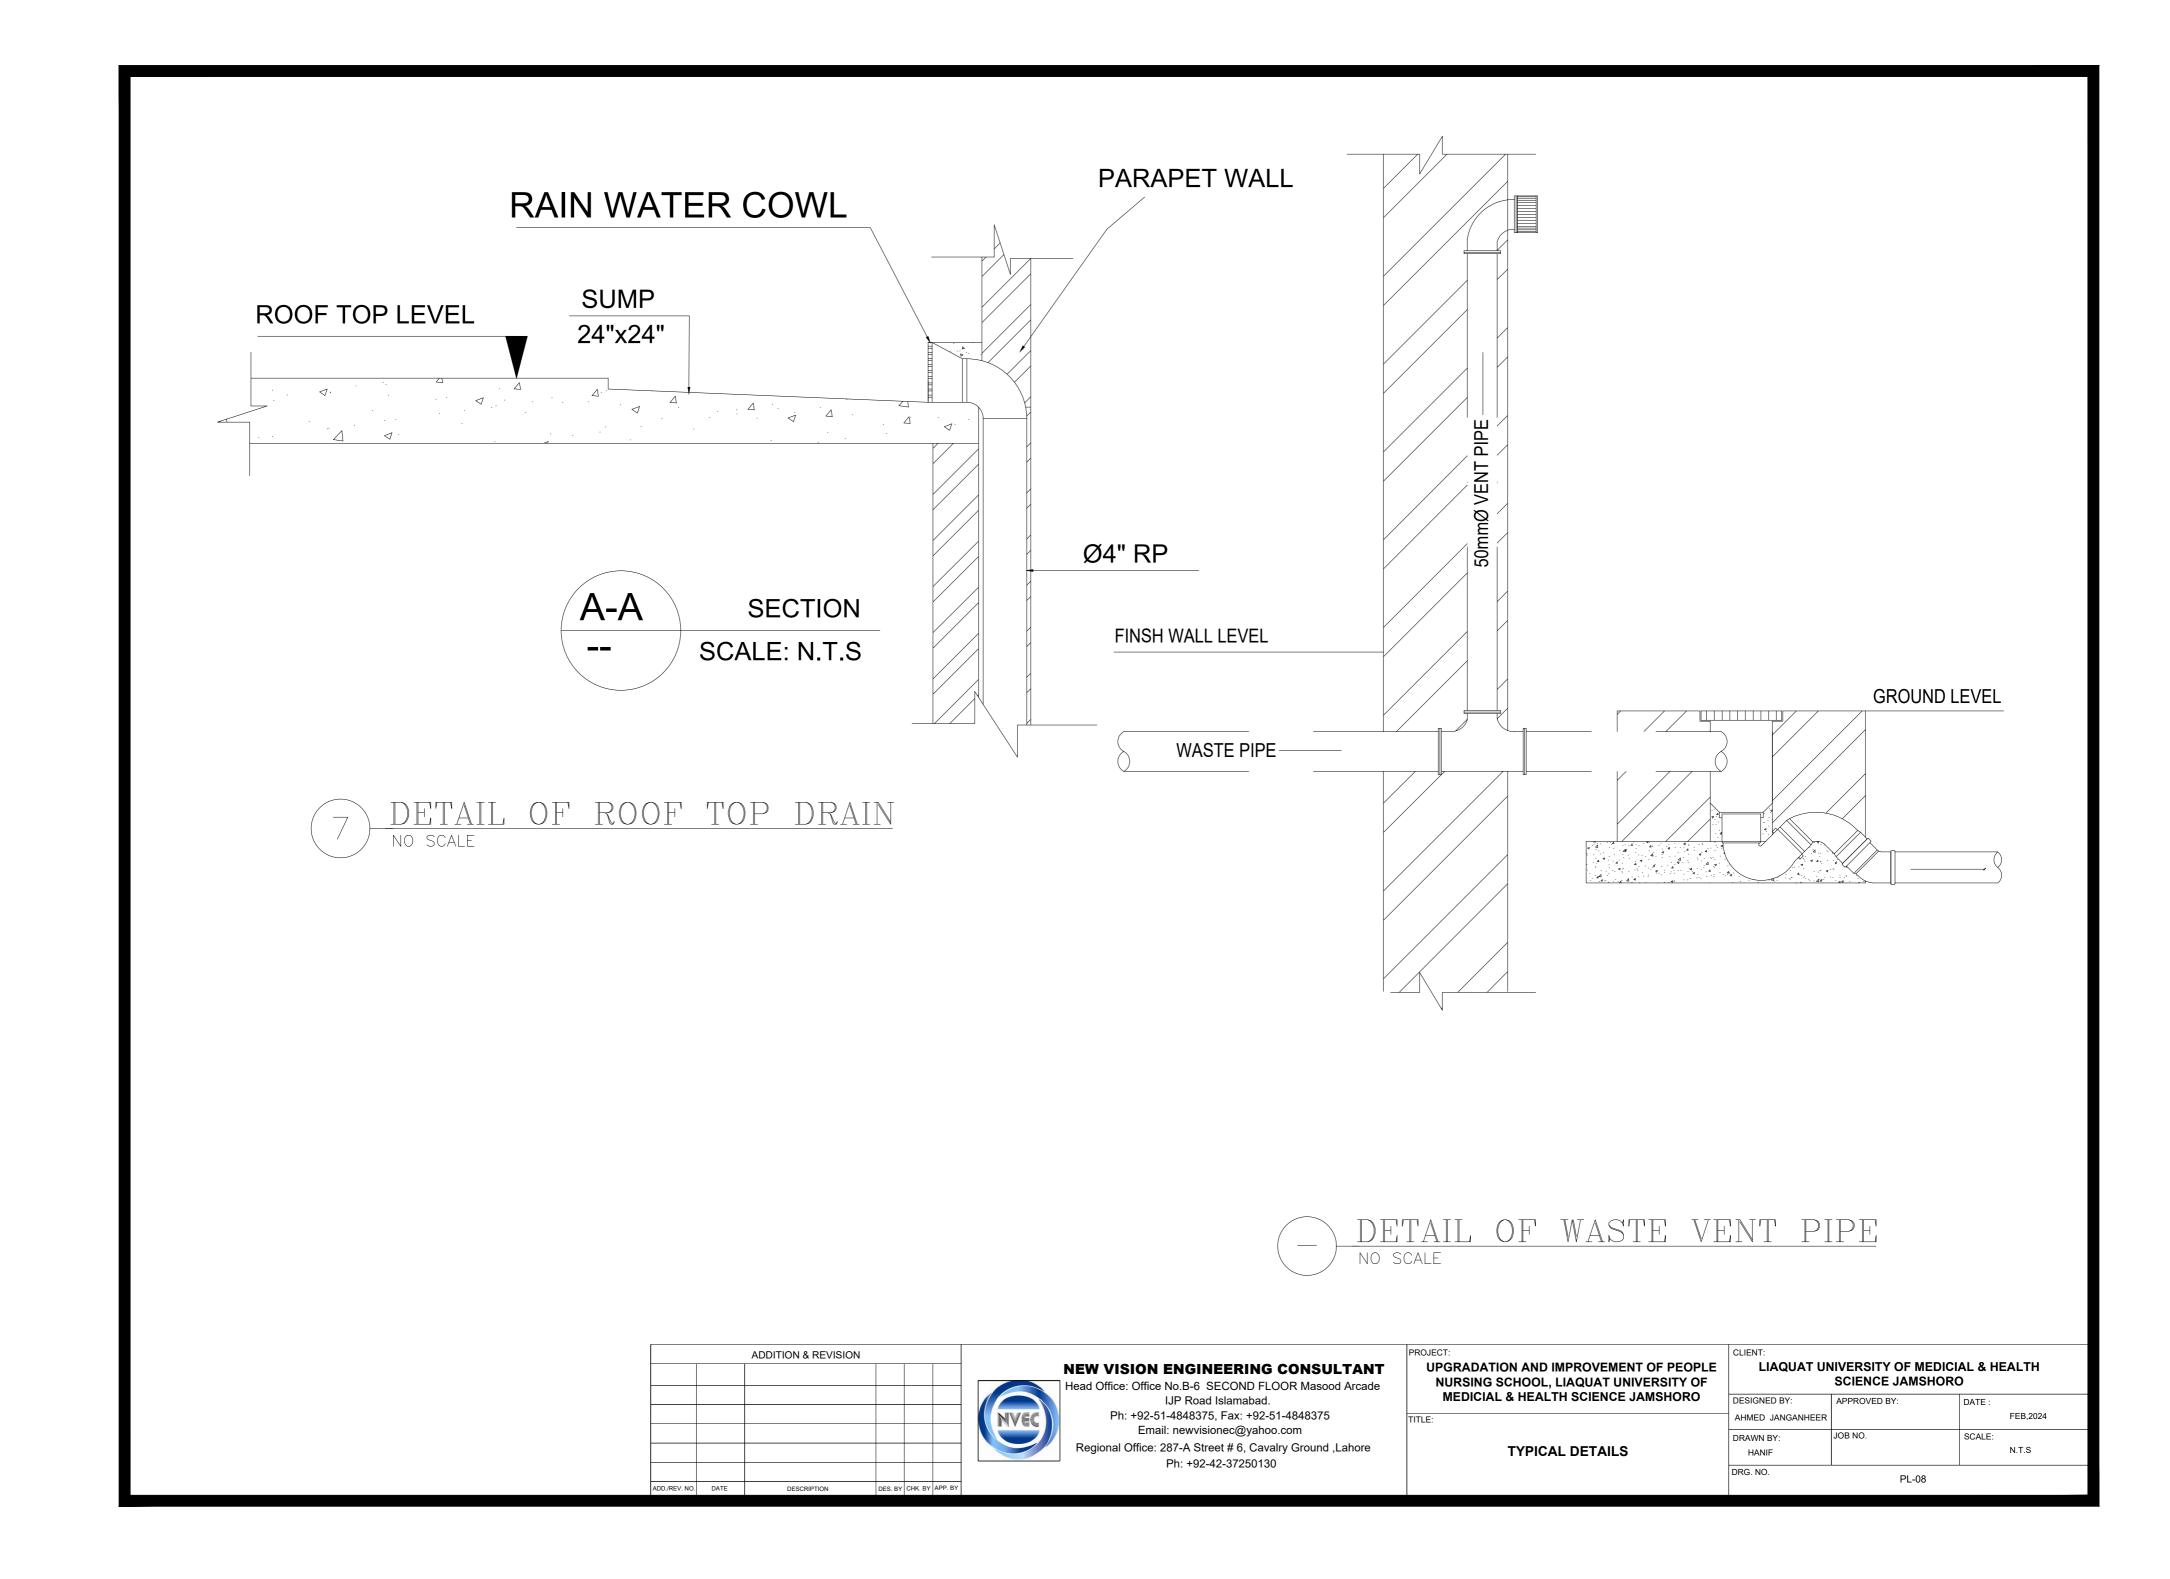
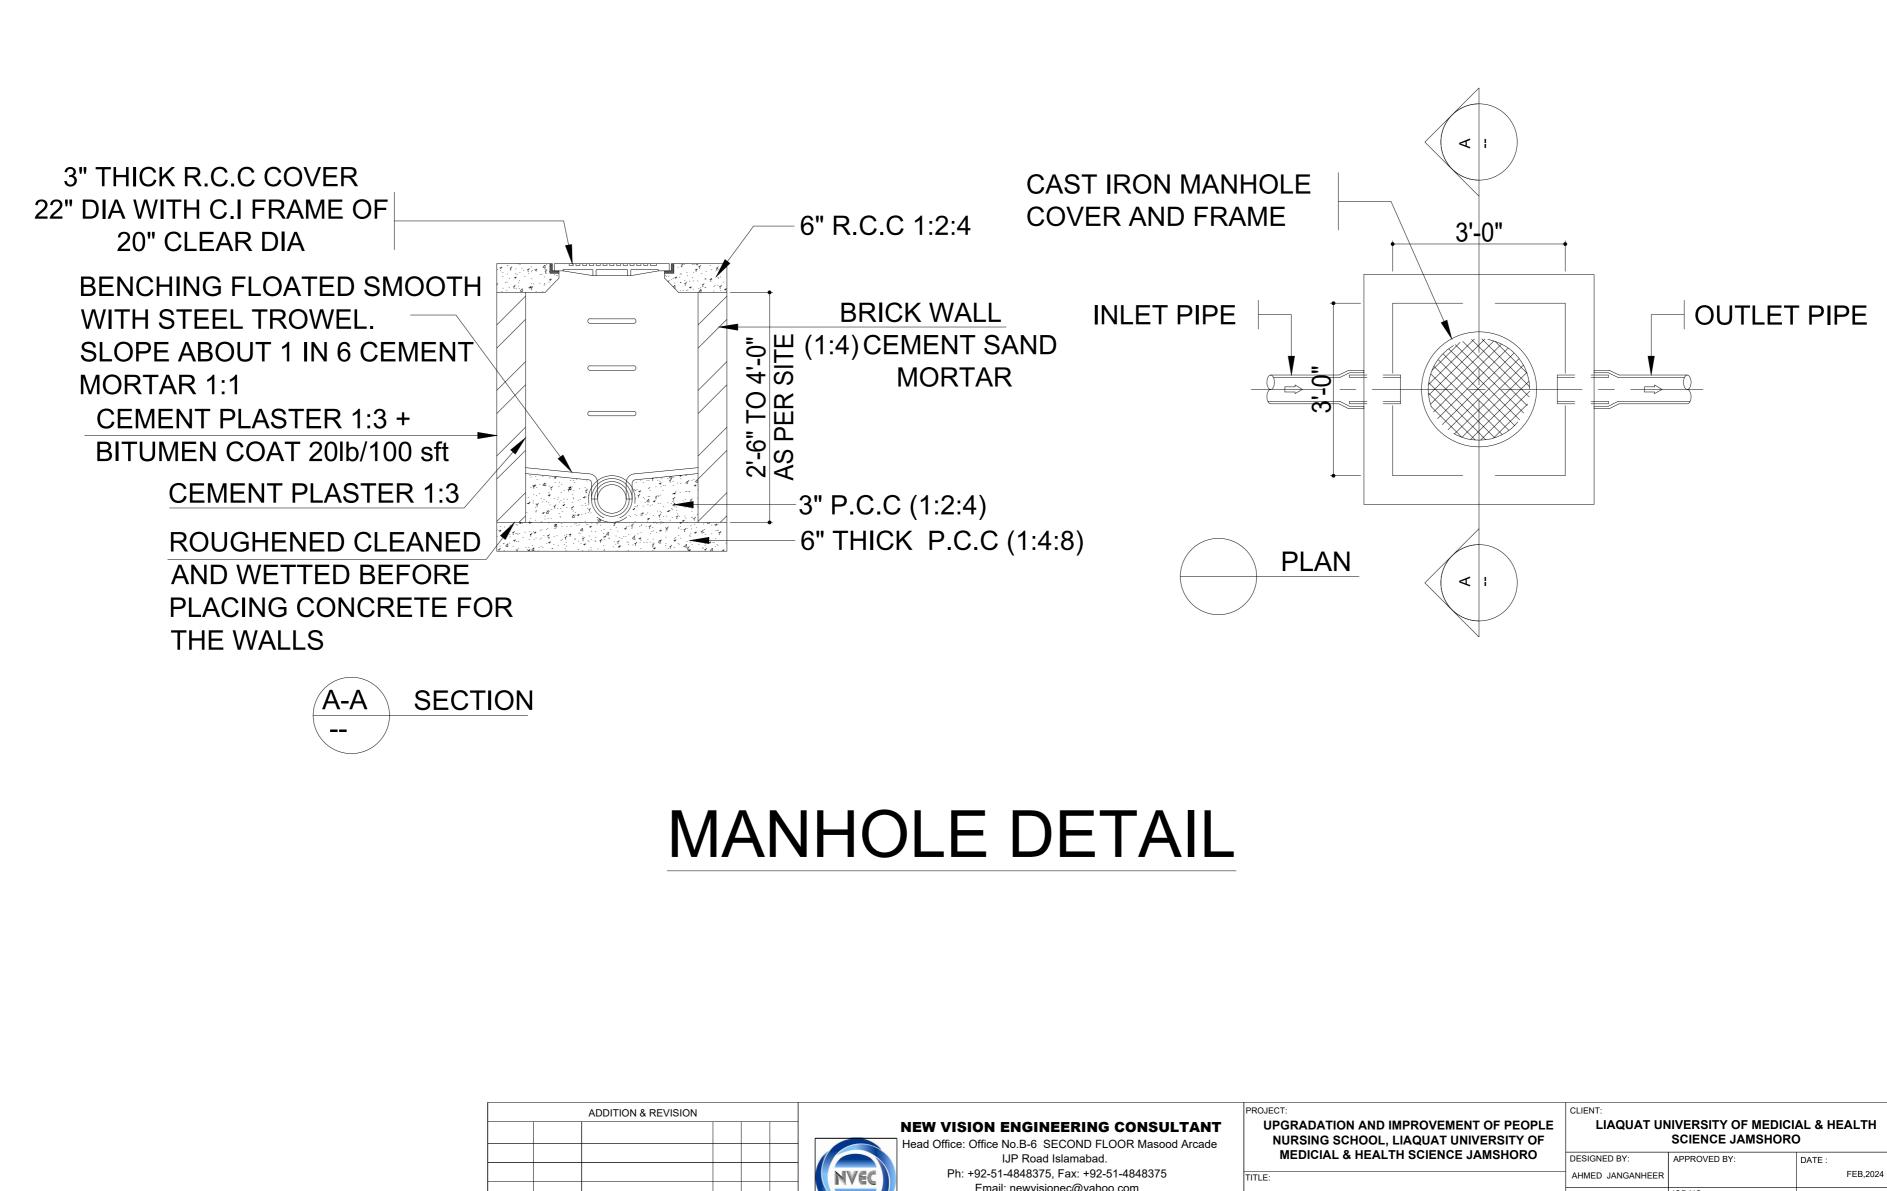
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DESCRIPTION

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Email: newvisionec@yahoo.com Regional Office: 287-A Street # 6, Cavalry Ground ,Lahore Ph: +92-42-37250130

TYPICAL DETAILS

SCIENCE JAMSHORO				
DESIGNED BY:	APPROVED BY:	DATE :		
AHMED JANGANHEER			FEB,2024	
DRAWN BY:	JOB NO.	SCALE:		
HANIF			N.T.S	
DRG. NO.	PL-09			