

LIAQUAT UNIVERSITY OF MEDICIAL & HEALTH **SCIENCE JAMSHORO**

UPGRADATION AND IMPROVEMENT OF PEOPLE NURSING SCHOOL, LIAQUAT UNIVERSITY OF **MEDICIAL & HEALTH SCIENCE JAMSHORO**

LUMHS CAFETERIA TENDER DRAWINGS MARCH, 2024

DESIGN BY



NEW VISION ENGINEERING CONSULTANT


HEAD OFFICE:

Office No.B-6 Second Floor Masood Arcade 287-A Street # 6, IJP Road Islamabad. Cavalry Ground ,Lahore Ph: +92-51-4848375, Fax: +92-51-4848375 Ph: +92-42-37250130

Email: newvisionec@yahoo.com


REGIONAL OFFICE:

ARCHITECTURE DRAWIMGS				
S.NO.	LIST OF DRAWINGS	LS-00		
1	MASTER PLAN	MP-01		
2	3D VIEW 01	3D-01		
3	3D VIEW 02	3D-02		
4	GROUND FLOOR PLAN	AR-01		
5	ROOF TOP PLAN	AR-02		
6	ELEVATION E1	AR-03		
7	ELEVATION E2	AR-04		
8	ELEVATION E3	AR-05		
9	ELEVATION E4	AR-06		
10	SECTION AT A	AR-07		
11	SCHEDULE OF OPENINGS	AR-08		
12	DOOR & WINDOW ELEVATIONS	AR-09		
13	FINISH FLOOR DETAIL	AR-10		

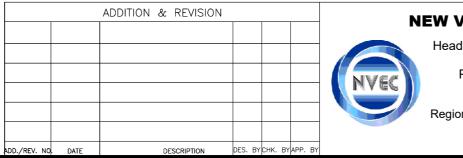

VISION ENGINEERING CONSULTANT ad Office: Office No.B-6 Second Floor Masood Arcade IJP Road Islamabad. Ph: +92-51-4848375, Fax: +92-51-4848375 Email: newvisionec@yahoo.com ional Office: 287-A Street # 6, Cavalry Ground ,Lahore Ph: +92-42-37250130	PROJECT: UPGRADATION AND IMPROVEMENT OF PEOPLE NURSING SCHOOL, LIAQUAT UNIVERSITY OF MEDICIAL & HEALTH SCIENCE JAMSHORO	CLIENT: LIAQUAT UNI	VERSITY OF MEDICIAL & HE JAMSHORO	ALTH SCIENCE
	TITLE: LUMHS CAFETERIA 3D VIEW	DESIGNED BY: AR.SALMAN DRAWN BY: SAIF	A.S	DATE : MARCH-2024 SCALE: N.T.S
	CAD filename:	DRG. NO.	LS-00	

MASTER PLAN

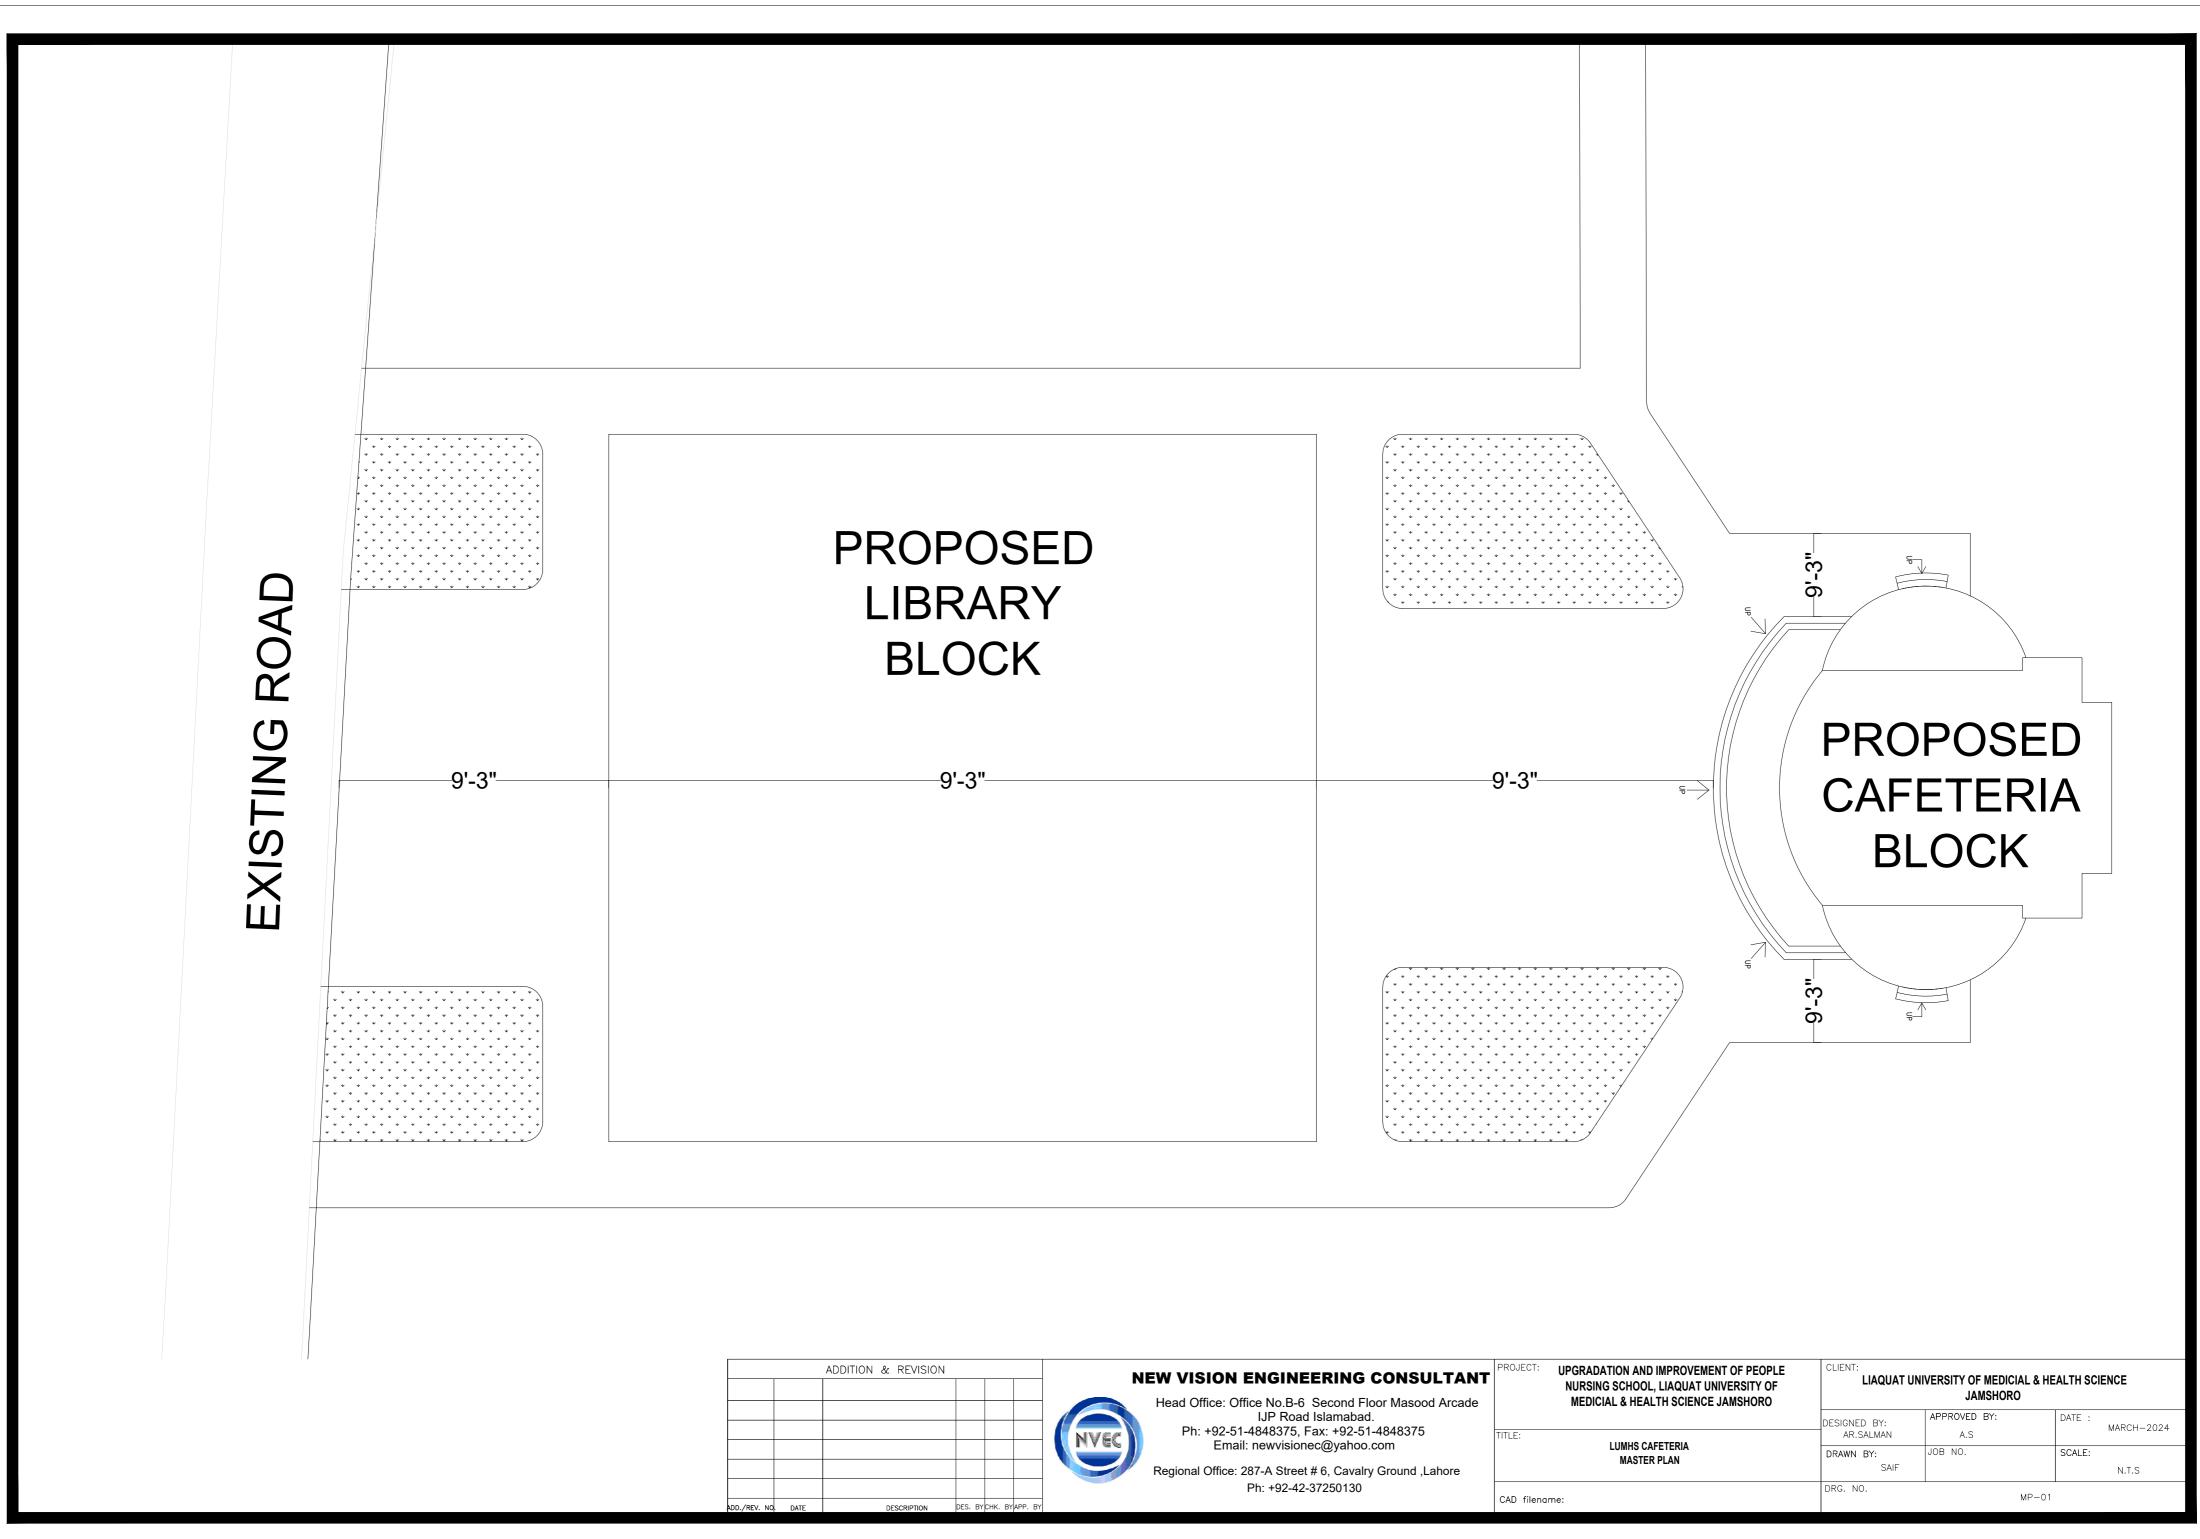


VISION ENGINEERING CONSULTANT ad Office: Office No.B-6 Second Floor Masood Arcade	PROJECT: UPGRADATION AND IMPROVEMENT OF PEOPLE NURSING SCHOOL, LIAQUAT UNIVERSITY OF MEDICIAL & HEALTH SCIENCE JAMSHORO	LIAQUAT UN	IVERSITY OF MEDICIAL & HE JAMSHORO	ALTH SCIENCE
IJP Road Islamabad.	TITLE:	DESIGNED BY:	APPROVED BY:	DATE :
Ph: +92-51-4848375, Fax: +92-51-4848375		AR.SALMAN	A.S	MARCH-2024
Email: newvisionec@yahoo.com	LUMHS CAFETERIA	DRAWN BY:	JOB NO.	SCALE:
ional Office: 287-A Street # 6, Cavalry Ground ,Lahore	MASTER PLAN	SAIF		N.T.S
Ph: +92-42-37250130	CAD filename:	DRG. NO.	MP-01	

3D VIEW






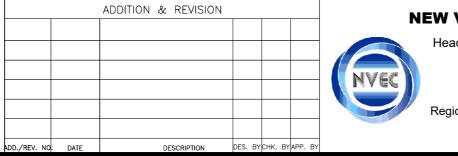


VISION ENGINEERING CONSULTANT ad Office: Office No.B-6 Second Floor Masood Arcade	PROJECT: UPGRADATION AND IMPROVEMENT OF PEOPLE NURSING SCHOOL, LIAQUAT UNIVERSITY OF MEDICIAL & HEALTH SCIENCE JAMSHORO	LIAQUAT UNI	VERSITY OF MEDICIAL & HE JAMSHORO	ALTH SCIENCE
IJP Road Islamabad. Ph: +92-51-4848375, Fax: +92-51-4848375	TITLE:	DESIGNED BY: AR.SALMAN	APPROVED BY:	DATE : MARCH-2024
Email: newvisionec@yahoo.com	LUMHS CAFETERIA 3D VIEW		JOB NO.	SCALE:
ional Office: 287-A Street # 6, Cavalry Ground ,Lahore		SAIF		N.T.S
Ph: +92-42-37250130	CAD filename:	DRG. NO.	3D-01	




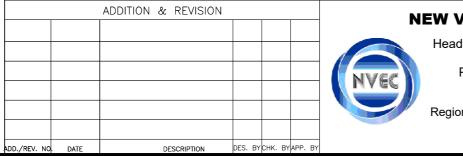


d Office: Office No.B-6 Second Floor Masood Arcade	UPGRADATION AND IMPROVEMENT OF PEOPLE NURSING SCHOOL, LIAQUAT UNIVERSITY OF MEDICIAL & HEALTH SCIENCE JAMSHORO	LIAQUAT UNIVERSITY OF MEDICIAL & HEALTH SCIENCE JAMSHORO			
IJP Road Islamabad. Ph: +92-51-4848375, Fax: +92-51-4848375	TITLE:	DESIGNED BY: AR.SALMAN	APPROVED BY: A.S	DATE : MARCH-2024	
Email: newvisionec@yahoo.com onal Office: 287-A Street # 6, Cavalry Ground ,Lahore Ph: +92-42-37250130	LUMHS CAFETERIA 3D VIEW	DRAWN BY: SAIF	JOB NO.	SCALE: N.T.S	
	CAD filename:	DRG. NO. 3D-02		02	

ARCHITECTURE DRAWINGS

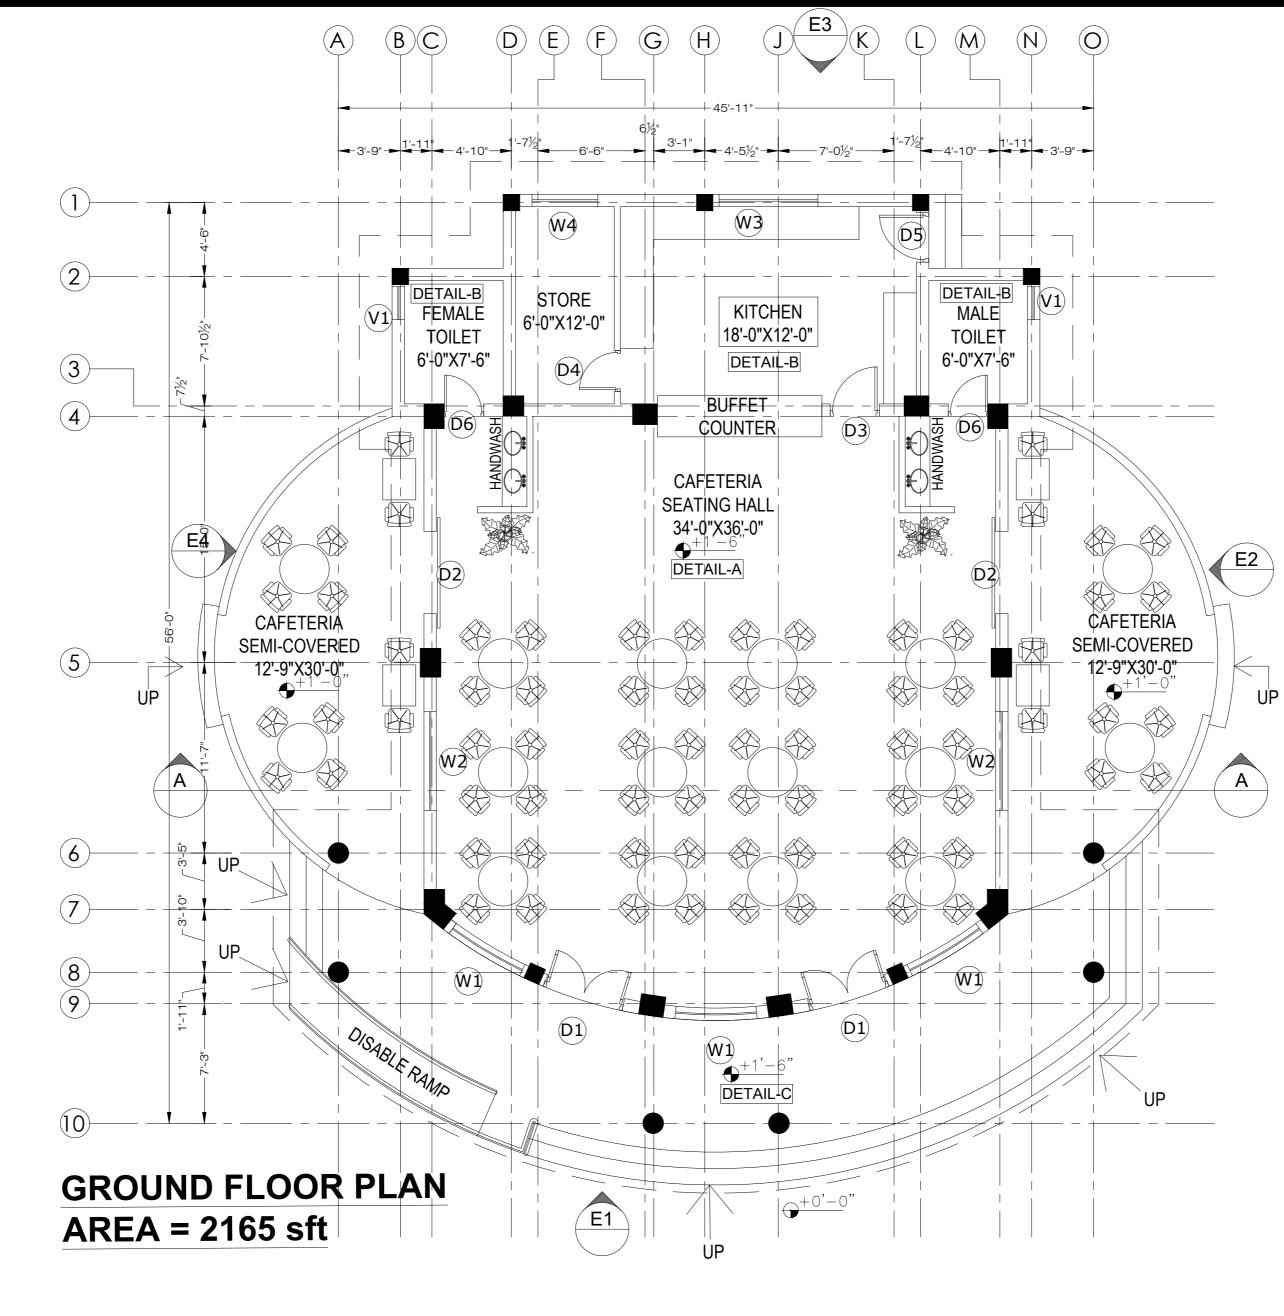

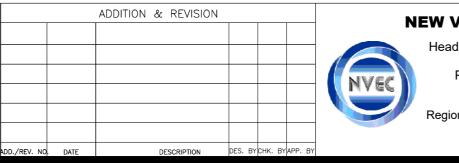


ead Office: Office No.B-6 Second Floor Masood Arcade IJP Road Islamabad.	PROJECT: UPGRADATION AND IMPROVEMENT OF PEOPLE NURSING SCHOOL, LIAQUAT UNIVERSITY OF MEDICIAL & HEALTH SCIENCE JAMSHORO	CLIENT: LIAQUAT UNIVERSITY OF MEDICIAL & HEALTH SCIENCE JAMSHORO		
	TITLE: LUMHS CAFETERIA GROUND FLOOR PLAN	DESIGNED BY: AR.SALMAN DRAWN BY: SAIF	APPROVED BY: A.S JOB NO.	DATE : MARCH-2024 SCALE: N.T.S
	CAD filename:	DRG. NO.		

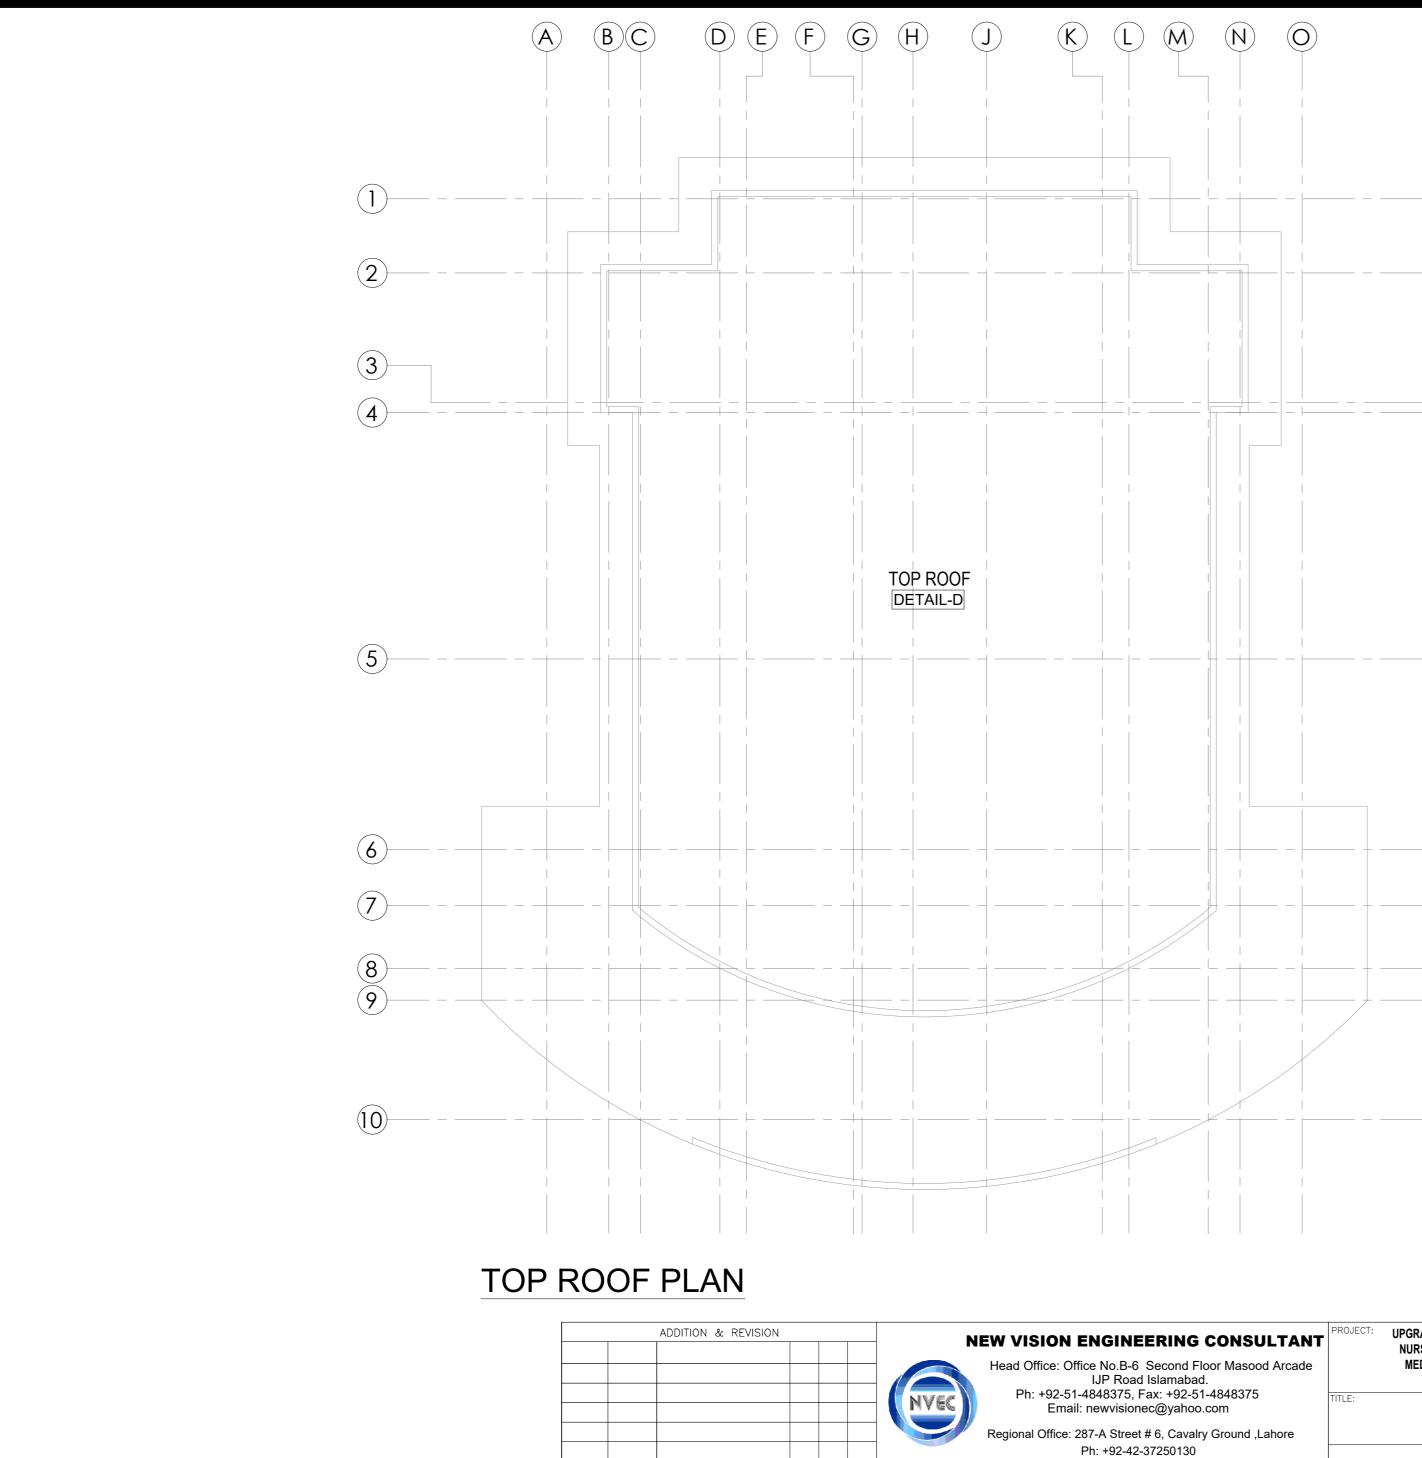

ADD./REV. NO. DATE

DESCRIPTION DES. BY CHK. BY APP. BY


d Office: Office No.B-6 Second Floor Masood Arcade	PROJECT: UPGRADATION AND IMPROVEMENT OF PEOPLE NURSING SCHOOL, LIAQUAT UNIVERSITY OF MEDICIAL & HEALTH SCIENCE JAMSHORO	CLIENT: LIAQUAT UN	NIVERSITY OF MEDICIAL & H JAMSHORO	EALTH SCIENCE
IJP Road Islamabad.	TITLE:	DESIGNED BY:	APPROVED BY:	DATE :
Ph: +92-51-4848375, Fax: +92-51-4848375		AR.SALMAN	A.S	MARCH-2024
Email: newvisionec@yahoo.com	LUMHS CAFETERIA	DRAWN BY:	JOB NO.	SCALE:
nal Office: 287-A Street # 6, Cavalry Ground ,Lahore	TOP ROOF PLAN	SAIF		N.T.S
Ph: +92-42-37250130	CAD filename:	DRG. NO.	AR-02	

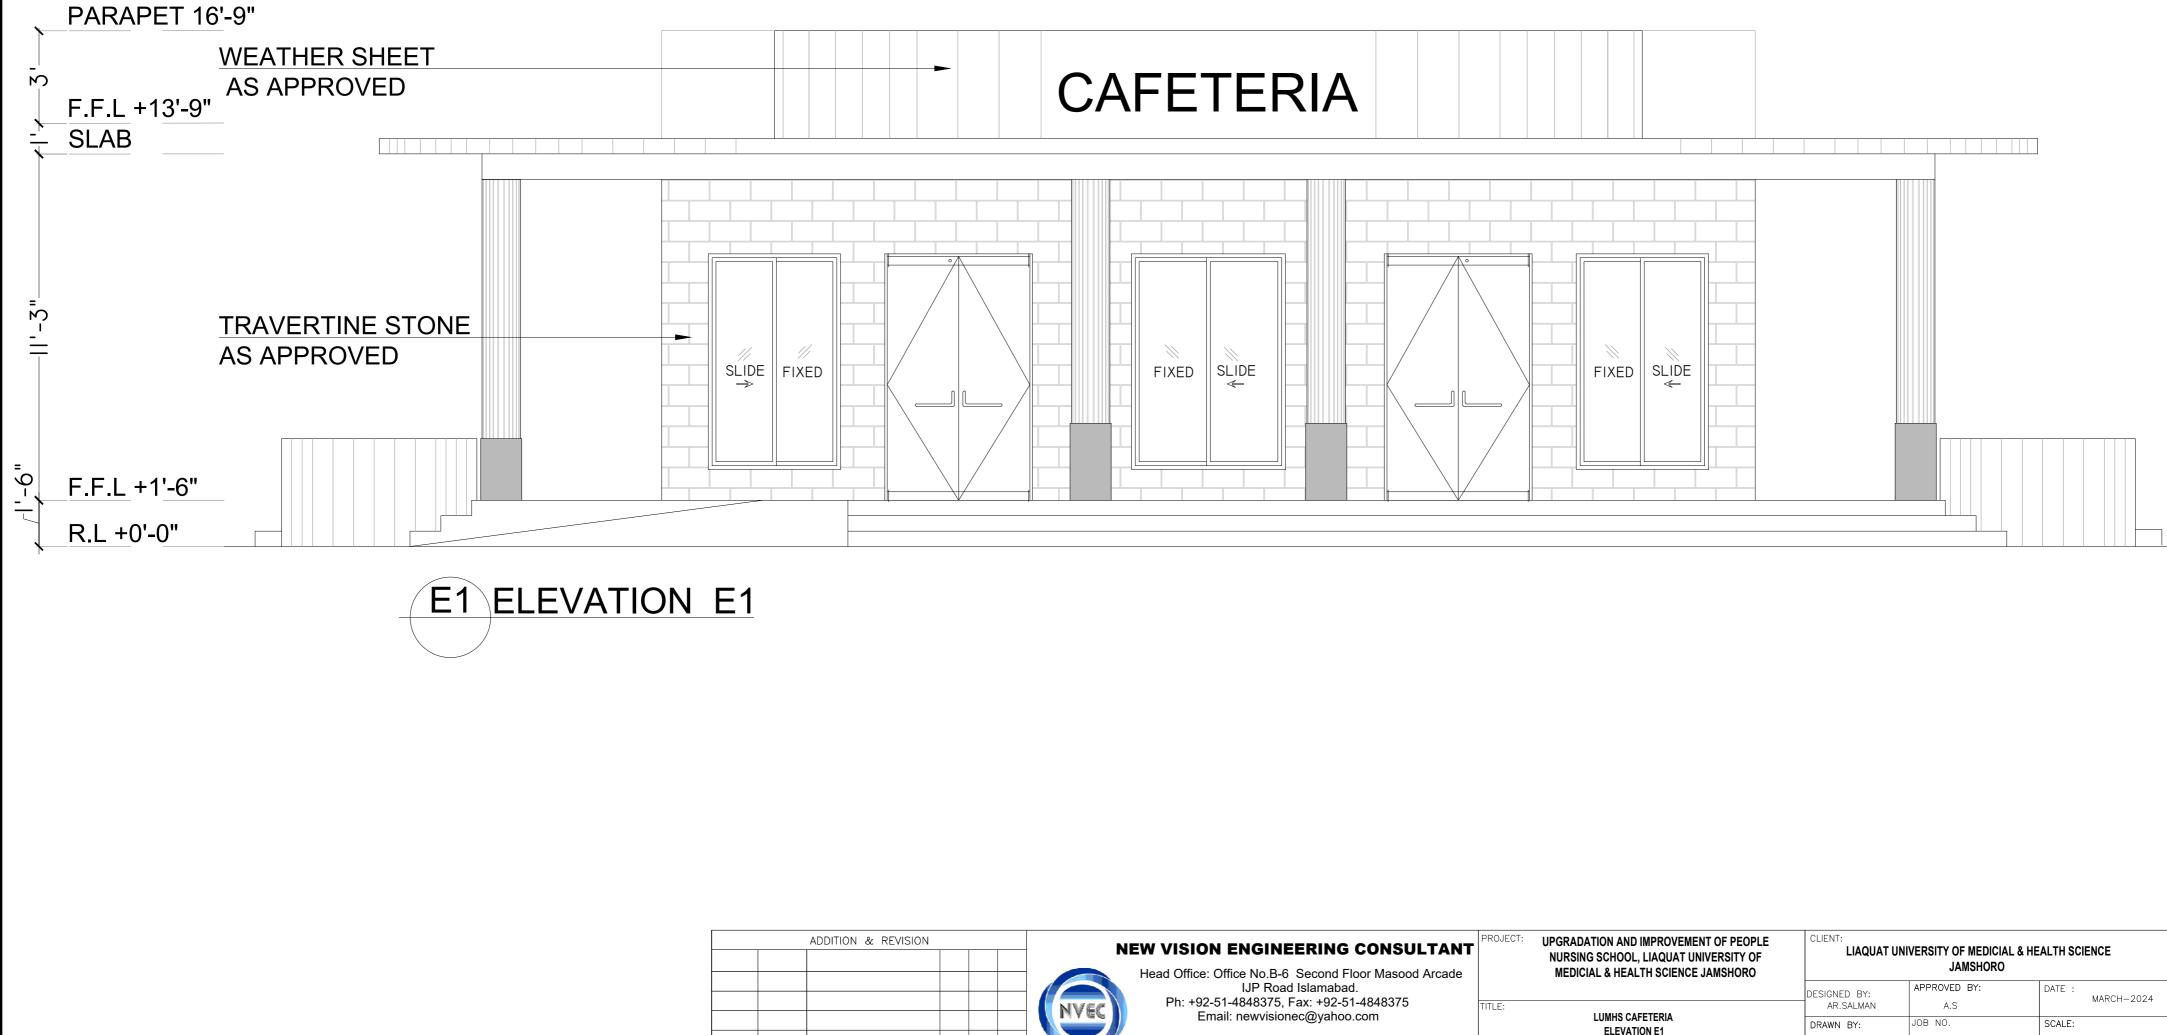


DESCRIPTION DES. BY CHK. BY APP. BY

ADD./REV. NO. DATE


/ISION ENGINEERING CONSULTANT Office: Office No.B-6 Second Floor Masood Arcade	NURSING SCHOOL, LIAQUAT UNIVERSITY OF MEDICIAL & HEALTH SCIENCE JAMSHORO	LIAQUAT UNIVERSITY OF MEDICIAL & HEALTH SCIENCE JAMSHORO			
	TITLE:	DESIGNED BY: AR.SALMAN	APPROVED BY: A.S	DATE : MARCH-2024	
Email: newvisionec@yahoo.com onal Office: 287-A Street # 6, Cavalry Ground ,Lahore	ELEVATION E1	DRAWN BY: SAIF	JOB NO.	SCALE: N.T.S	
Ph: +92-42-37250130	CAD filename:	DRG. NO.	AR-03		

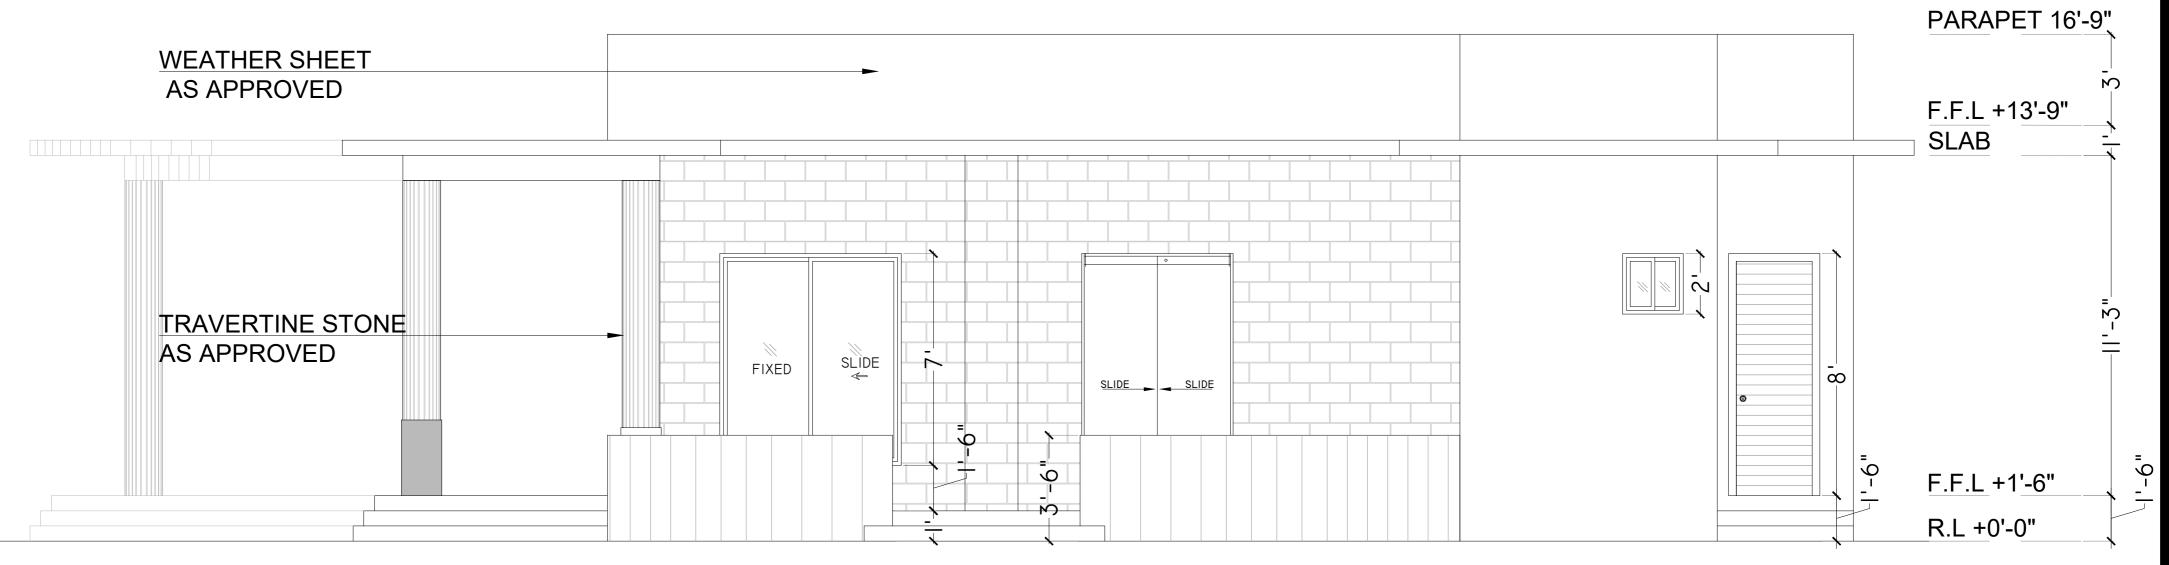



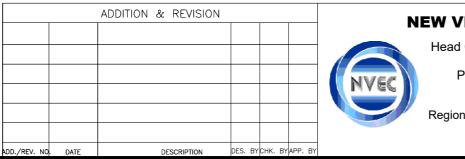


VISION ENGINEERING CONSULTANT ad Office: Office No.B-6 Second Floor Masood Arcade	PROJECT: UPGRADATION AND IMPROVEMENT OF PEOPLE NURSING SCHOOL, LIAQUAT UNIVERSITY OF MEDICIAL & HEALTH SCIENCE JAMSHORO	CLIENT: LIAQUAT UN	ALTH SCIENCE	
IJP Road Islamabad. Ph: +92-51-4848375, Fax: +92-51-4848375 Email: newvisionec@yahoo.com	TITLE:	DESIGNED BY: AR.SALMAN	APPROVED BY: A.S	DATE : MARCH-2024
nal Office: 287-A Street # 6, Cavalry Ground ,Lahore	ELEVATION E2	DRAWN BY: SAIF	JOB NO.	SCALE: N.T.S
Ph: +92-42-37250130	CAD filename:	DRG. NO.	AR-04	

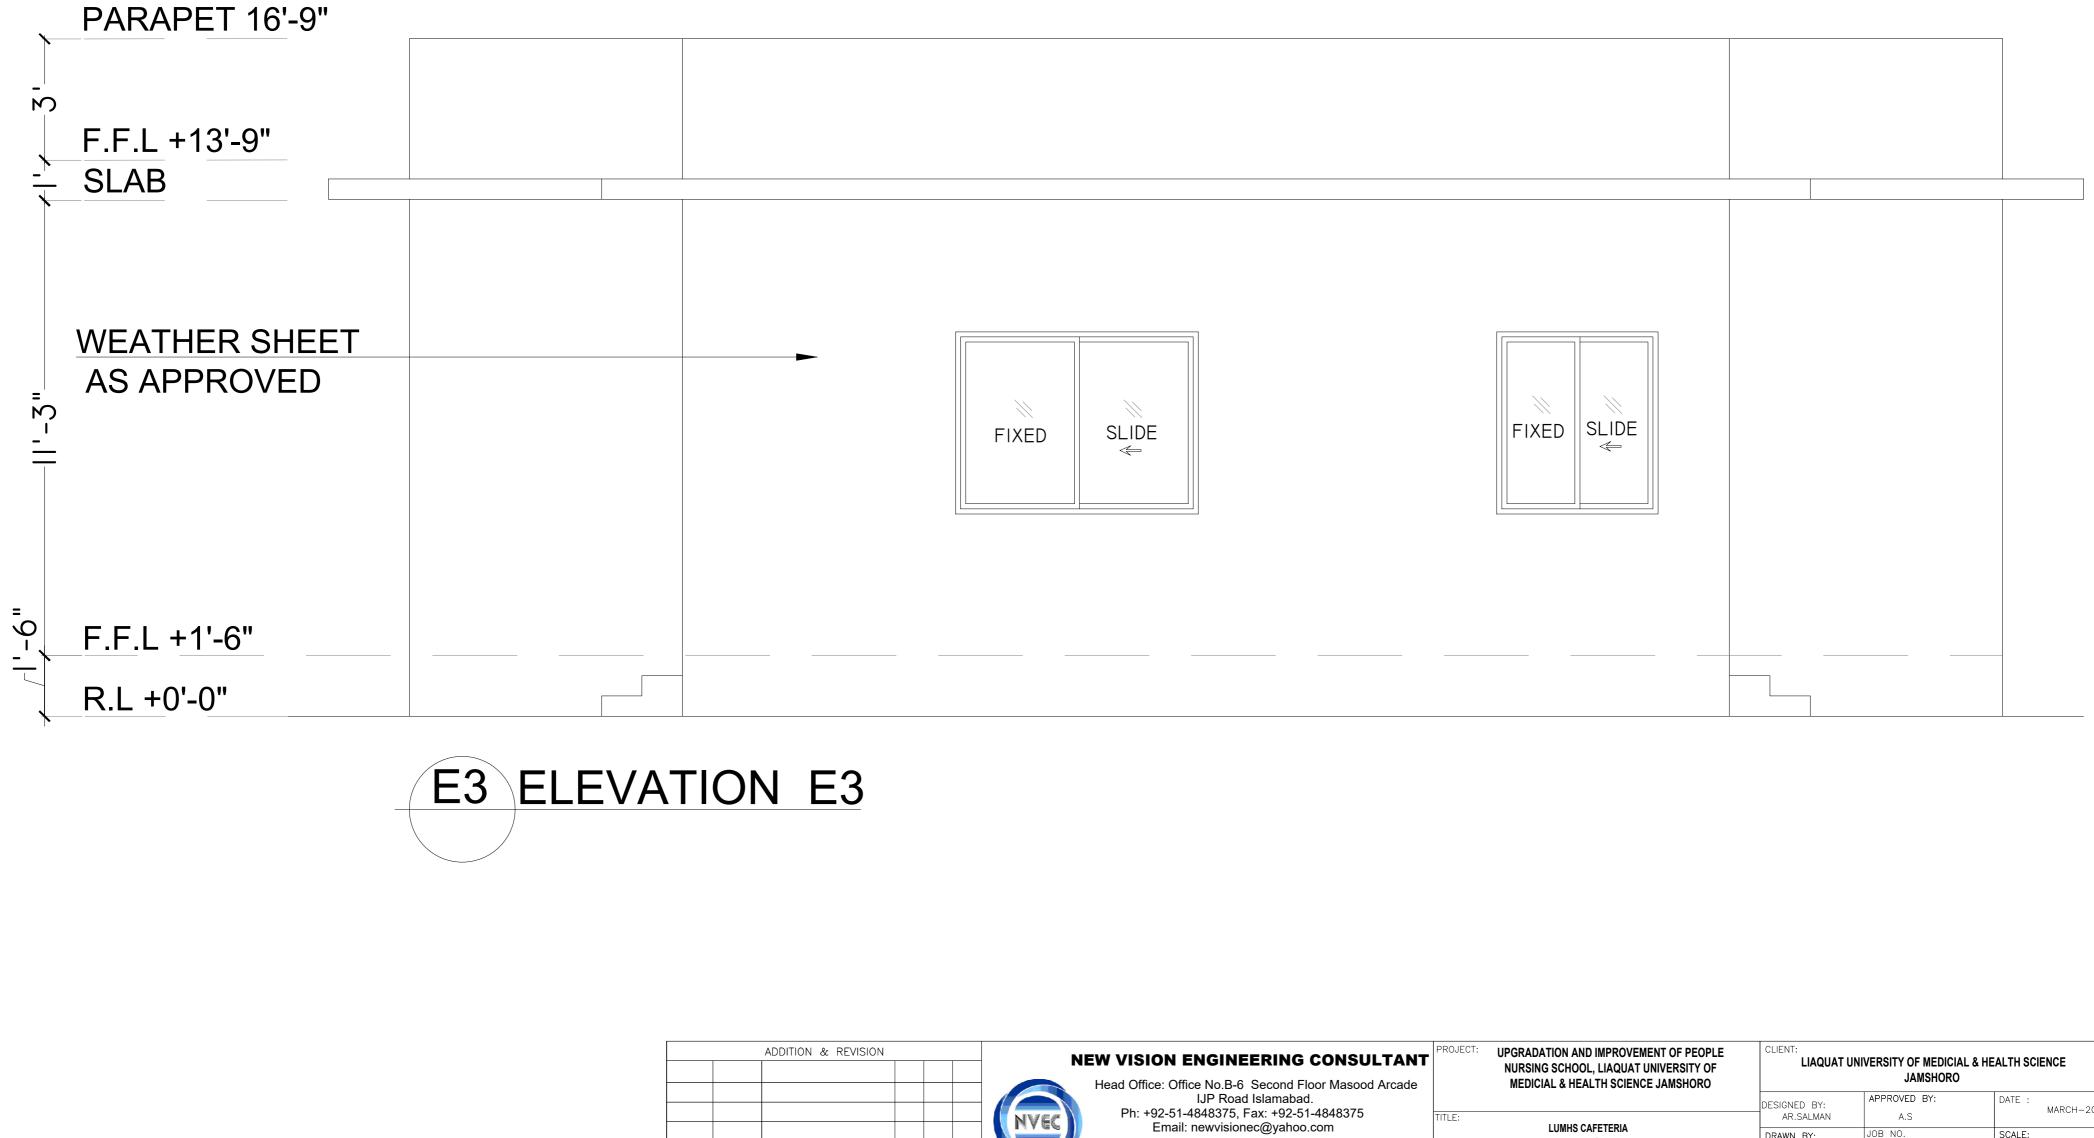


DESCRIPTION DES. BY CHK. BY APP. BY

ADD./REV. NO. DATE


VISION ENGINEERING CONSULTANT Office: Office No.B-6 Second Floor Masood Arcade	PROJECT: UPGRADATION AND IMPROVEMENT OF PEOPLE NURSING SCHOOL, LIAQUAT UNIVERSITY OF MEDICIAL & HEALTH SCIENCE JAMSHORO	CLIENT: LIAQUAT UNI	VERSITY OF MEDICIAL & HE JAMSHORO	ALTH SCIENCE
IJP Road Islamabad.	TITLE:	DESIGNED BY:	APPROVED BY:	DATE :
Ph: +92-51-4848375, Fax: +92-51-4848375		AR.SALMAN	A.S	MARCH-2024
Email: newvisionec@yahoo.com	LUMHS CAFETERIA	DRAWN BY:	JOB NO.	SCALE:
nal Office: 287-A Street # 6, Cavalry Ground ,Lahore	ELEVATION E3	SAIF		N.T.S
Ph: +92-42-37250130	CAD filename:	DRG. NO.	AR-05	

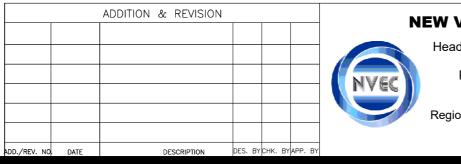




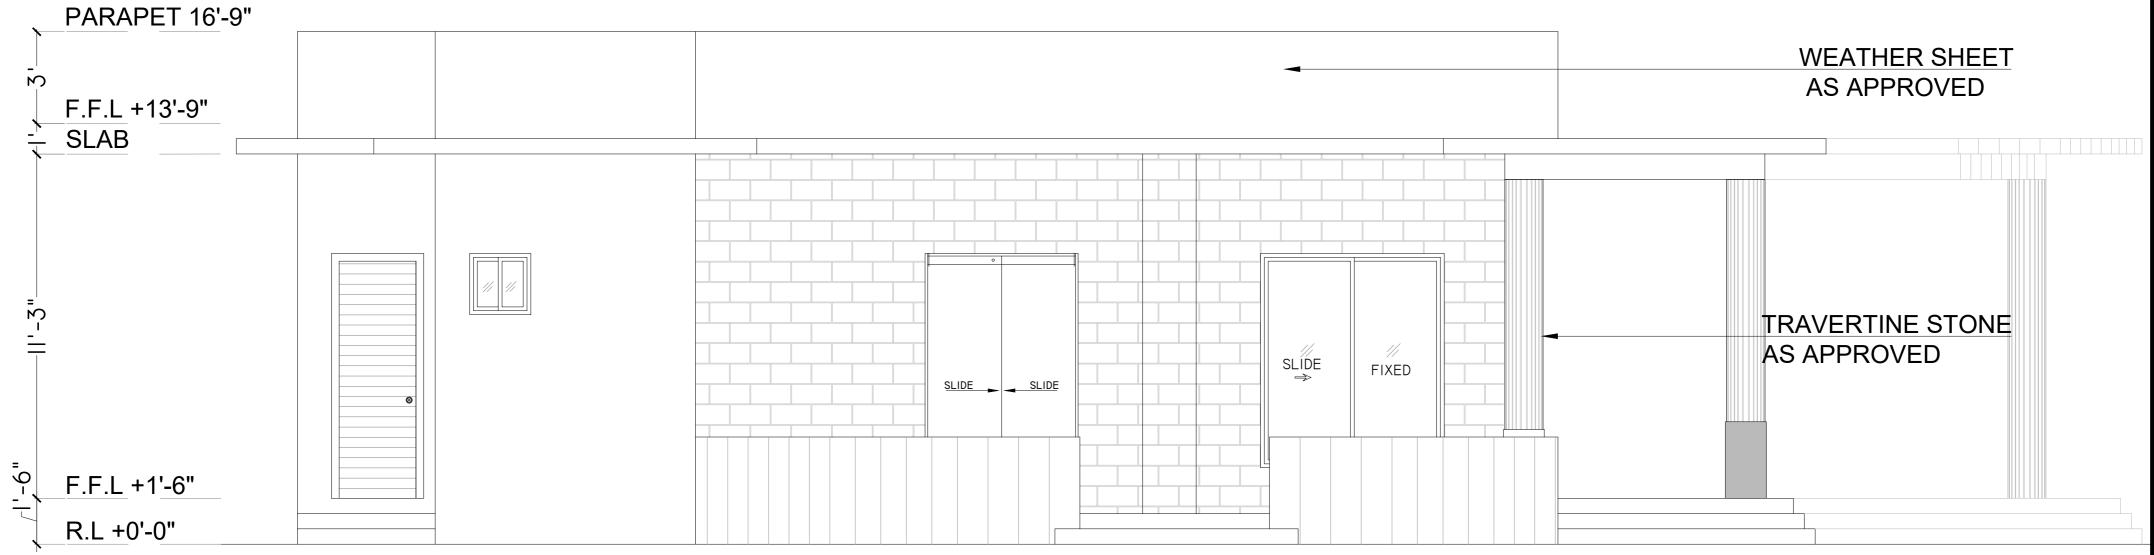

VISION ENGINEERING CONSULTANT ad Office: Office No.B-6 Second Floor Masood Arcade	PROJECT: UPGRADATION AND IMPROVEMENT OF PEOPLE NURSING SCHOOL, LIAQUAT UNIVERSITY OF MEDICIAL & HEALTH SCIENCE JAMSHORO	CLIENT: LIAQUAT UNIVERSITY OF MEDICIAL & HEALTH SCIENCE JAMSHORO			
IJP Road Islamabad.	TITLE:	DESIGNED BY:	APPROVED BY:	DATE :	
Ph: +92-51-4848375, Fax: +92-51-4848375		AR.SALMAN	A.S	MARCH-2024	
Email: newvisionec@yahoo.com	LUMHS CAFETERIA	DRAWN BY:	JOB NO.	SCALE:	
nal Office: 287-A Street # 6, Cavalry Ground ,Lahore	ELEVATION E4	SAIF		N.T.S	
Ph: +92-42-37250130	CAD filename:	DRG. NO.	AR-06		

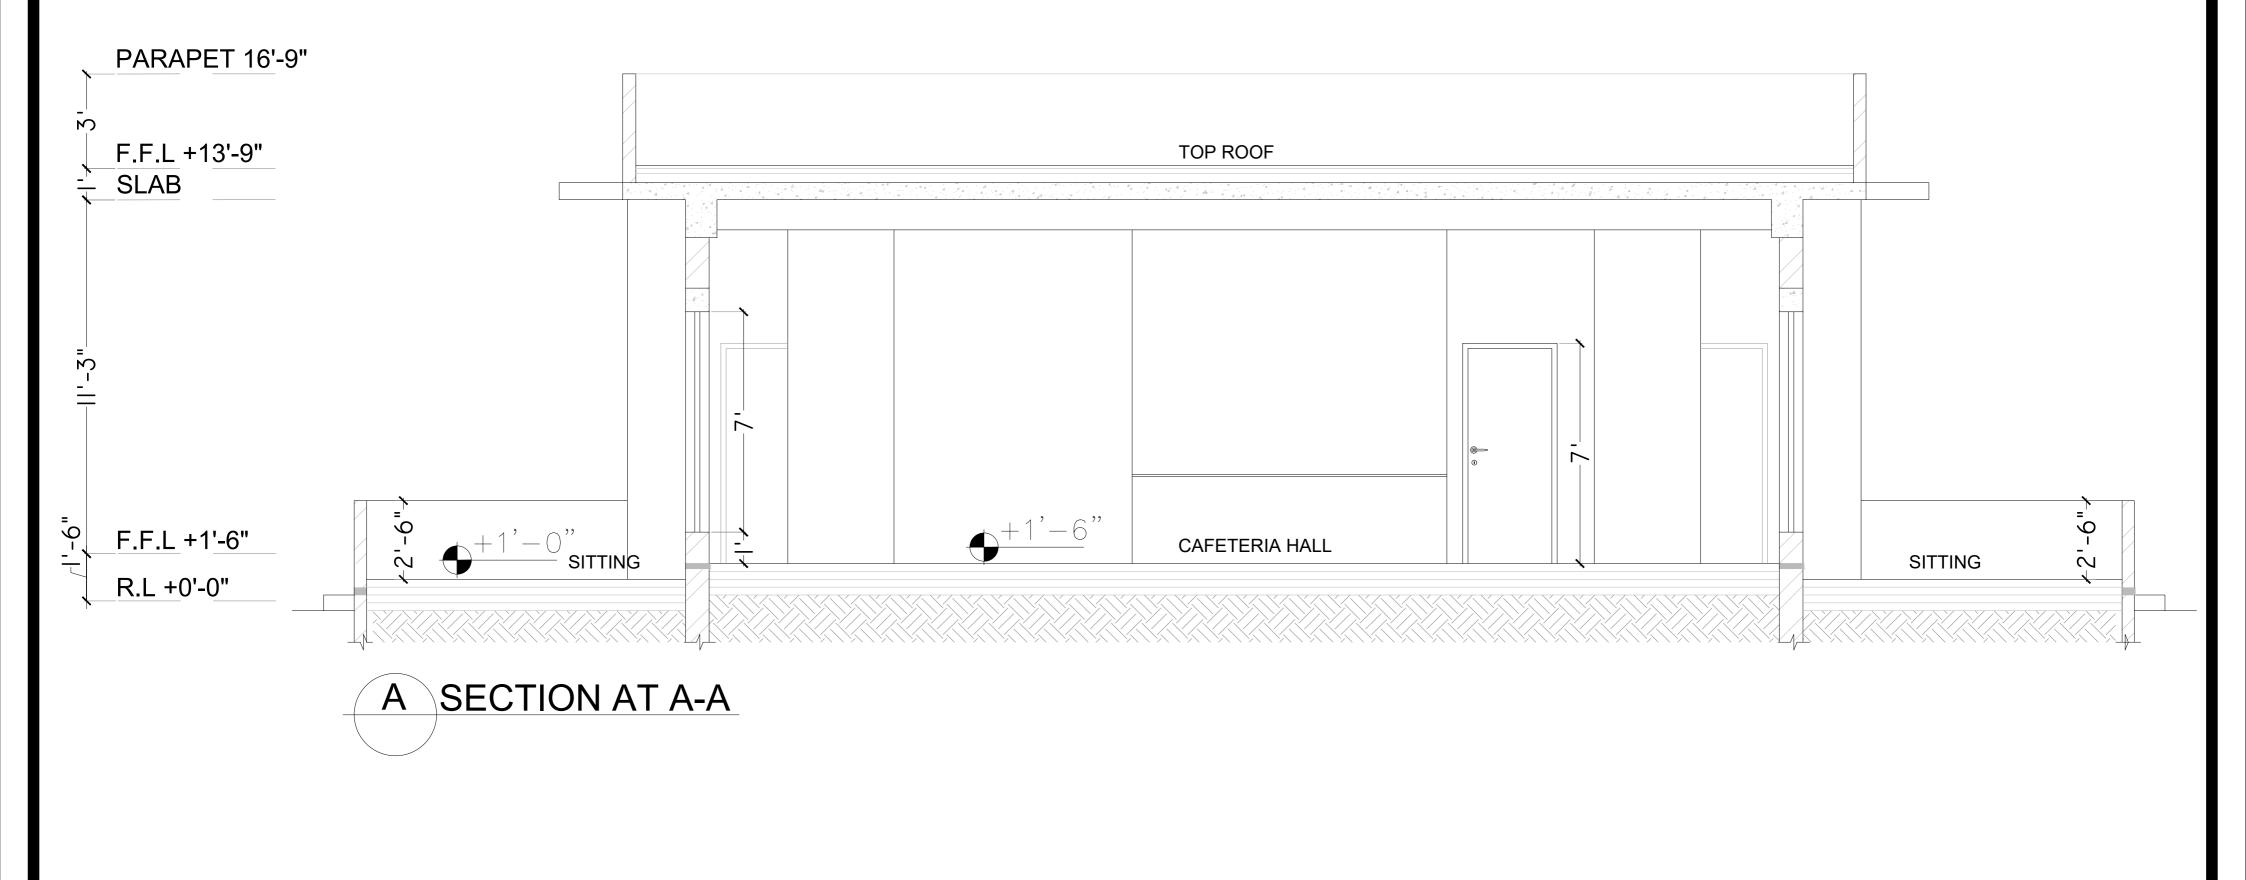

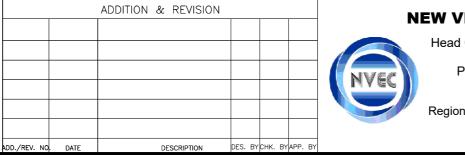

VISION ENGINEERING CONSULTANT ad Office: Office No.B-6 Second Floor Masood Arcade	PROJECT: UPGRADATION AND IMPROVEMENT OF PEOPLE NURSING SCHOOL, LIAQUAT UNIVERSITY OF MEDICIAL & HEALTH SCIENCE JAMSHORO	CLIENT: LIAQUAT UNI	VERSITY OF MEDICIAL & HE JAMSHORO	ALTH SCIENCE
IJP Road Islamabad.		DESIGNED BY:	APPROVED BY:	DATE : MARCH-2024
Ph: +92-51-4848375, Fax: +92-51-4848375		AR.SALMAN	A.S	W/WOTT 2021
Email: newvisionec@yahoo.com	LUMHS CAFETERIA SECTION AT A-A	DRAWN BY:	JOB NO.	SCALE:
ional Office: 287-A Street # 6, Cavalry Ground ,Lahore	SECTION AT A-A	SAIF		N.T.S
Ph: +92-42-37250130	CAD filename:	DRG. NO.	AR-07	


SCHEDULE OF (
---------------	--

DOOR SCHEDULE IENSIONS SILL LEVEL DESCRIPTION 5'-0"x8'-0" 0'-0" SOLID FLUSH DOOR 5'-0"x8'-0" 0'-0" SOLID FLUSH DOOR 5'-0"x8'-0" 0'-0" SOLID FLUSH DOOR 5'-0"x7'-0" 0'-0" SOLID FLUSH DOOR '-0"x7'-0" 0'-0" SOLID FLUSH DOOR '-6"x7'-0" 0'-0" SOLID FLUSH DOOR '-0"x8'-0" 0'-0" STEEL DOOR

S.NO.	OPENINGS	DIMENSIONS	SILL
1	D1	5'-0"x8'-0"	C
2	D2	5'-0"X8'-0"	C
3	D3	3'-0"X7'-0"	C
4	D4	2'-6"X7'-0"	0
5	D5	3'-0"X8'-0"	0
6	D6	2'-5"X7'-0"	0


WINDOW SCHEDULE


5	W1	5'-0"X7'-0"	+1'-0"	ALUMINUM WINDOW
6	W2	6'-0"X7'-0"	+1'-0"	ALUMINUM WINDOW
7	W3	6'-0"X4'-6"	+3'-6"	ALUMINUM WINDOW
8	W4	4'-0"X4'-6"	+3'-6"	ALUMINUM WINDOW
9	V1	2'-0"X2'-0"	+6'-0"	ALUMINUM WINDOW

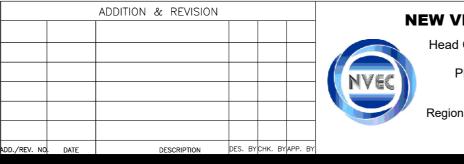


OPENINGS

VISION ENGINEERING CONSULTANT ad Office: Office No.B-6 Second Floor Masood Arcade	PROJECT: UPGRADATION AND IMPROVEMENT OF PEOPLE NURSING SCHOOL, LIAQUAT UNIVERSITY OF MEDICIAL & HEALTH SCIENCE JAMSHORO	CLIENT: LIAQUAT UNIVERSITY OF MEDICIAL & HEALTH SCIENCE JAMSHORO			
IJP Road Islamabad.	TITLE:	DESIGNED BY:	APPROVED BY:	DATE :	
Ph: +92-51-4848375, Fax: +92-51-4848375		AR.SALMAN	A.S	MARCH-2024	
Email: newvisionec@yahoo.com	LUMHS CAFETERIA	DRAWN BY:	JOB NO.	SCALE:	
ional Office: 287-A Street # 6, Cavalry Ground ,Lahore	SCHEDULE OF OPENINGS	SAIF		N.T.S	
Ph: +92-42-37250130	CAD filename:	DRG. NO.	AR-08		

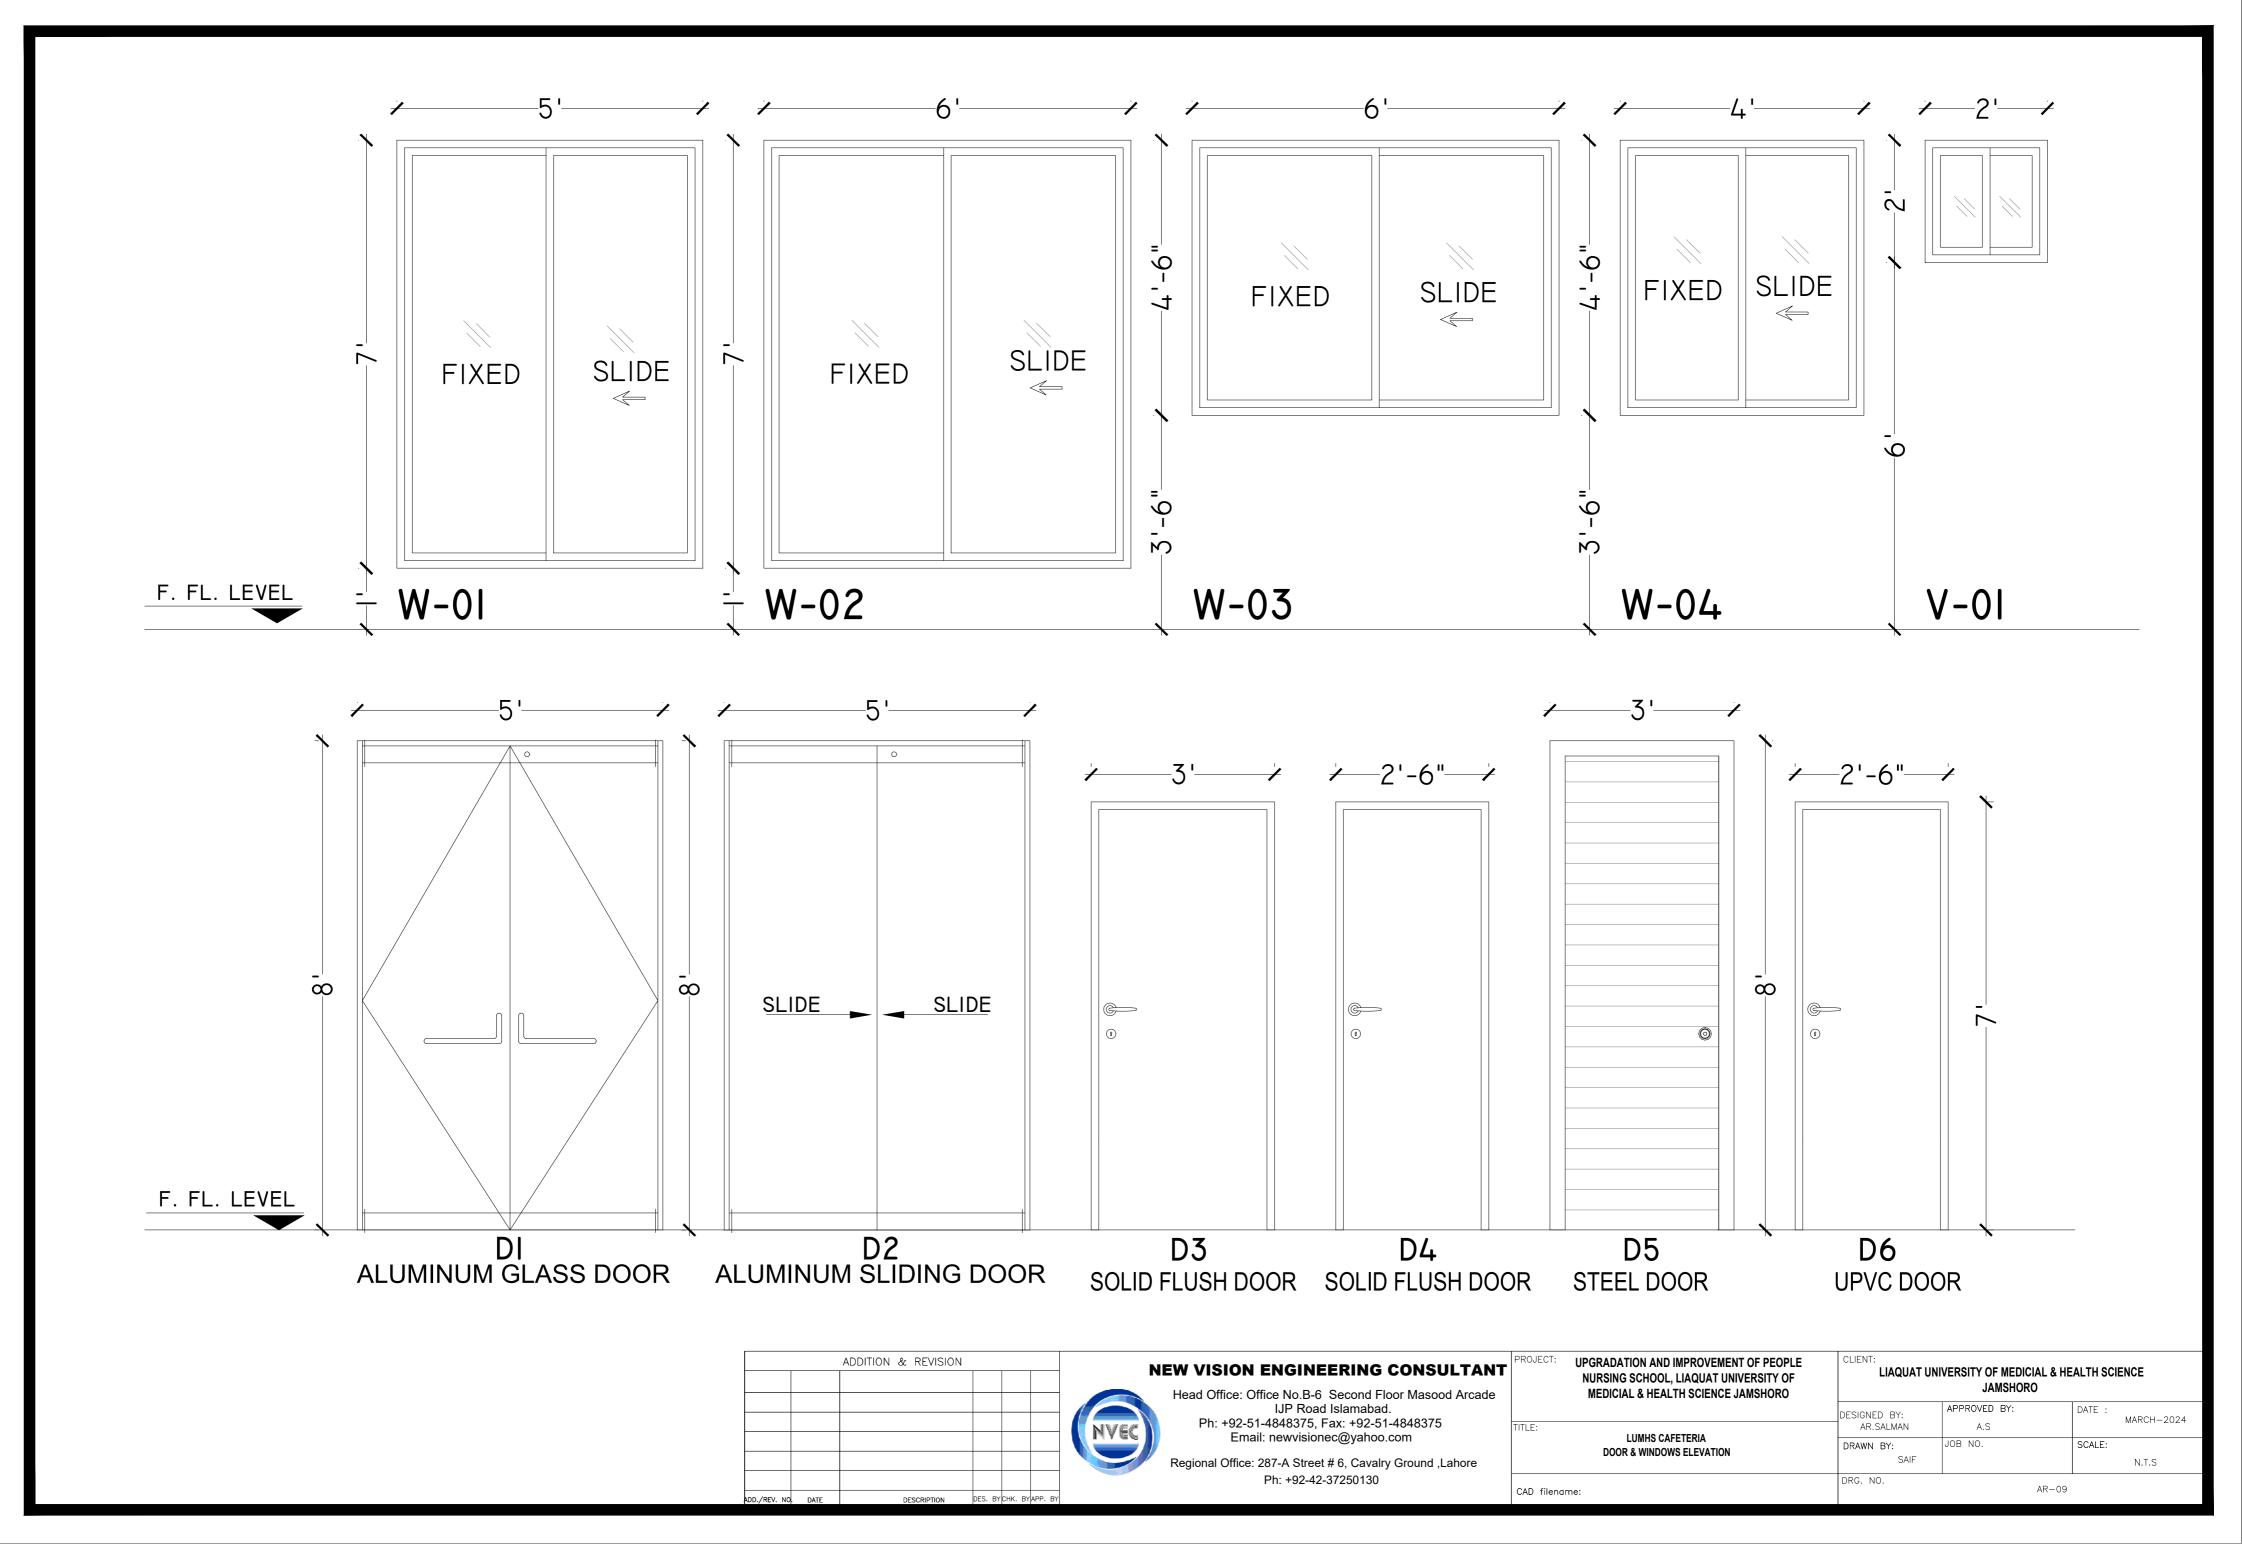

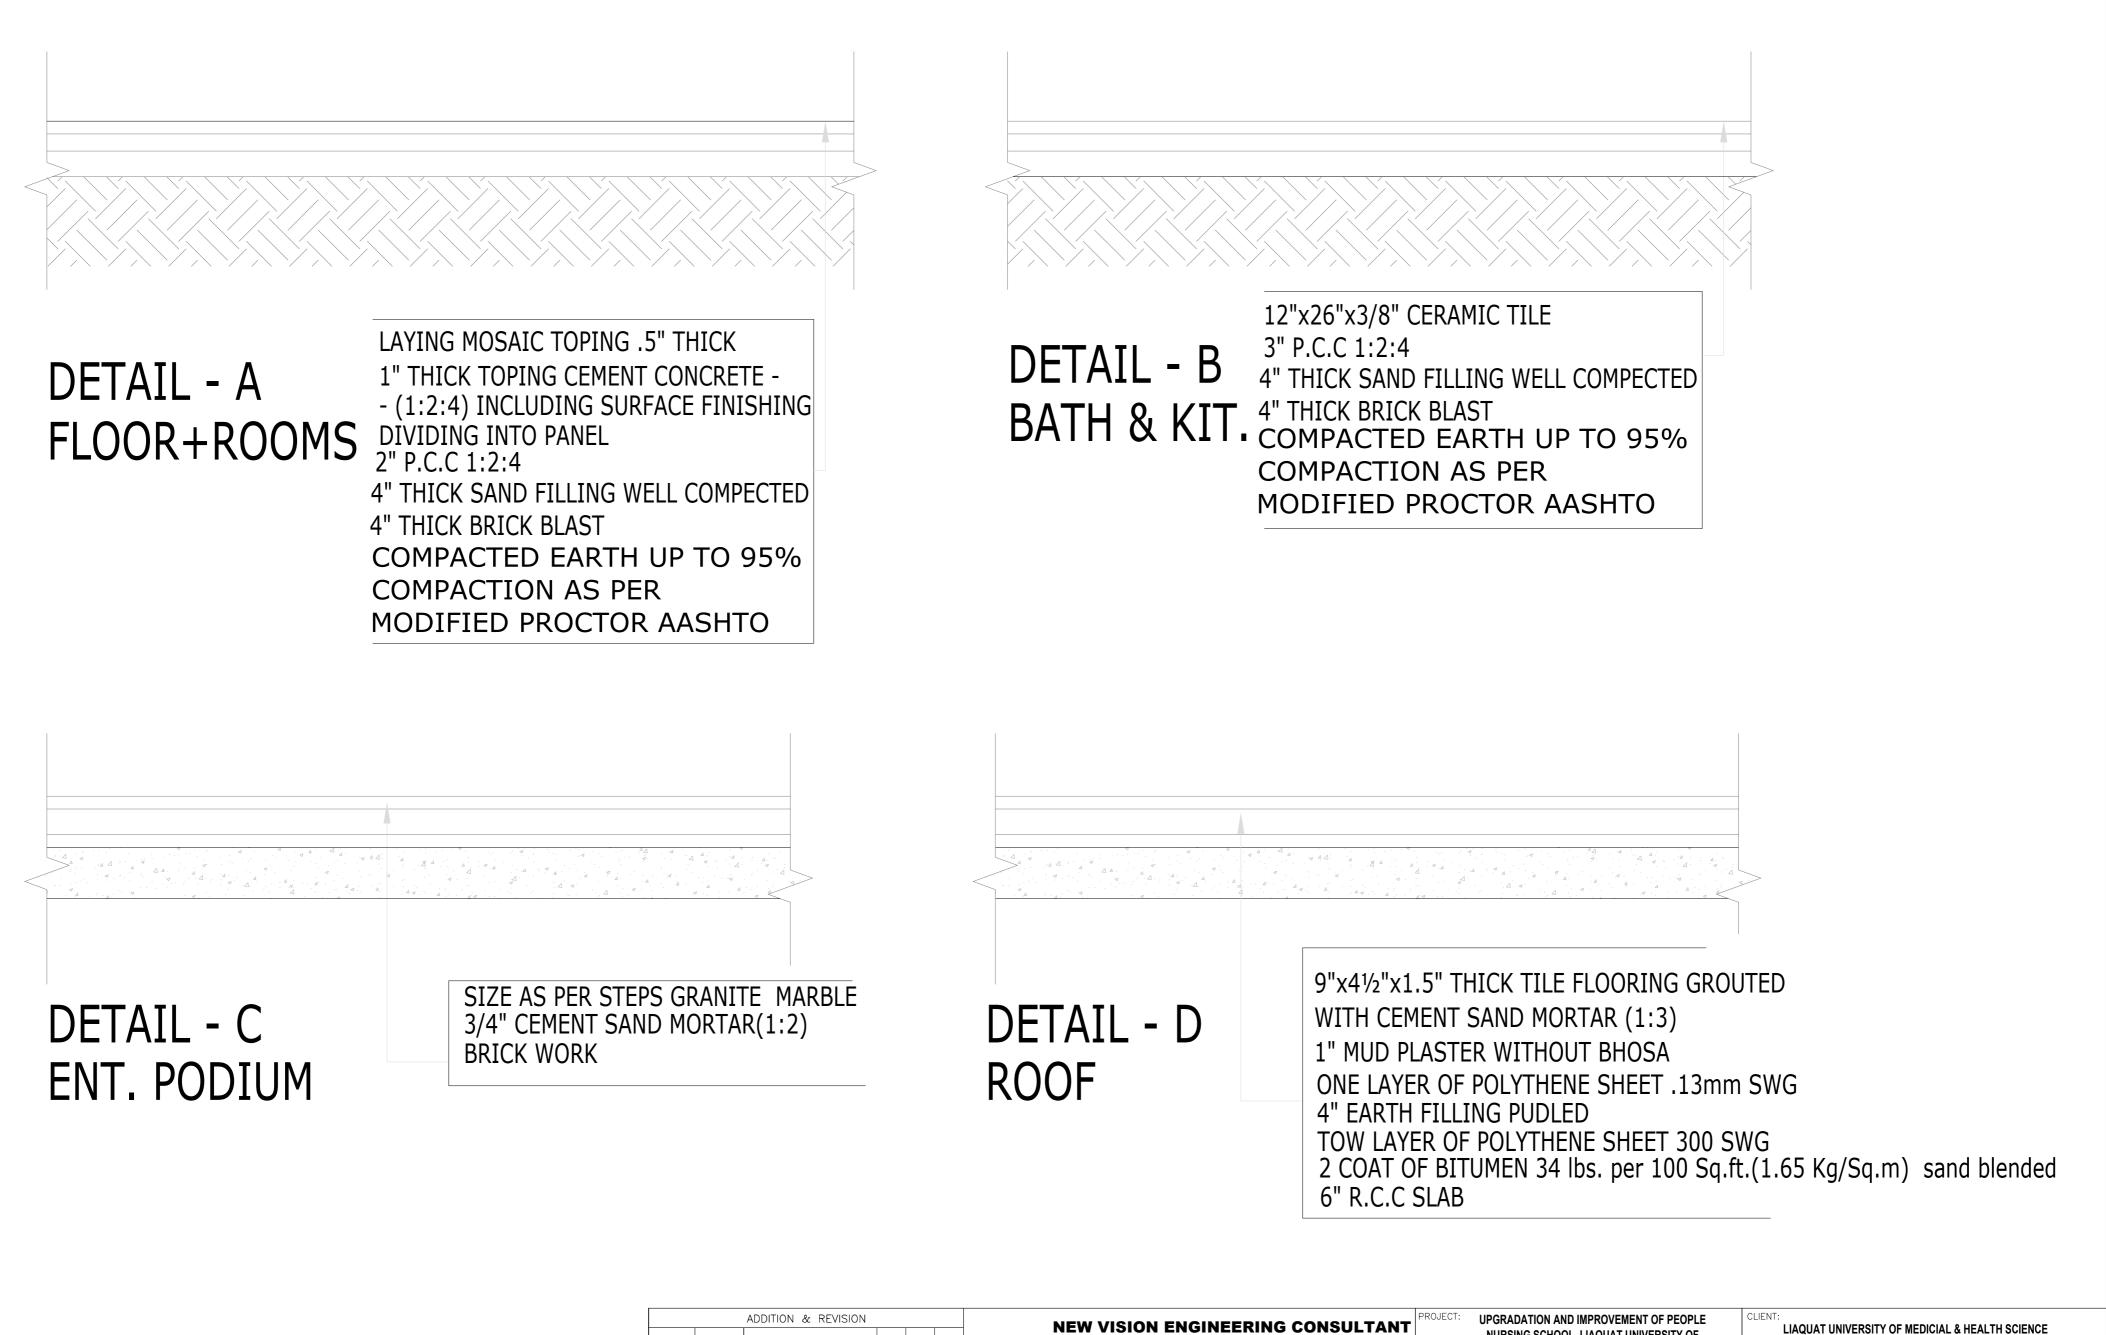

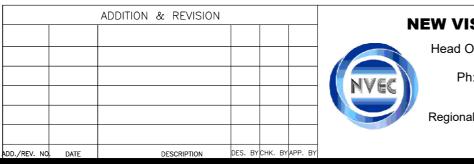

ad Office: Office No.B-6 Second Floor Masood Arcade
IJP Road Islamabad.
Ph: +92-51-4848375, Fax: +92-51-4848375
Email: newvisionec@yahoo.com

Regional Office: 287-A Street # 6, Cavalry Ground ,Lahore Ph: +92-42-37250130

	NURSING SCHOOL, LIAQUAT UNIVERSITY OF MEDICIAL & HEALTH SCIENCE JAMSHORO	LIAQUAT UNIVERSITY OF MEDICIAL & HEALTH SCIENCE JAMSHORO						
TITI F:		DESIGNED BY: AR.SALMAN	APPROVED BY:	DATE :	MARCH-2024			
IIILE:	LUMHS CAFETERIA FINISH FLOOR DETAIL	DRAWN BY:	JOB NO.	SCALE:				
		SAIF			N.T.S			
CAD file	name:	DRG. NO.	Al	R-10				

STRUCTURE CAFETERIA

LIST OF DRAWINGS									
S.NO. DRAWING TITLE DRG. NO									
	STRUCTURE DRAWINGS								
1	LIST OF DRAWINGS	ST-01							
2	GENERAL NOTES	ST-02							
3	TYPICAL DETAILS	ST-03							
4	TYPICAL DETAILS	ST-04							
5	TYPICAL DETAILS	ST-05							
6	FOUNDATION LAYOUT PLAN	ST-06							
7	FOUNDATION SCHEDULE	ST-07							
8	FOUNDATION SECTION DETAIL	ST-08							
9	9 FOUNDATION SECTION DETAIL								
10	BRICK MASONRY FOUNDATION LAYOUT	ST-10							
11	BRICK MASONRY SECTION	ST-11							
12	COLUMN LAYOUT PLAN	ST-12							
13	COLUMN SECTION	ST-13							
14	PLINTH BEAM LAYOUT PLAN	ST-14							
15	PLINTH BEAM SECTION	ST-15							
16	GROUND FLOOR BEAM LAYOUT PLAN	ST-16							
17	GROUND FLOOR BEAM SECTION	ST-17							
18	GROUND FLOOR SLAB LAYOUT POSITIVE REINF. PLAN	ST-18							
19	GROUND FLOOR SLAB LAYOUT NEGATIVE REINF. PLAN	ST-19							
20	ROOF PLAN	ST-20							
21	OHWT DETAIL	ST-21							

ADDITION & REVISION						PROJECT		CLIENT:						
							NEW VISION ENGINEERING CONSULTANT Head Office: Office No.B-6 SECOND FLOOR Masood Arcade IJP Road Islamabad. Ph: +92-51-4848375, Fax: +92-51-4848375	SCHOOL, LIAQUAT UNIVERSITY OF MEDICIAL & HEALTH		LIAQUAT UNIVERSITY OF MEDICIAL & HEALTH SCIENCE JAMSHORO				
						NVEC		TITLE:	SCIENCE JAMSHORO	DESIGNED BY: ENG.ZAIN ARSHAD	APPROVED BY:	DATE :	MARCH, 2024	
						Email: newvisionec@yahoo.com Regional Office: 287-A Street # 6, Cavalry Ground ,Lahore	e LIST OF DRAWING	LIST OF DRAWING	DRAWN BY: MATHEW SIMON	JOB NO.	SCALE:	N.T.S		
ADD./REV. NO.	DATE	DESCRIPTION	DES. BY	CHK. BY	APP. BY		Ph: +92-42-37250130			DRG. NO.	ST-01			

GENERAL TECHNICAL NOTES

- Figured dimensions are to be followed. 1.
- 2. Class "A" kiln burnt brick with minimum crushing strength of 2000 PSI should be used & joint at end should be sloppy, Vertical toothed joint at corners are prohibited.
- 3. A steel G-60 deformed steel should be used in beams footing slabs and water retaining structures, in columns, for all diameters.
- All steel should be checked for its quality and placement 4. DETAIL as shown in drawings.
- Extra care is required for proper placement of top 5. reinforcement at support sections and cantilevers.
- Dotted bars designate top reinforcement. 6.
- Provide L- shaped end hooks for all bars at discontinuous 7. ends in footings, walls, beams and slabs as shown in drawings.
- Lap length should be followed As except specified:-8.
 - (a) 1" Ø = 60" (b) 3/4" Ø = 45" (c) 5/8" Ø = 36" (d) 1/2" Ø = 30" (e) 3/8" Ø = 23"
- Provide 3/8" dia at 12" c/c as distribution steel if not 09. shown in drawings.
- Minimum concrete cover. 10.

а) Footing	= 2"	e) Water tank and retaining wall
b) Slabs	= 3/4"	i- Water/earth face or
C	Beams	= 1½"	exposed to weather = 2"
d) Columns	= 1½"	ii- Other faces = 1"


- 11. All footing should be taken below the original Ground Level to achieve the minimum depth as shown in drawings. Footing should not be placed on uncompacted fill area.
- 12. All drawings should be read in conjunction with Architectural Drawings.
- Contractor will co-ordinate all drawings such as architectural, structural, electrical, mechanical, water supply, drainage etc: 13. before execution of work.
- 14. Standard ACI 318, Astm C 33 and Astm A-615 use for structural concrete
- 15. Fine modulus of fine aggregate varies from 2-3.5mm For concrete use 2.9-3.2mm For plaster use 2.2-3.6mm QUALITY OF CONCRETE
- FOOTINGS & RETAINING WALLS. 1. Minimum concrete compressive strength for 6"x12" cylinder to be 3000 psi at 28 days age. Concrete Nominal Mix 1:2:4 or more rich to provide specified strength (Equivalent 6"x6"x6" cube strength 3750 psi)


2. COLUMNS.

Minimum concrete compressive strength for 6"x12" cylinder to be 4000 psi at 28 days age. Concrete Nominal Mix to be $1:1\frac{1}{2}:3$ or more rich to provide specified strength


- 3. BEAMS, RIBS & SLABS.


- WALL BEAMS AT SLAB LEVEL.

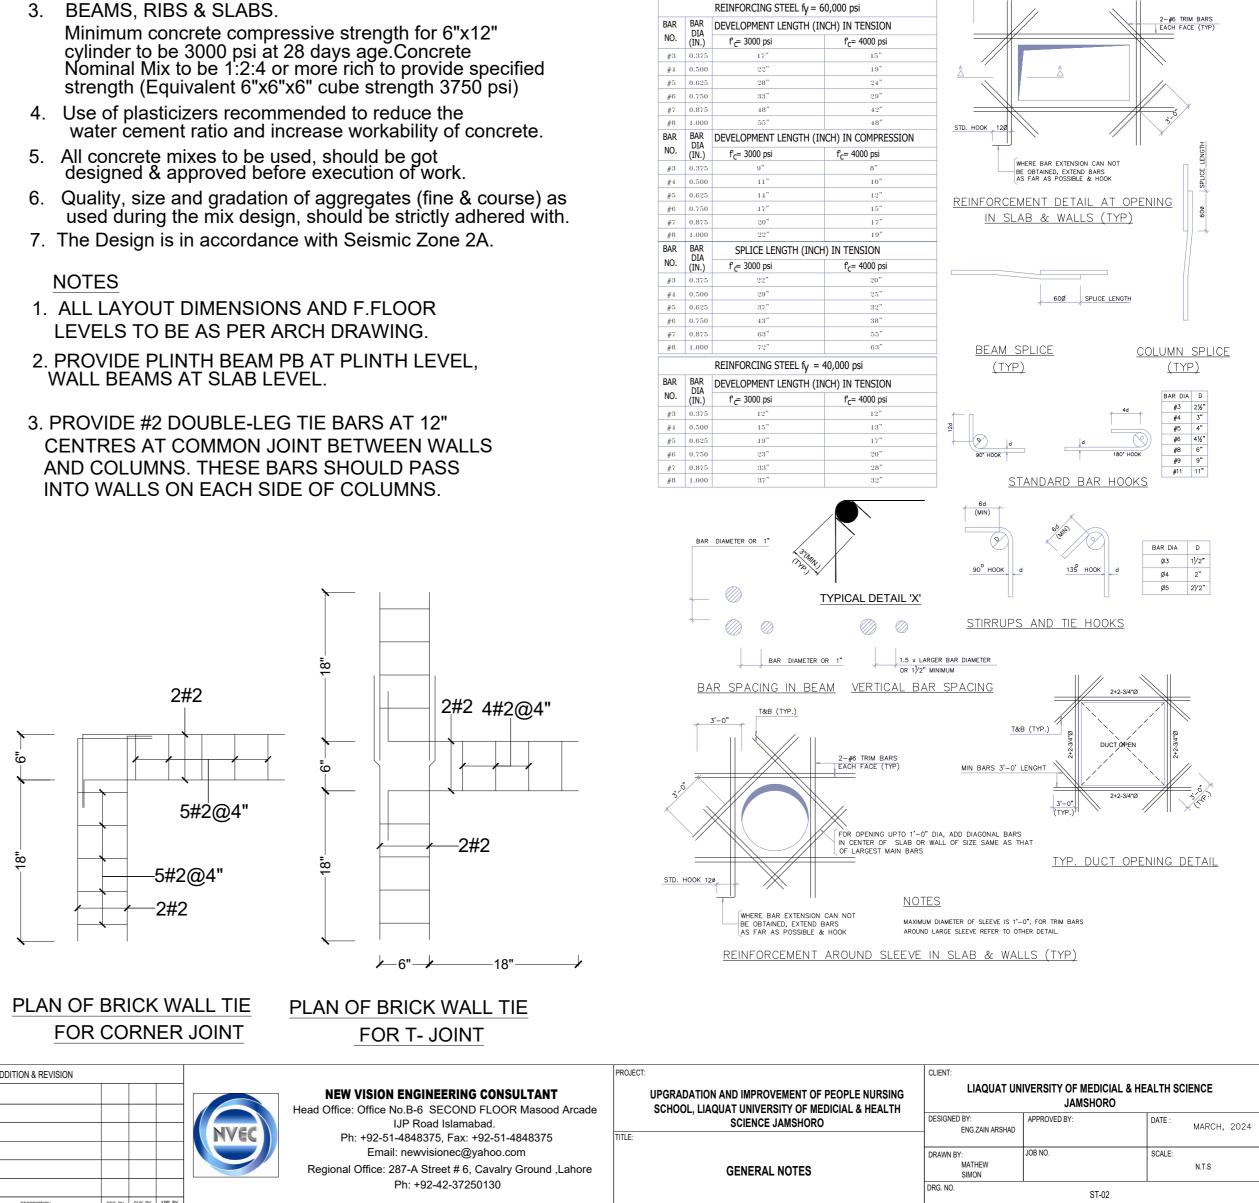


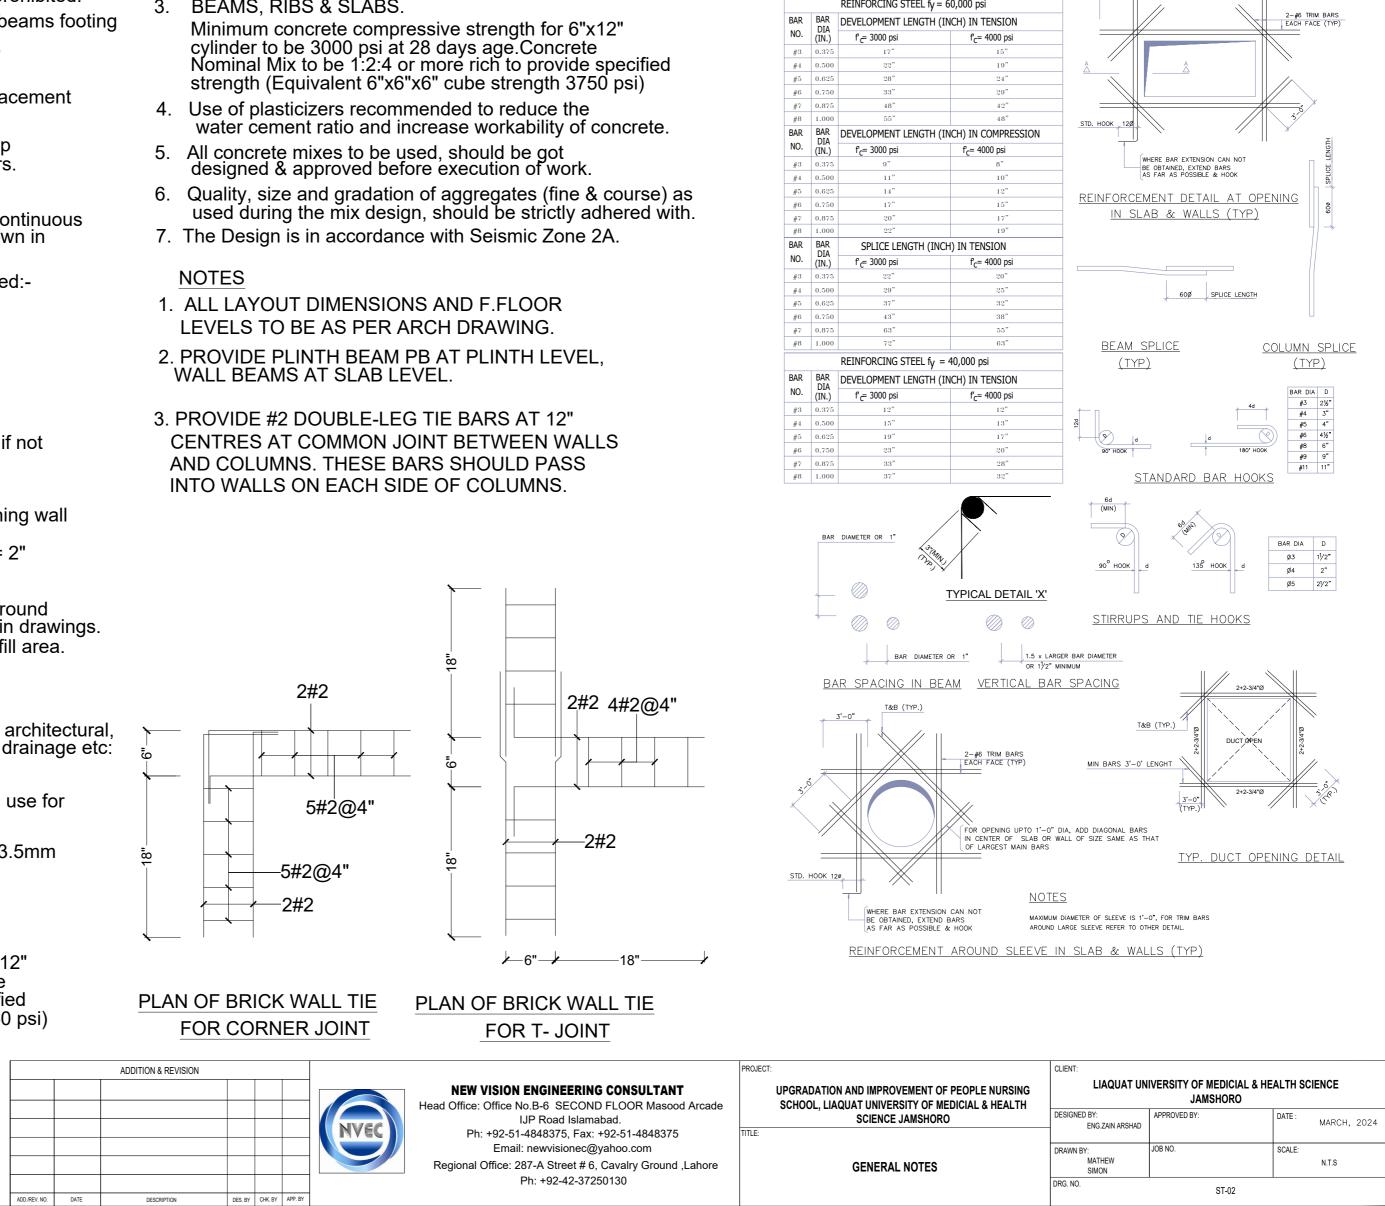


REINFORCING STEEL

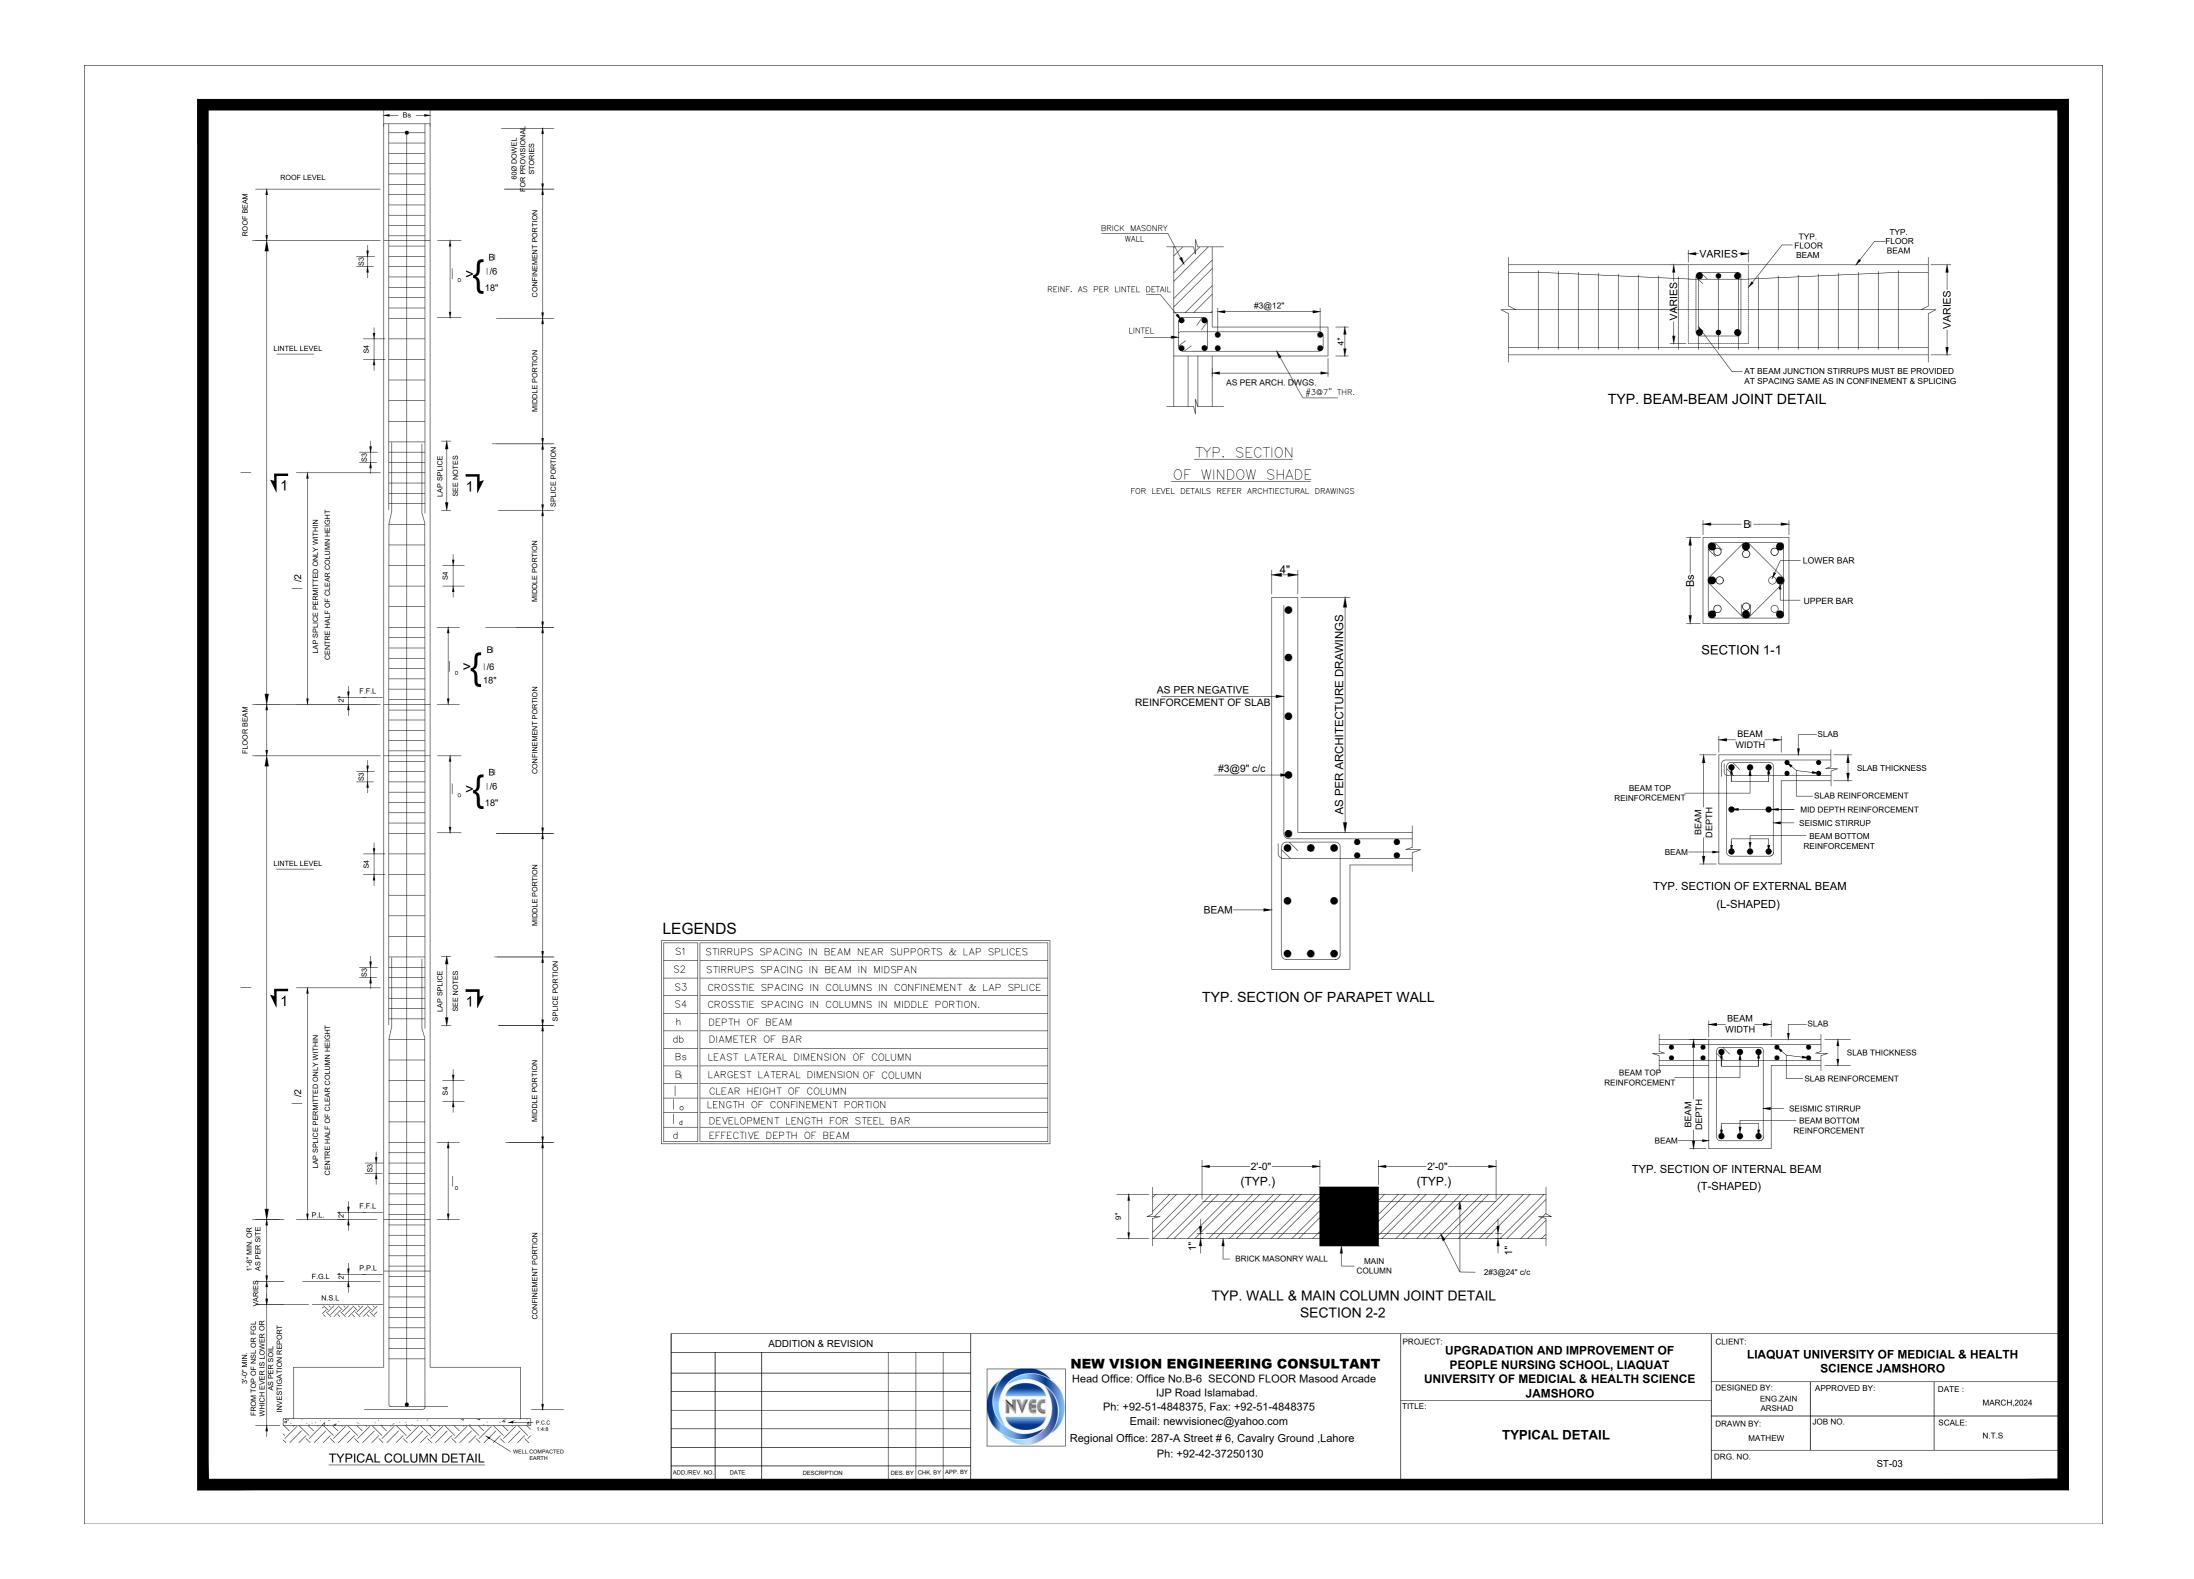


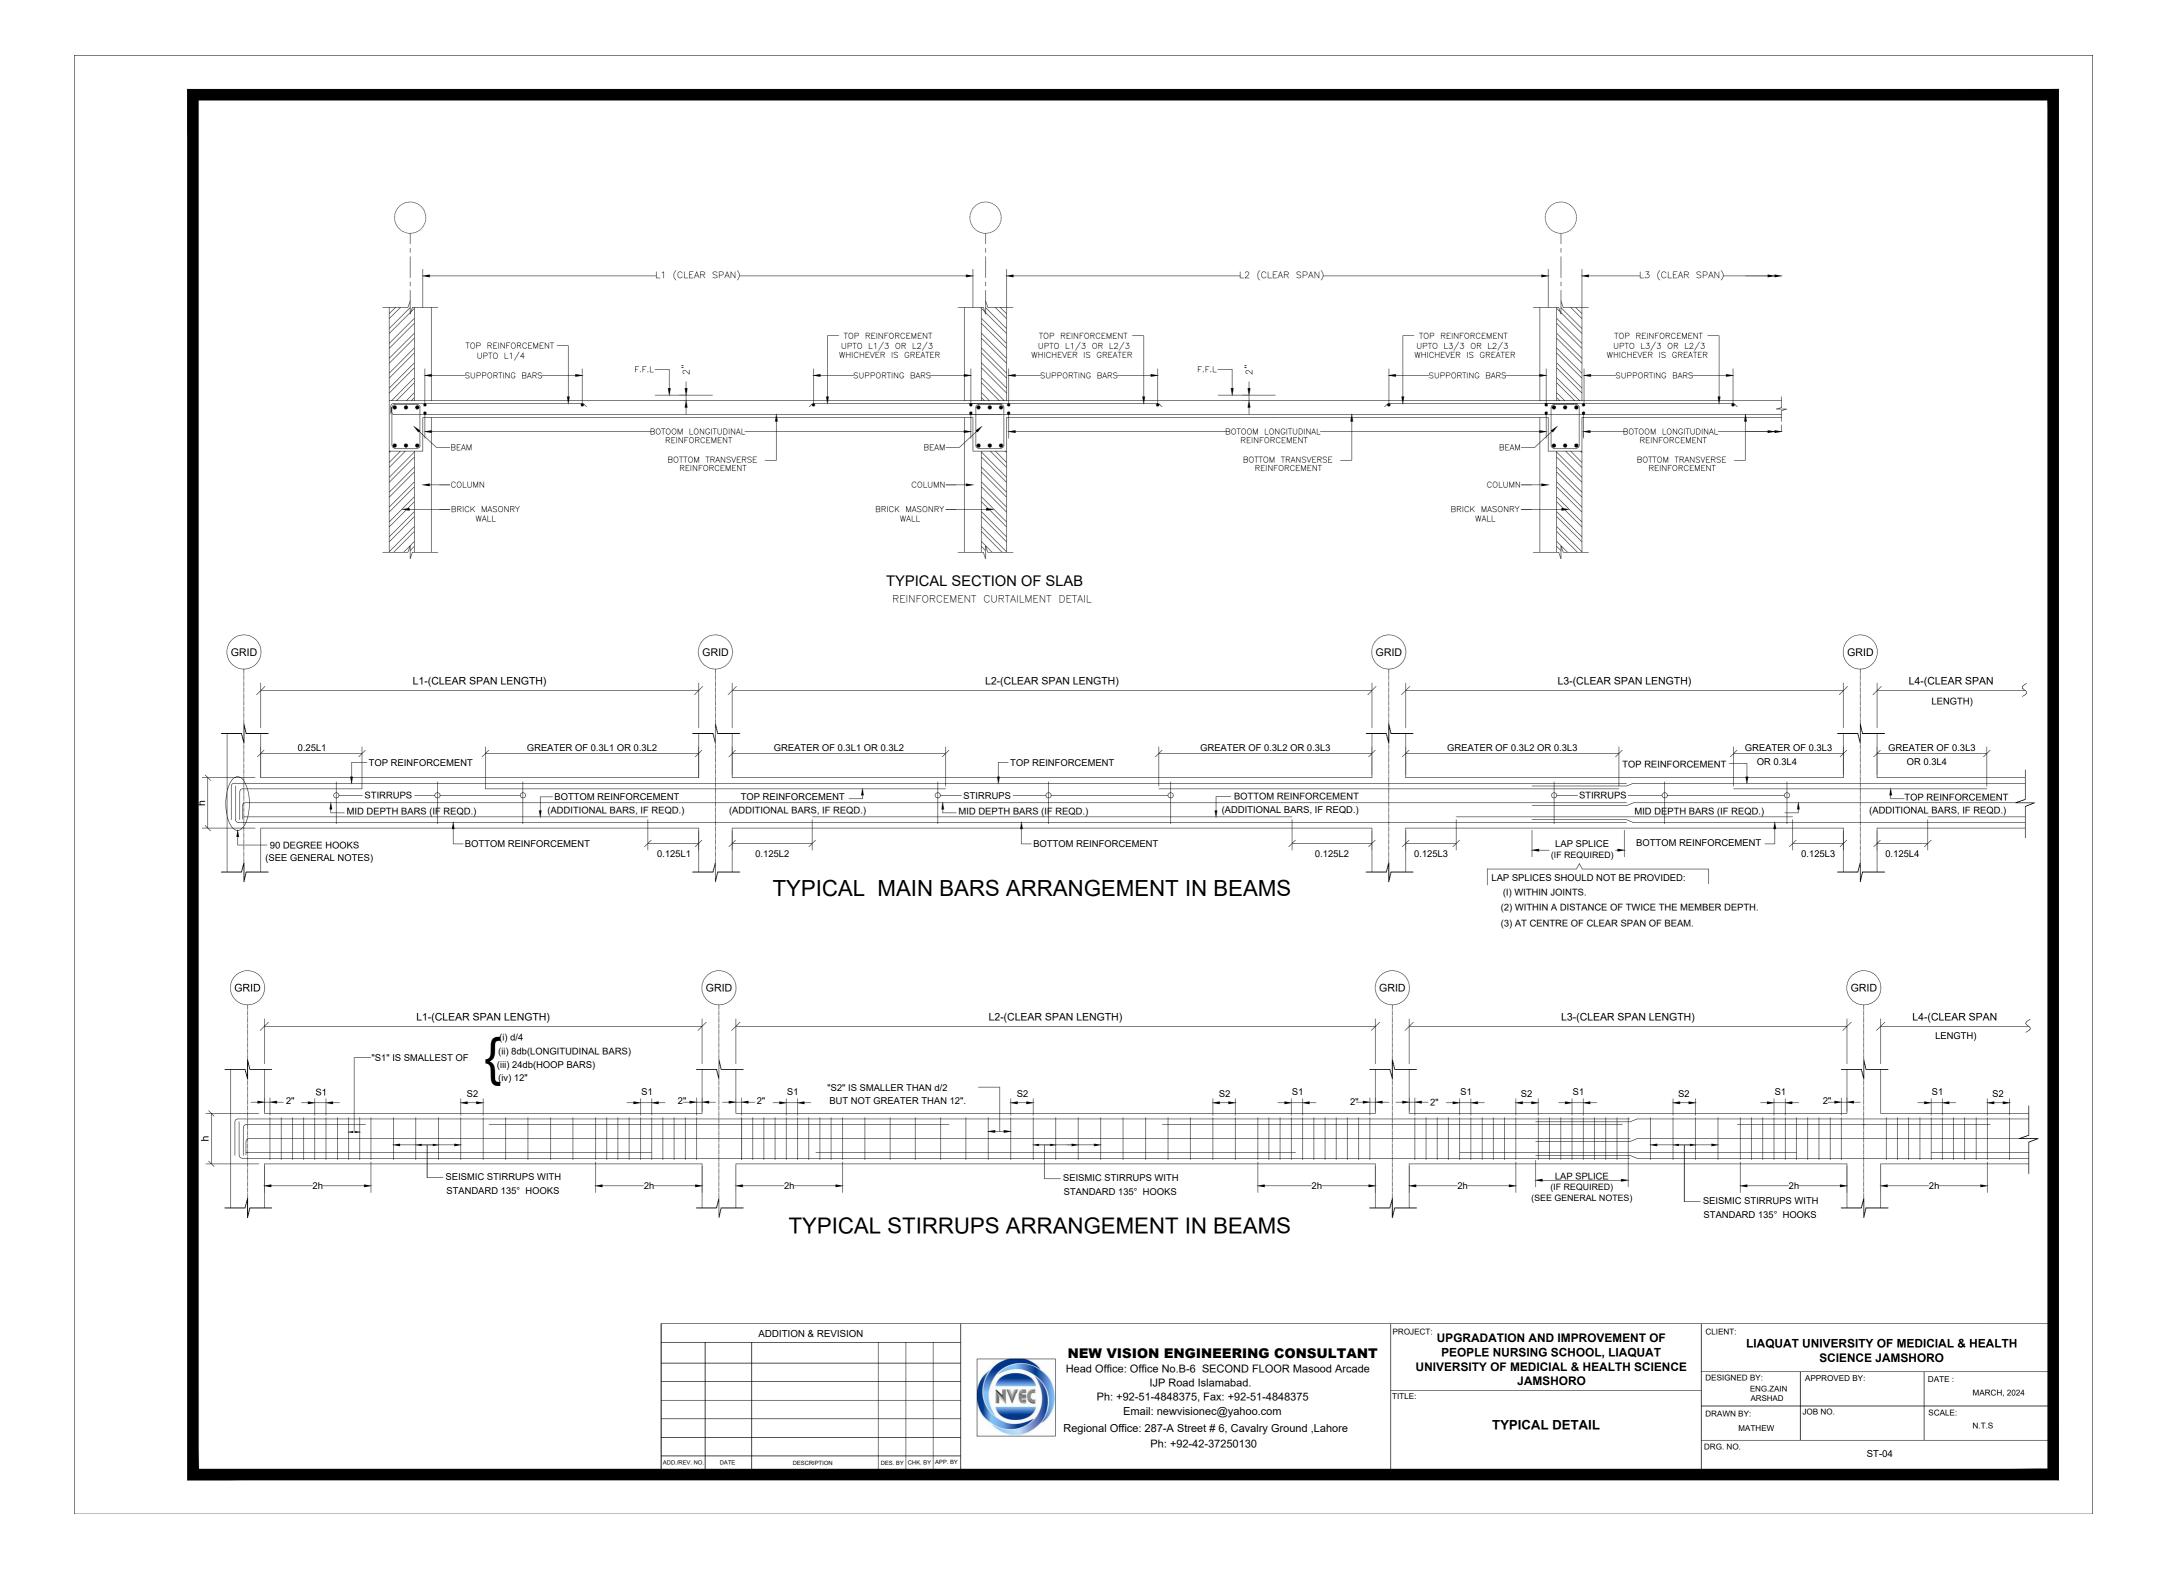

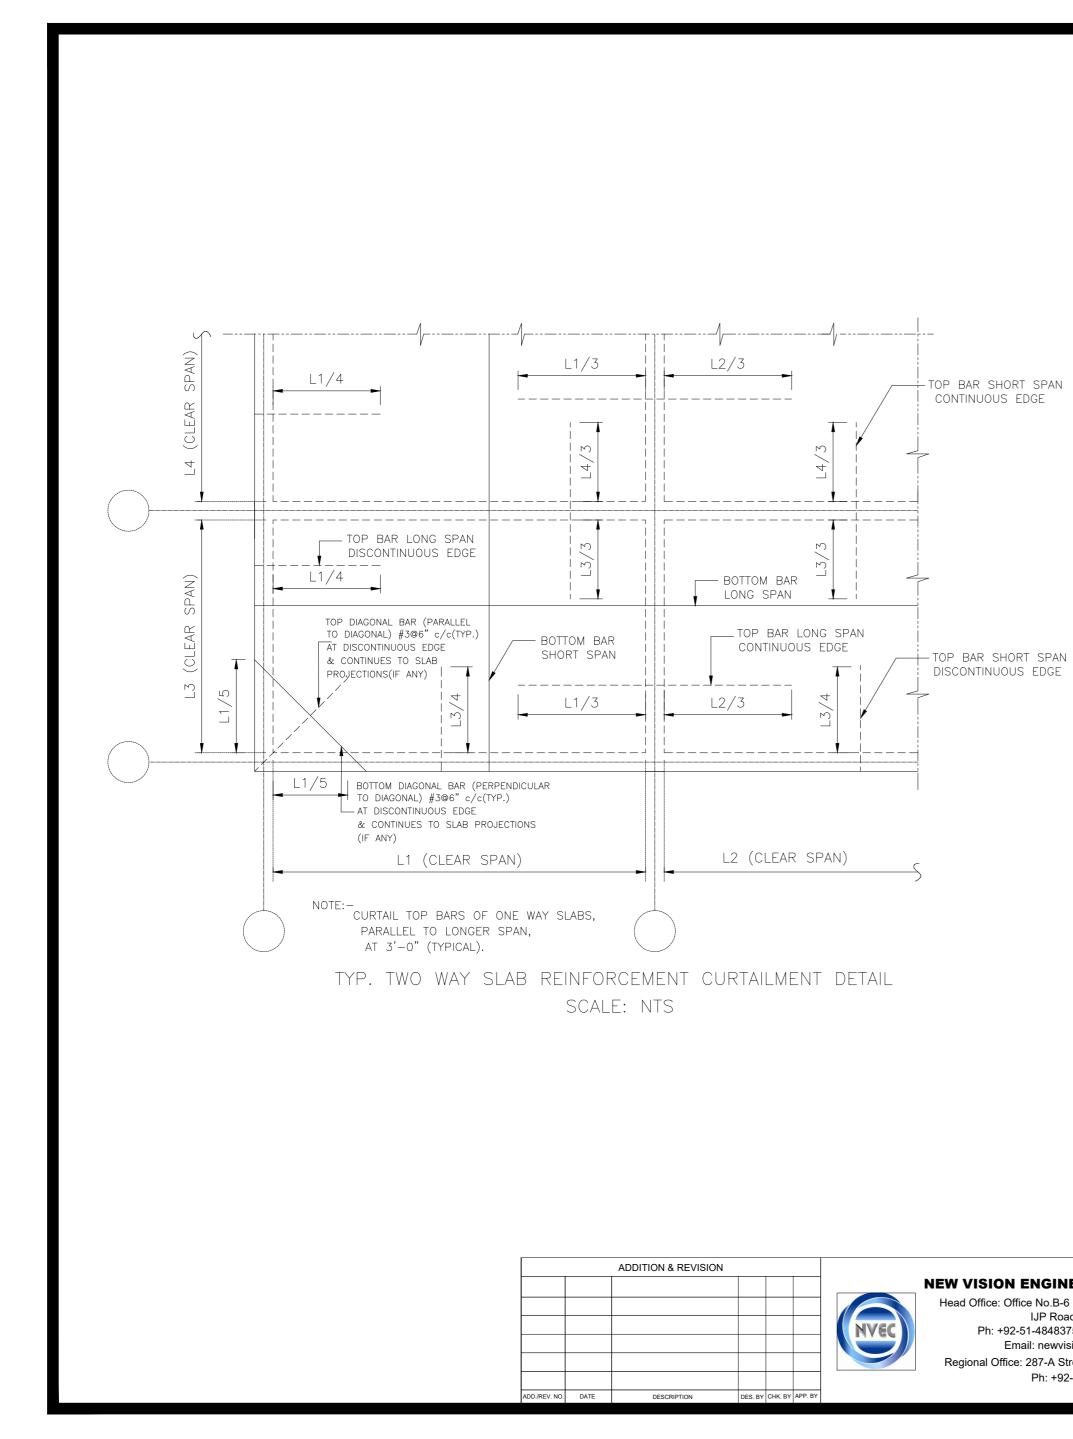

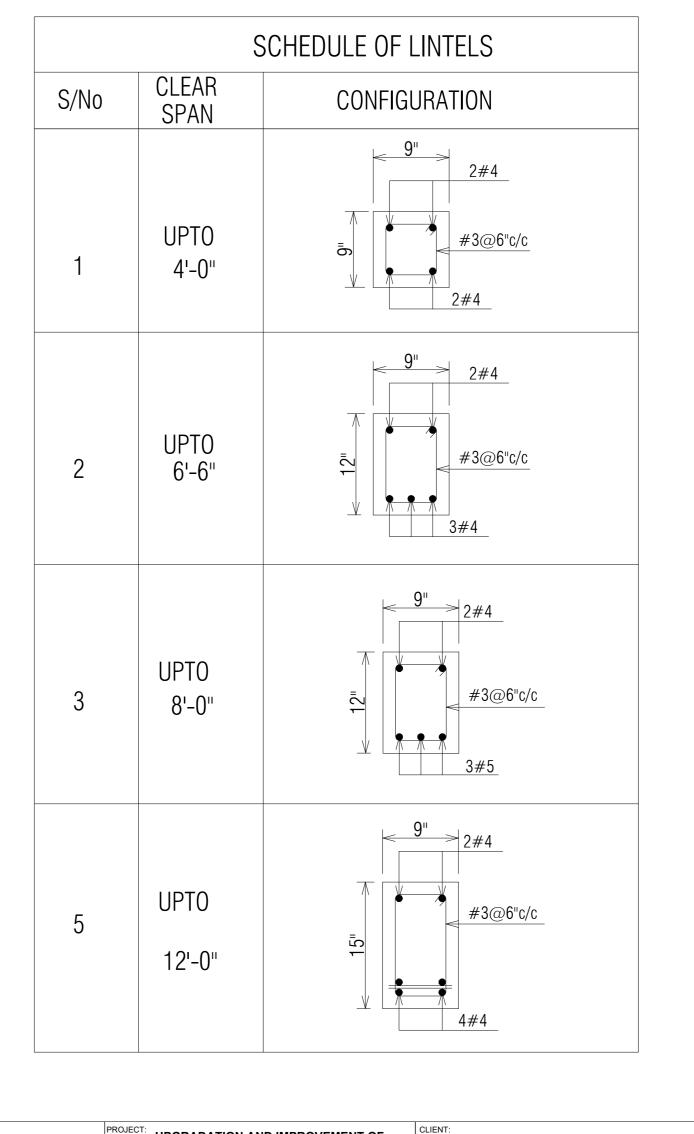

PROJECT: UPGRADATION AND IMPROVEMENT OF CLIENT: LIAQUAT UNIVERSITY OF MEDICIAL & HEALTH **NEW VISION ENGINEERING CONSULTANT** PEOPLE NURSING SCHOOL, LIAQUAT SCIENCE JAMSHORO Head Office: Office No.B-6 SECOND FLOOR Masood Arcade UNIVERSITY OF MEDICIAL & HEALTH SCIENCE DESIGNED BY APPROVED BY DATE IJP Road Islamabad. JAMSHORO ENG.ZAIN ARSHAD MARCH, 2024 Ph: +92-51-4848375, Fax: +92-51-4848375 TITLE: Email: newvisionec@yahoo.com JOB NO. DRAWN BY: SCALE: TYPICAL DETAIL N.T.S Regional Office: 287-A Street # 6, Cavalry Ground ,Lahore MATHEW Ph: +92-42-37250130 DRG. NO. ST-05

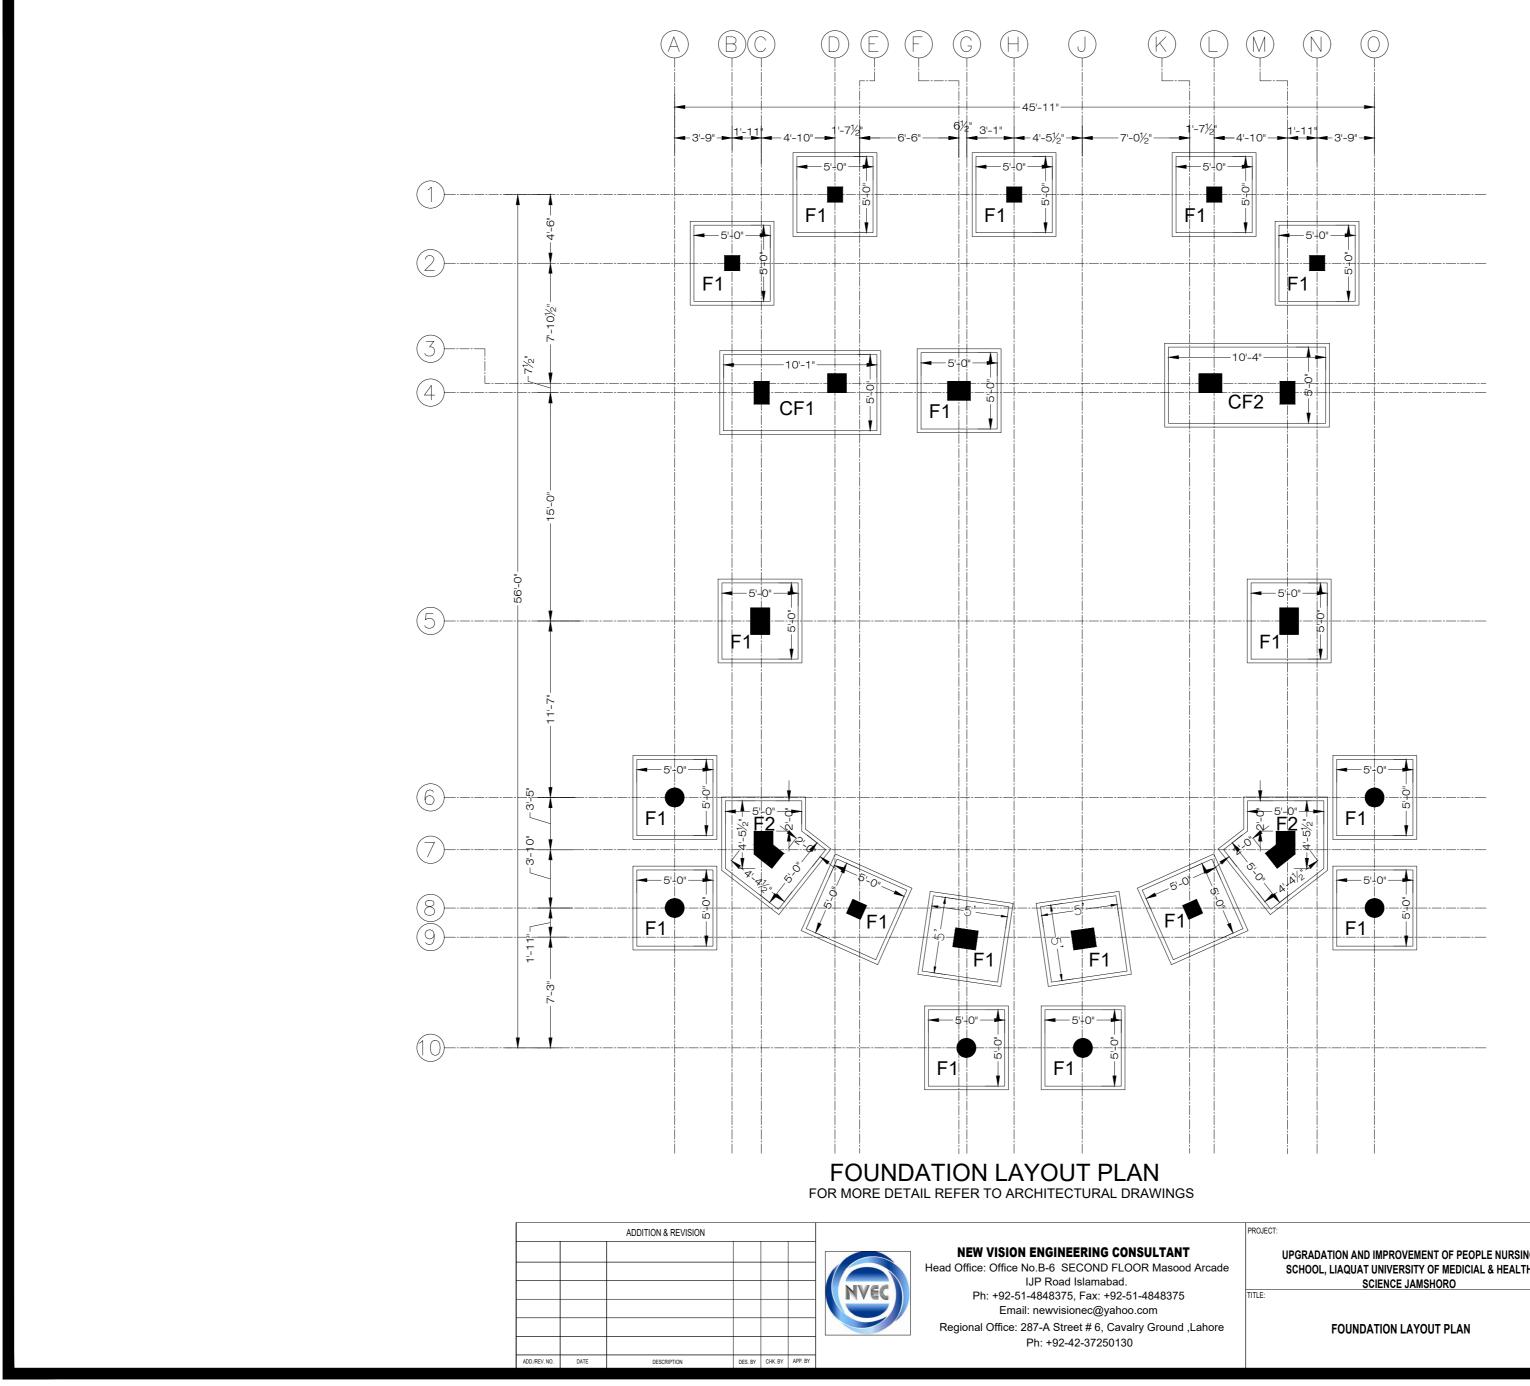

	CLIENT:							
NG H	LIAQUAT UNIVERSITY OF MEDICIAL & HEALTH SCIENCE JAMSHORO							
н	DESIGNED BY: ENG.ZAIN ARSHAD	APPROVED BY:	DATE :	MARCH, 2024				
	DRAWN BY: MATHEW SIMON	JOB NO.	SCALE:	N.T.S				
	DRG. NO.	ST-06						


SCHEDULE OF FOOTINGS


	SIZE REINFORCEMENT DETAIL							
1	Δ.		BOTTC	OM BARS	TOP E	BARS	REMARKS	
	VV		BS	BL	TS	TL		
-0" 5'-	0"	9"	#4@8" c/c	#4@8" c/c			ISOLATED FOOTING	
AS PER PLAN	J ,	12"	#4@7" c/c	#4@7" c/c			ISOLATED FOOTING	
)" 5'-()" 5'-0" 9"	L W H1 BS 0" 5'-0" 9" #4@8" c/c	BS BL 0" 5'-0" 9" #4@8" c/c	L W H1 BS BL TS 0" 5'-0" 9" #4@8" c/c #4@8" c/c	W H1 BS BL TS TL 0" 5'-0" 9" #4@8" c/c #4@8" c/c #4@8" c/c #4@8" c/c	


CF1	10'-1"	5'-0"	15"	#4@6" c/c	#4@6" c/c
CF2	10'-4"	5'-0"	15"	#4@6" c/c	#4@6" c/c


Image: Construction of the construc							
Image: Construction of the construc	<i>I</i>	ADDITION & REVISION		PROJECT:	CLIENT:		
IJP Road Islamabad. IJP Road				SCHOOL, LIAQUAT UNIVERSITY OF MEDICIAL & HEALTH	LIAQUAT UNIVERSITY OF MEDICIAL & HEALTH SCIENCE JAMSHORO		
			IJP Road Islamabad. Ph: +92-51-4848375, Fax: +92-51-4848375			APPROVED BY:	DATE: MARCH, 2024
regional Office. 207-A Street # 0, Cavally Glound ,Lanore FOUNDATION SCHEDULE SMON			Regional Office: 287-A Street # 6, Cavalry Ground ,Lahore	FOUNDATION SCHEDULE	MATHEW	JOB NO.	SCALE: N.T.S
Ph: +92-42-37250130			Ph: +92-42-37250130		DRG. NO.	ST-07	
ADD.REV. NO. DATE DESCRIPTION DES. BY CHK. BY APP. BY	DD./REV. NO. DATE	DESCRIPTION DES. BY CHK. BY APP. BY					

C	#3@8" c/c	#3@8" c/c	COMBINED FOOTING
C	#3@8" c/c	#3@8" c/c	COMBINED FOOTING

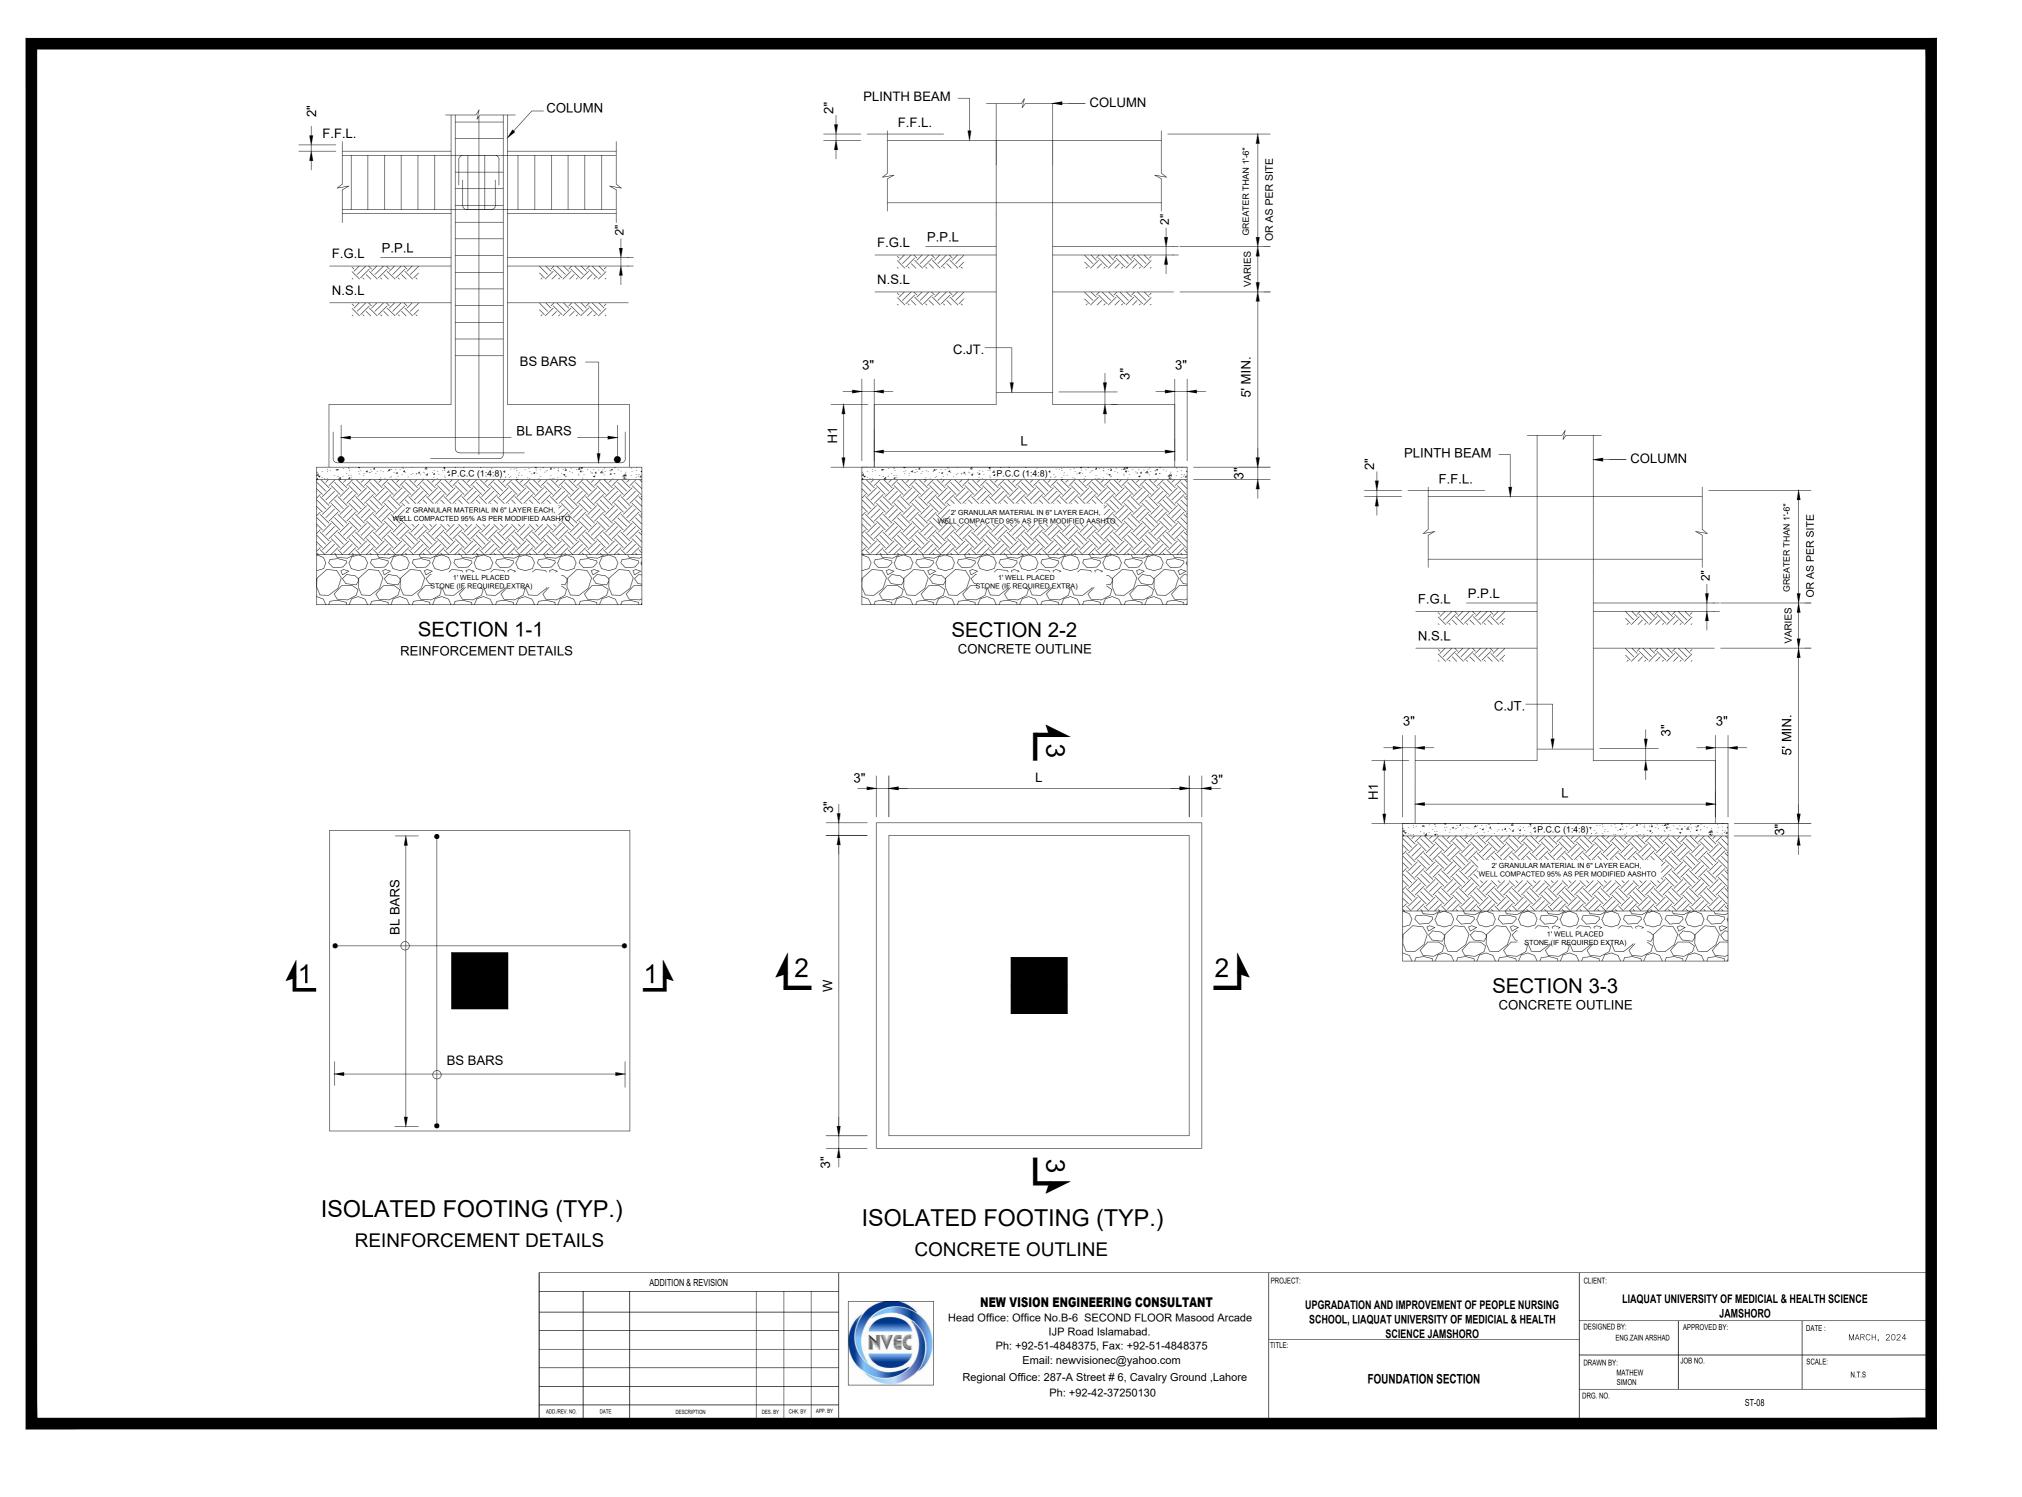

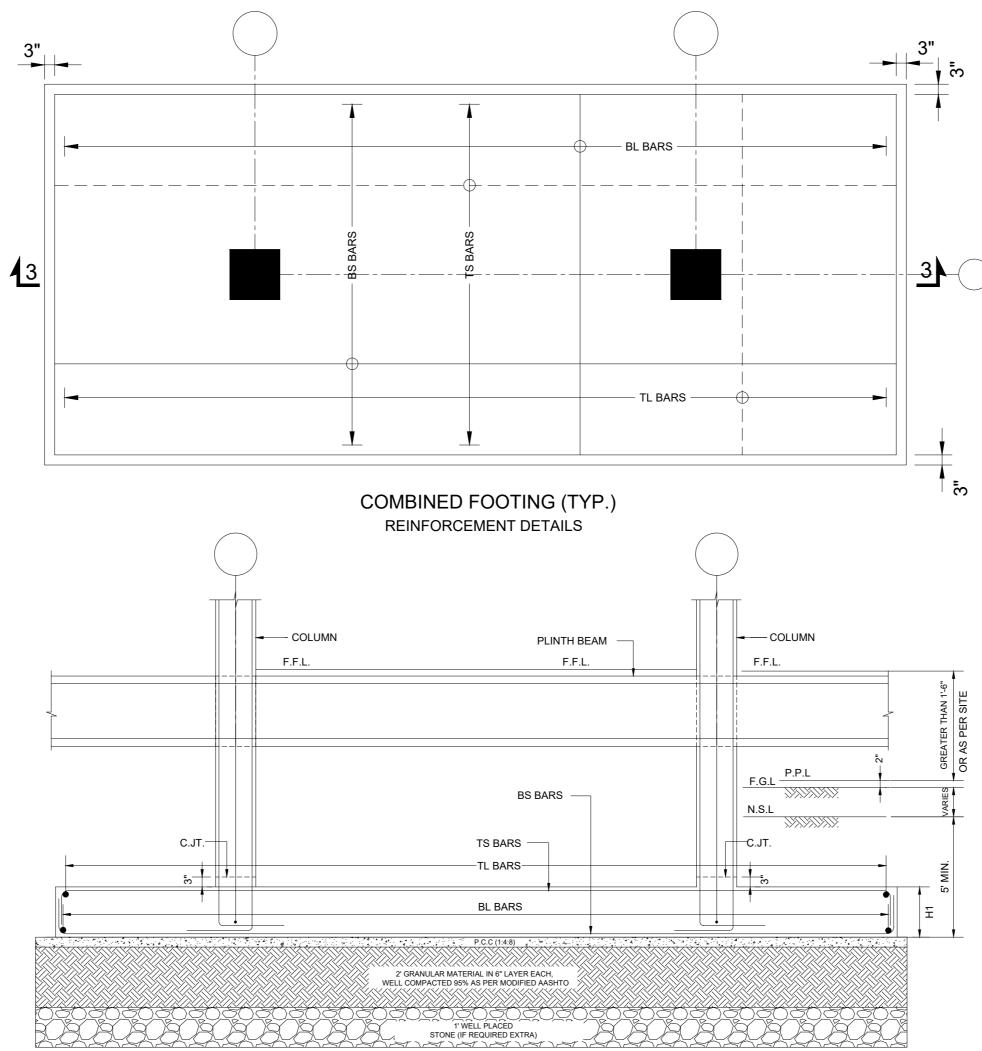

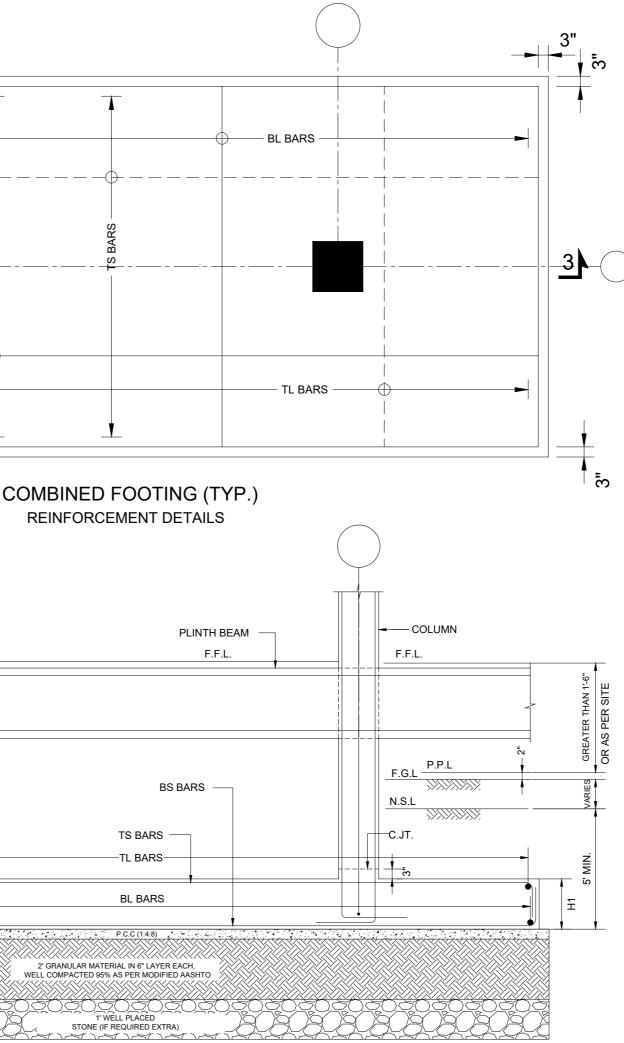


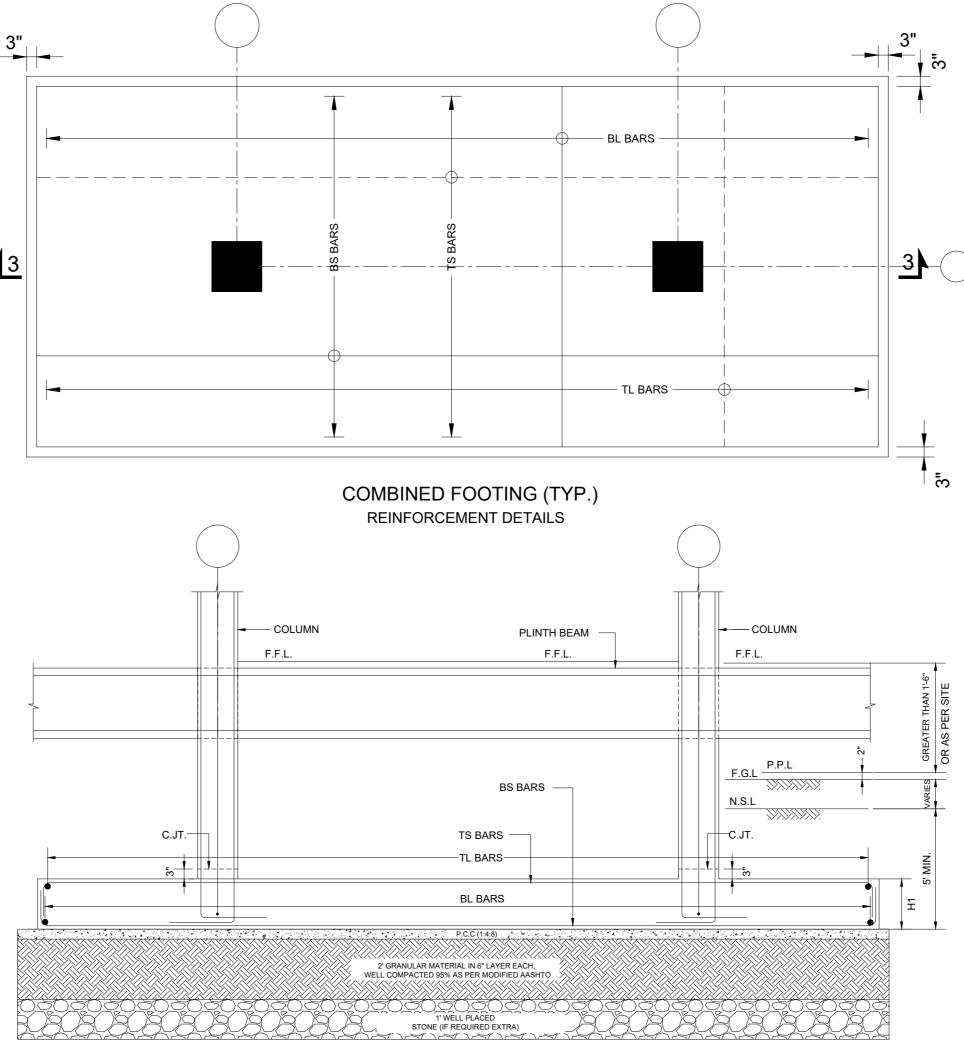







	PROJECT:	CLIENT:		
ON ENGINEERING CONSULTANT	UPGRADATION AND IMPROVEMENT OF PEOPLE NURSING SCHOOL, LIAQUAT UNIVERSITY OF MEDICIAL & HEALTH	LIAQUAT UN	IVERSITY OF MEDICIAL & HE JAMSHORO	ALTH SCIENCE
IJP Road Islamabad. 51-4848375, Fax: +92-51-4848375		DESIGNED BY: ENG.ZAIN ARSHAD	APPROVED BY:	DATE: MARCH, 2024
ail: newvisionec@yahoo.com : 287-A Street # 6, Cavalry Ground ,Lahore	FOUNDATION SECTION	DRAWN BY: MATHEW SIMON	JOB NO.	SCALE: N.T.S
Ph: +92-42-37250130		DRG. NO.	ST-09	

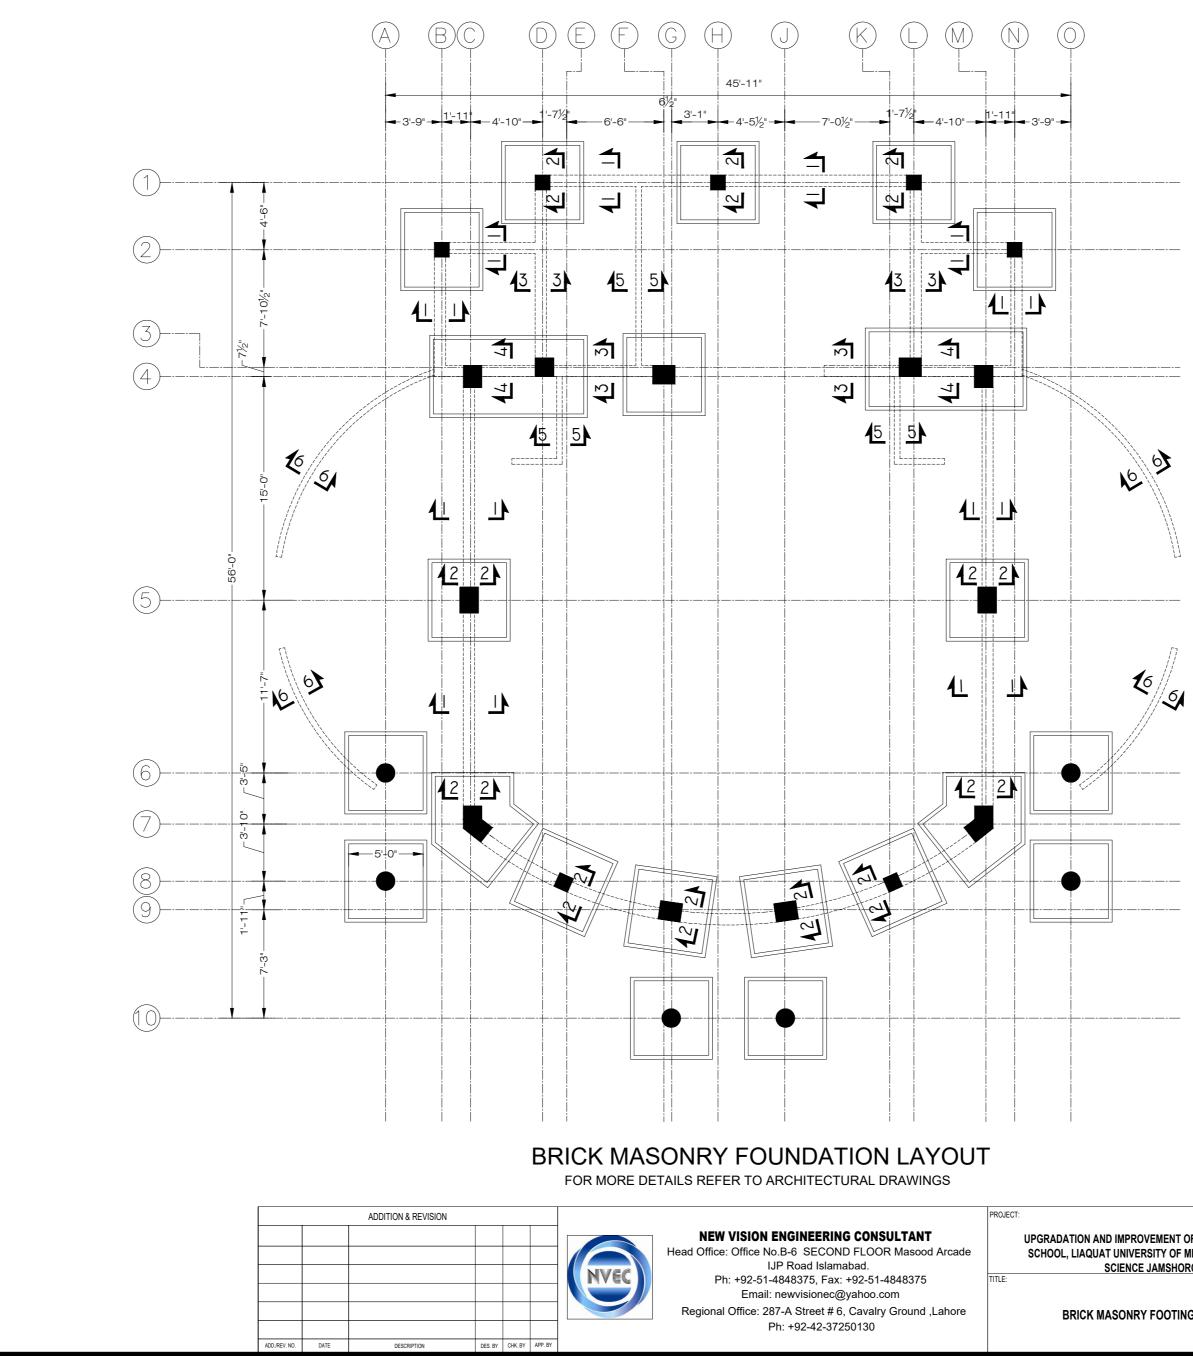


	PROJECT:	CLIENT:		
I ENGINEERING CONSULTANT	UPGRADATION AND IMPROVEMENT OF PEOPLE NURSING SCHOOL, LIAQUAT UNIVERSITY OF MEDICIAL & HEALTH	LIAQUAT UN	IVERSITY OF MEDICIAL & HE JAMSHORO	ALTH SCIENCE
IJP Road Islamabad.	SCIENCE JAMSHORO	DESIGNED BY: ENG.ZAIN ARSHAD	APPROVED BY:	DATE: MARCH, 2024
I: newvisionec@yahoo.com 287-A Street # 6, Cavalry Ground ,Lahore	BRICK MASONRY FOOTING LAYOUT	DRAWN BY: MATHEW SIMON	JOB NO.	SCALE: N.T.S
Ph: +92-42-37250130		DRG. NO.	ST-10	

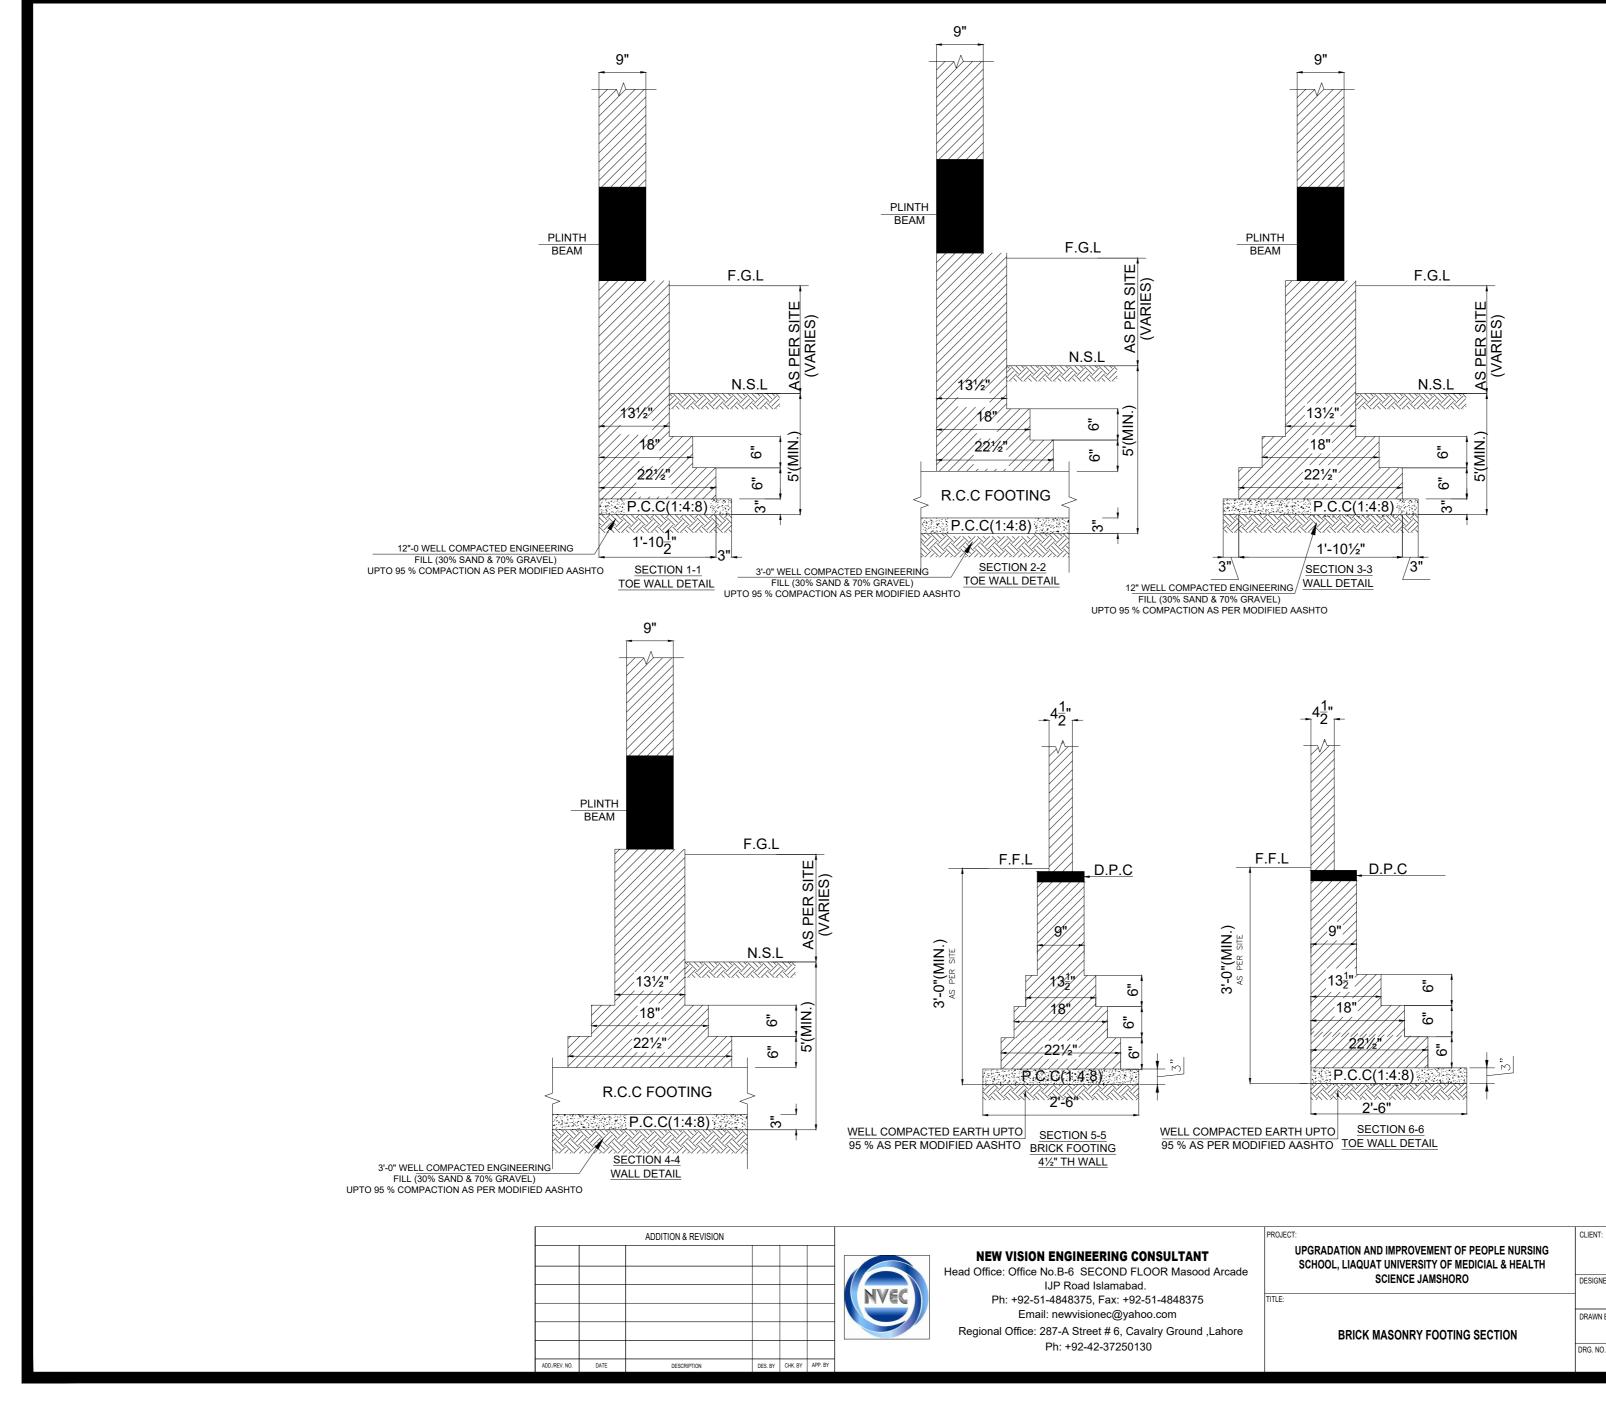


CLIENT: LIAQUAT UNIVERSITY OF MEDICIAL & HEALTH SCIENCE JAMSHORO				
 DESIGNED BY: ENG.ZAIN ARSHAD	APPROVED BY:	DATE :	MARCH, 2024	
DRAWN BY: MATHEW SIMON	JOB NO.	SCALE:	N.T.S	
DRG. NO.	ST-11			

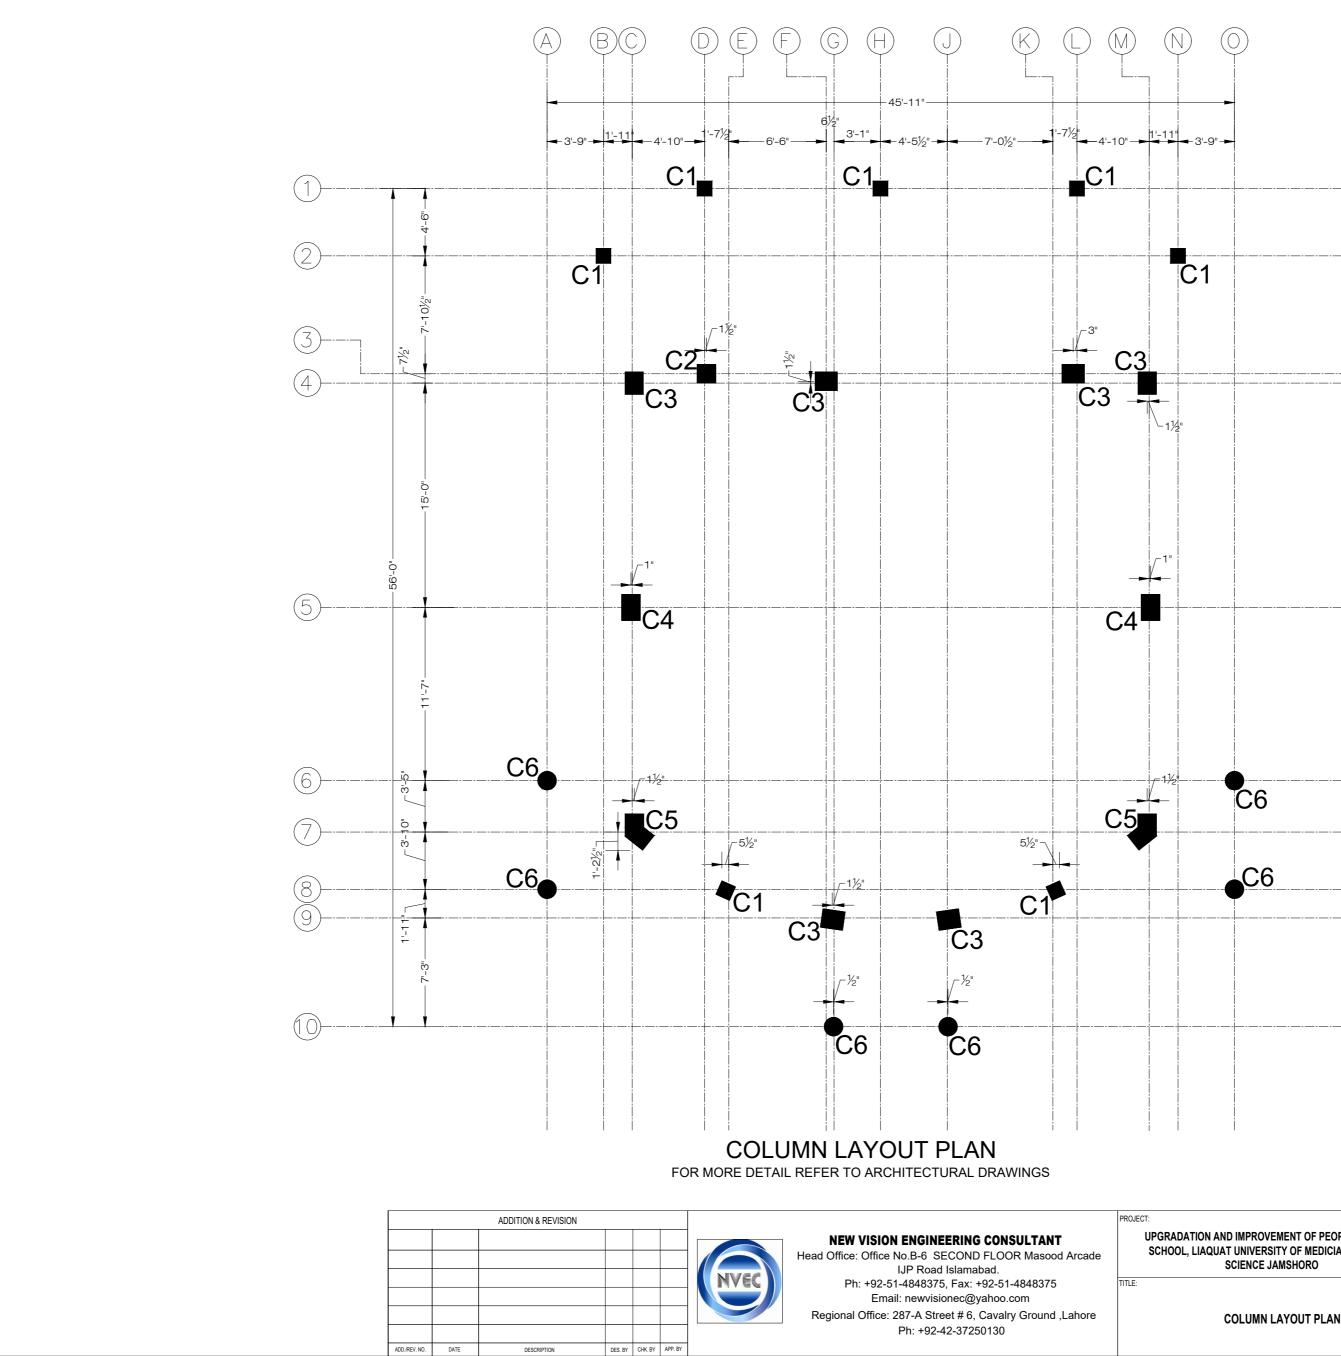


ENGINEERING CONSULTANT	PROJECT: UPGRADATION AND IMPROVEMENT OF PEOPLE NURSING SCHOOL, LIAQUAT UNIVERSITY OF MEDICIAL & HEALTH	CLIENT: LIAQUAT UNIVERSITY OF MEDICIAL & HEALTH SCIENCE JAMSHORO			
IJP Road Islamabad. -4848375, Fax: +92-51-4848375	SCIENCE JAMSHORO	DESIGNED BY: ENG.ZAIN ARSHAD	APPROVED BY:	DATE: MARCH, 2024	
: newvisionec@yahoo.com 87-A Street # 6, Cavalry Ground ,Lahore	COLUMN LAYOUT PLAN	DRAWN BY: MATHEW SIMON	JOB NO.	SCALE: N.T.S	
Ph: +92-42-37250130		DRG. NO.	ST-12		

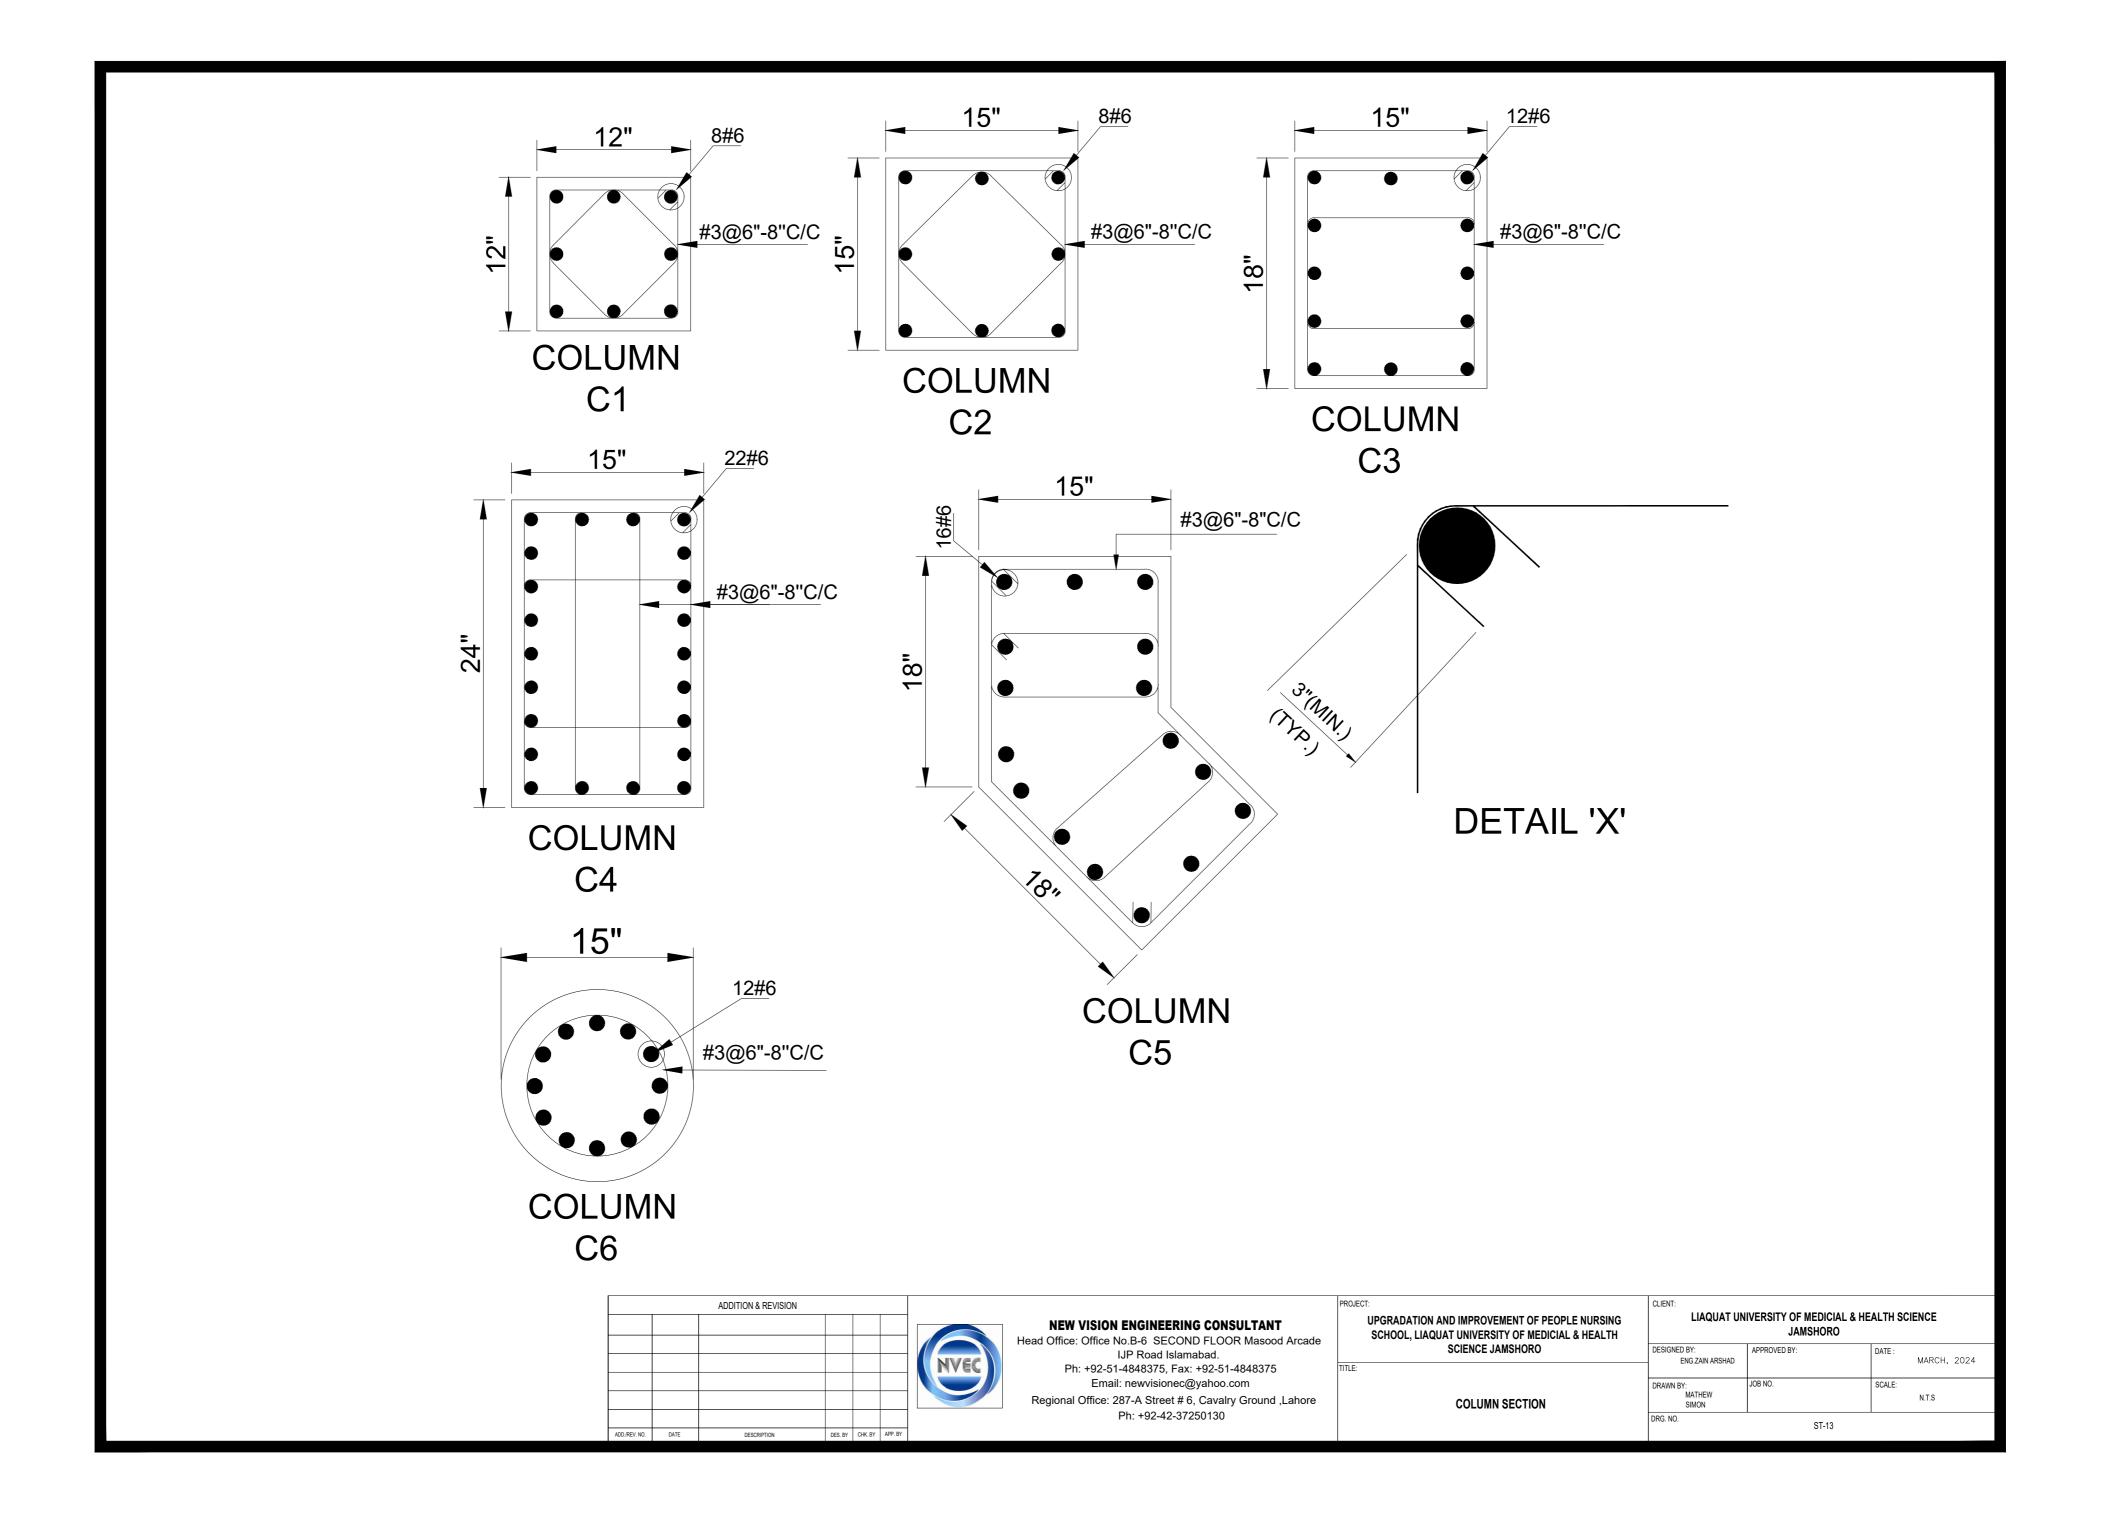


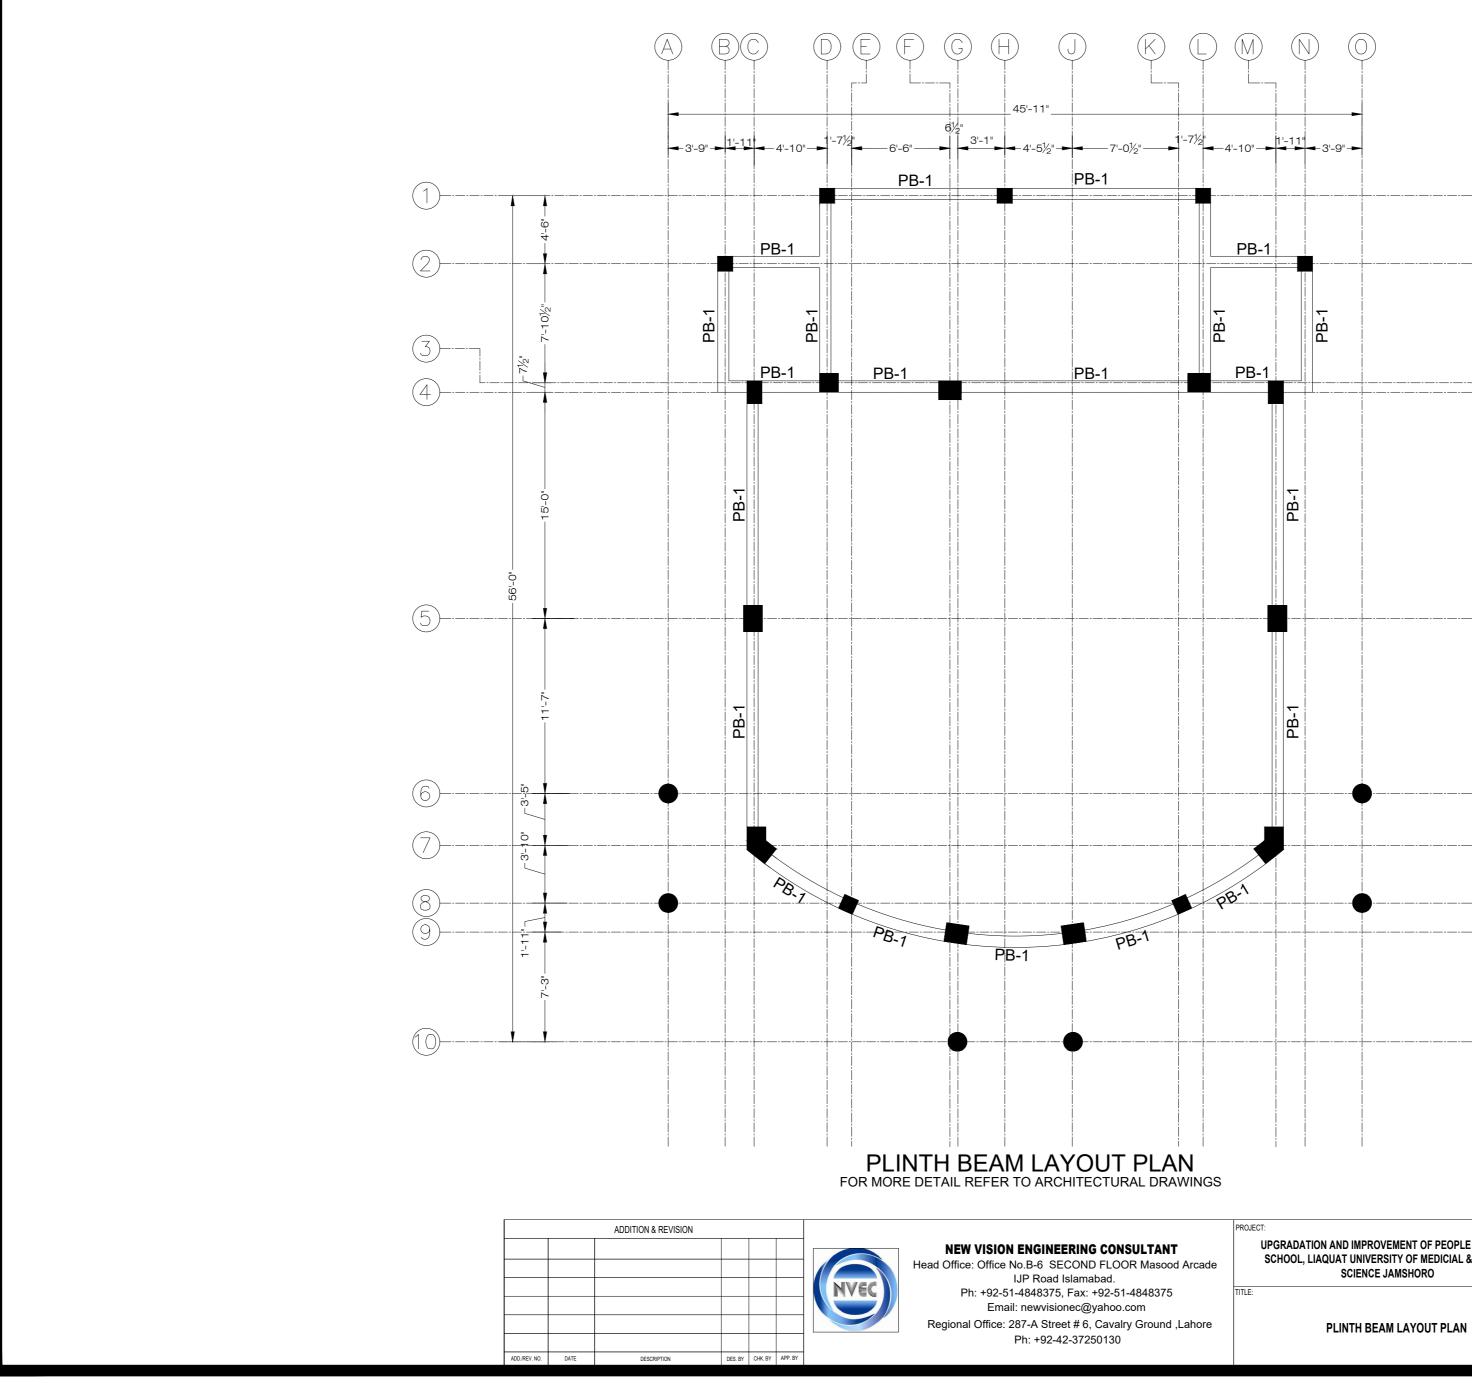

UPGRADATION AND IMPROVEMENT OF PEOPLE NURSING SCHOOL, LIAQUAT UNIVERSITY OF MEDICIAL & HEALTH


	LIAQUAT UNIVERSITY OF MEDICIAL & HEALTH SCIENCE JAMSHORO				
DESIGNED BY: ENG.ZAIN ARSHAD	APPROVED BY:	DATE :	MARCH, 2024		
DRAWN BY: MATHEW SIMON	JOB NO.	SCALE:	N.T.S		
DRG. NO.	ST-14				

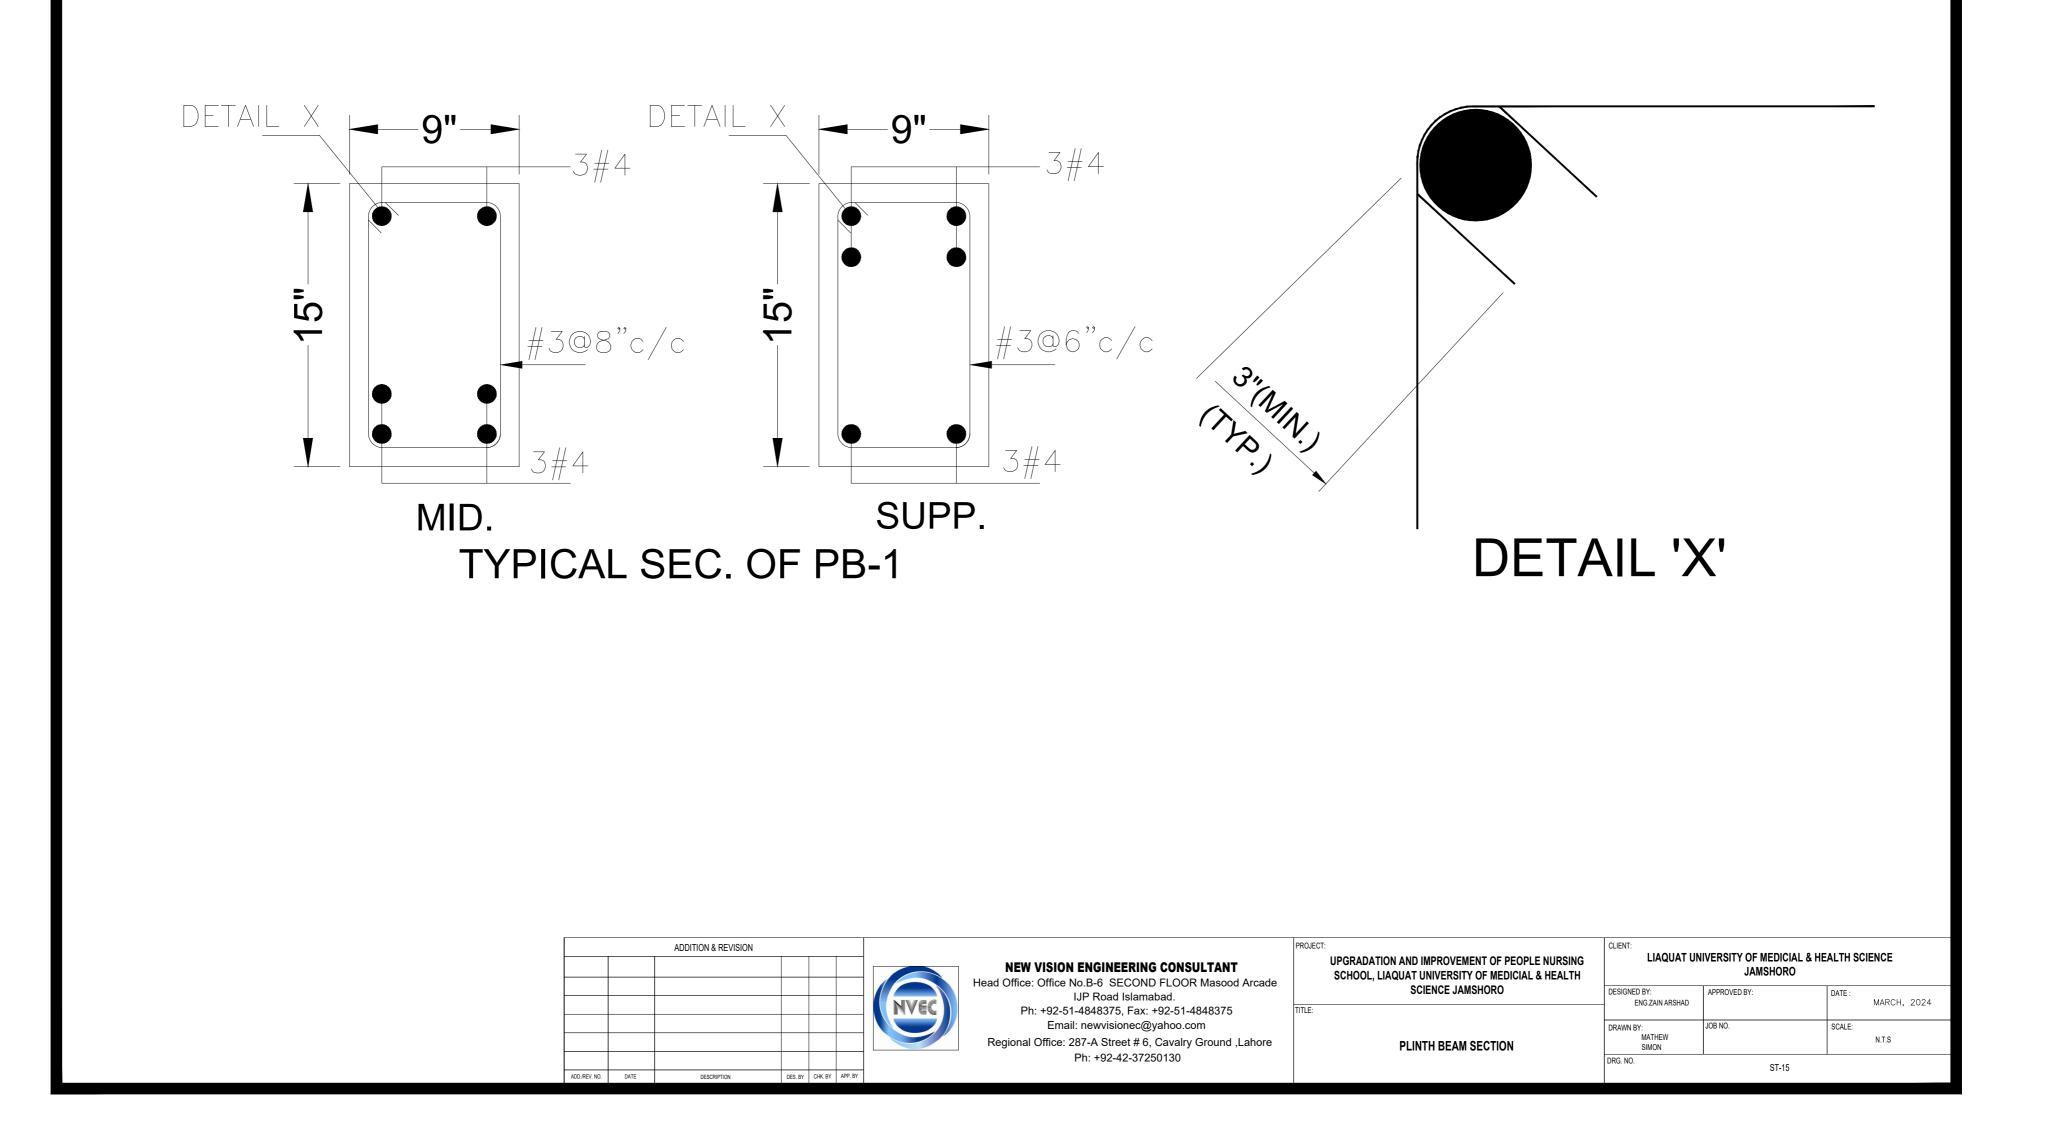


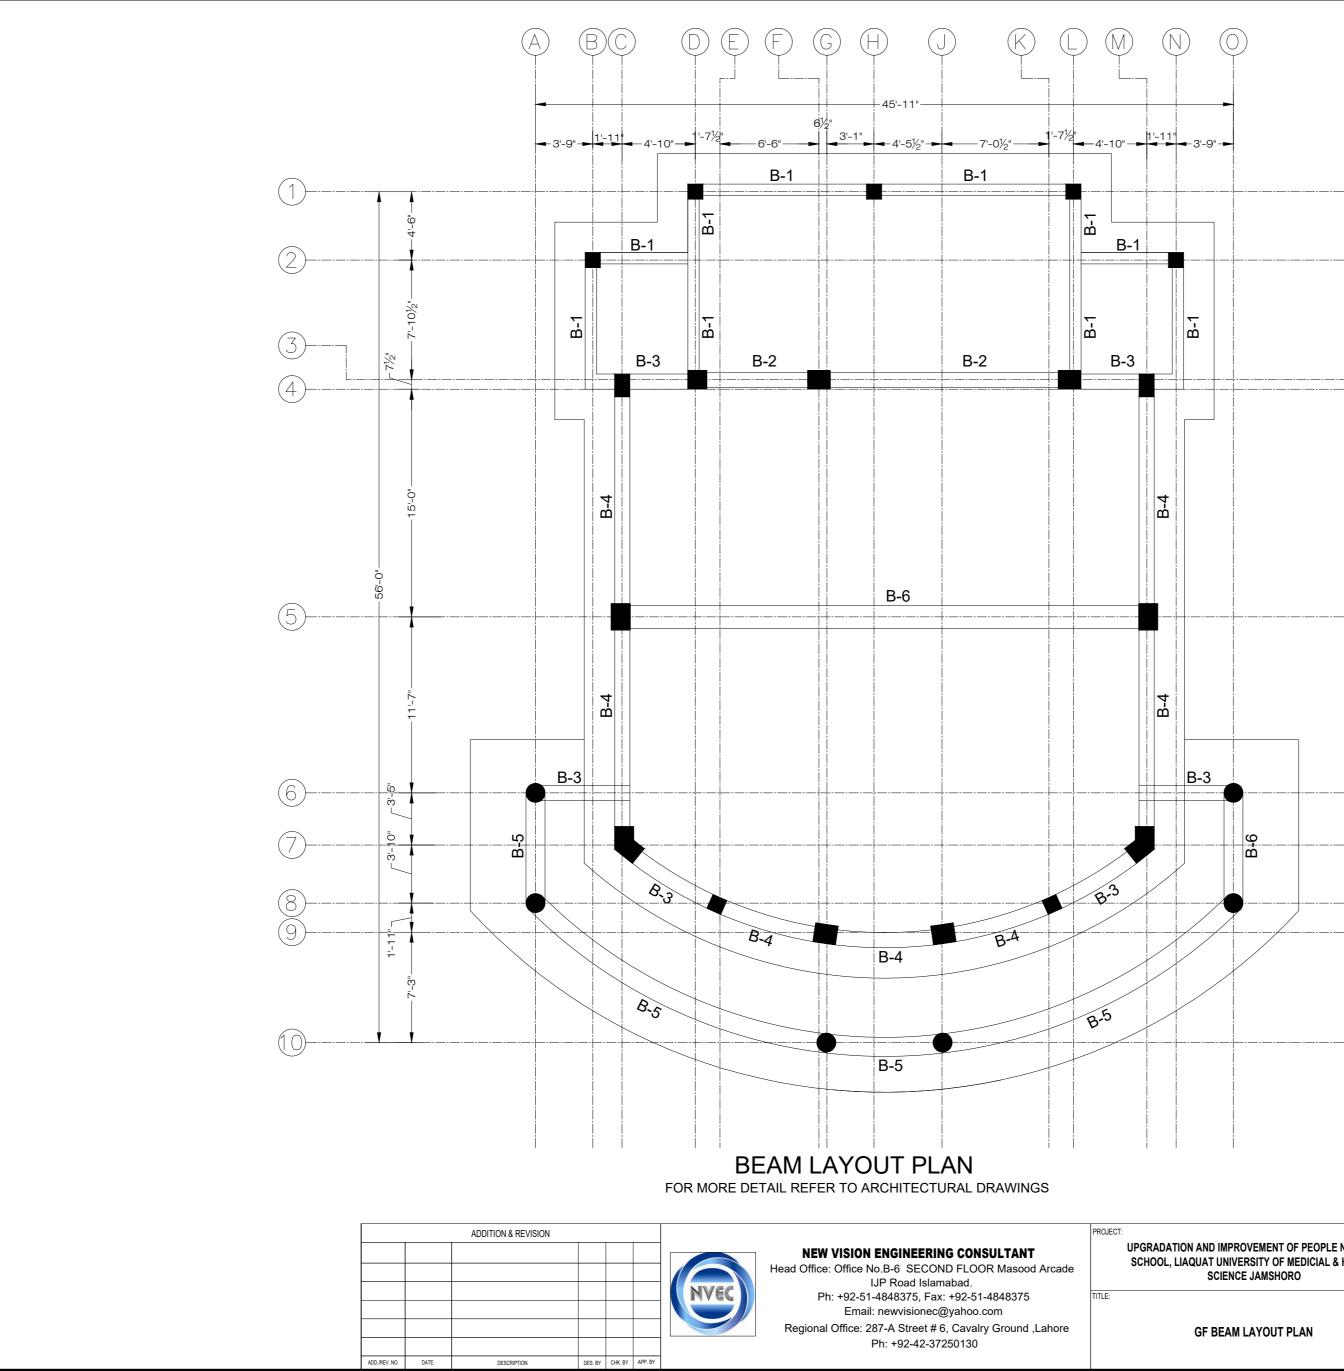

UPGRADATION AND IMPROVEMENT OF PEOPLE NURSING SCHOOL, LIAQUAT UNIVERSITY OF MEDICIAL & HEALTH

CLIENT: LIAQUAT UNIVERSITY OF MEDICIAL & HEALTH SCIENCE JAMSHORO				
 DESIGNED BY: ENG.ZAIN ARSHAD	APPROVED BY:	DATE :	MARCH, 2024	
DRAWN BY: MATHEW SIMON	JOB NO.	SCALE:	N.T.S	
DRG. NO.	ST-16			

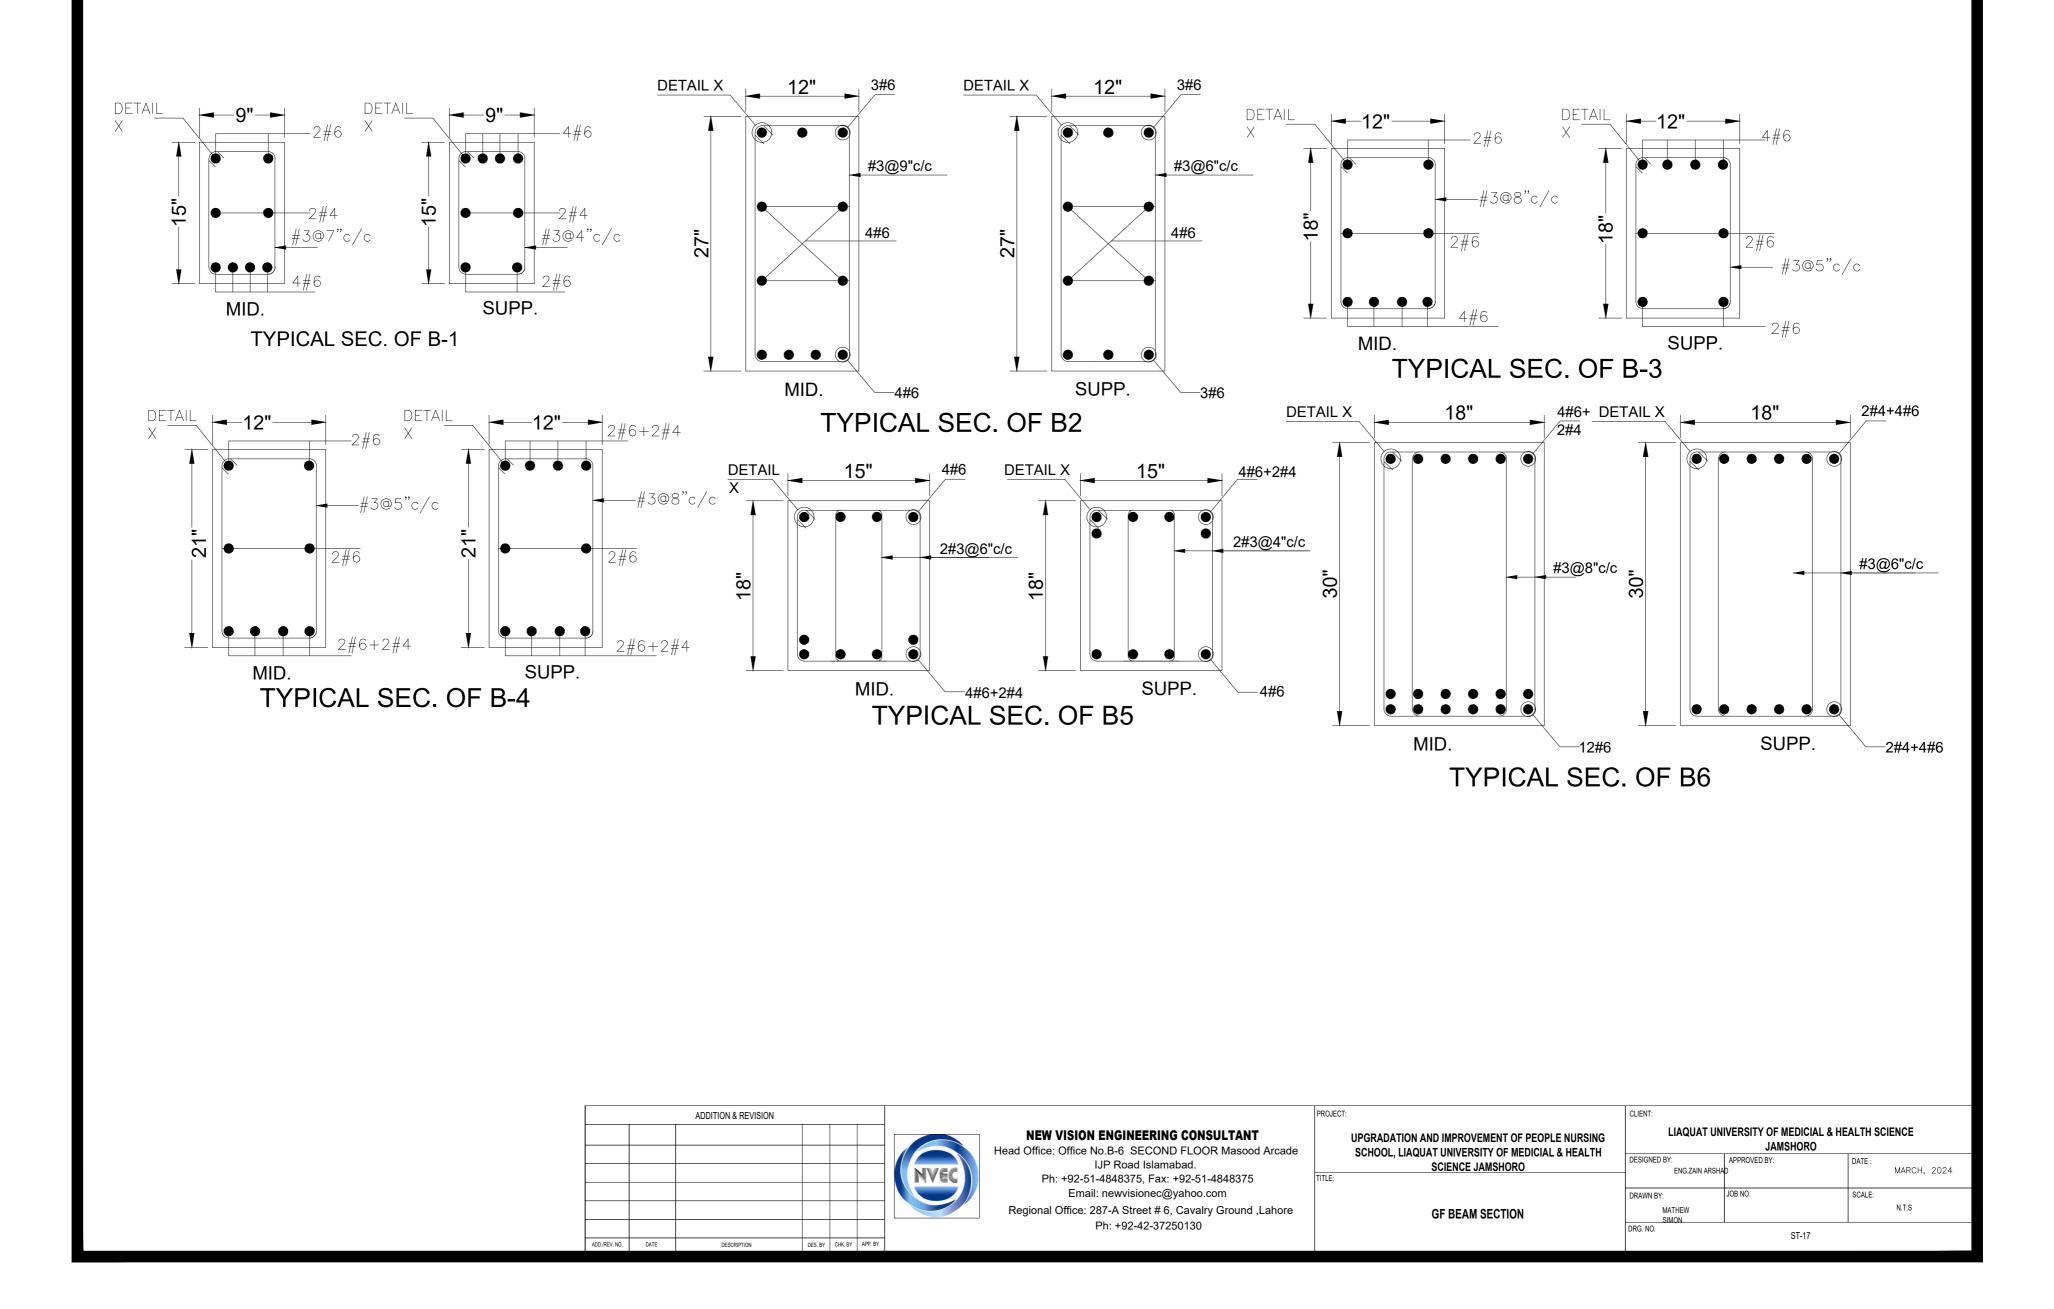


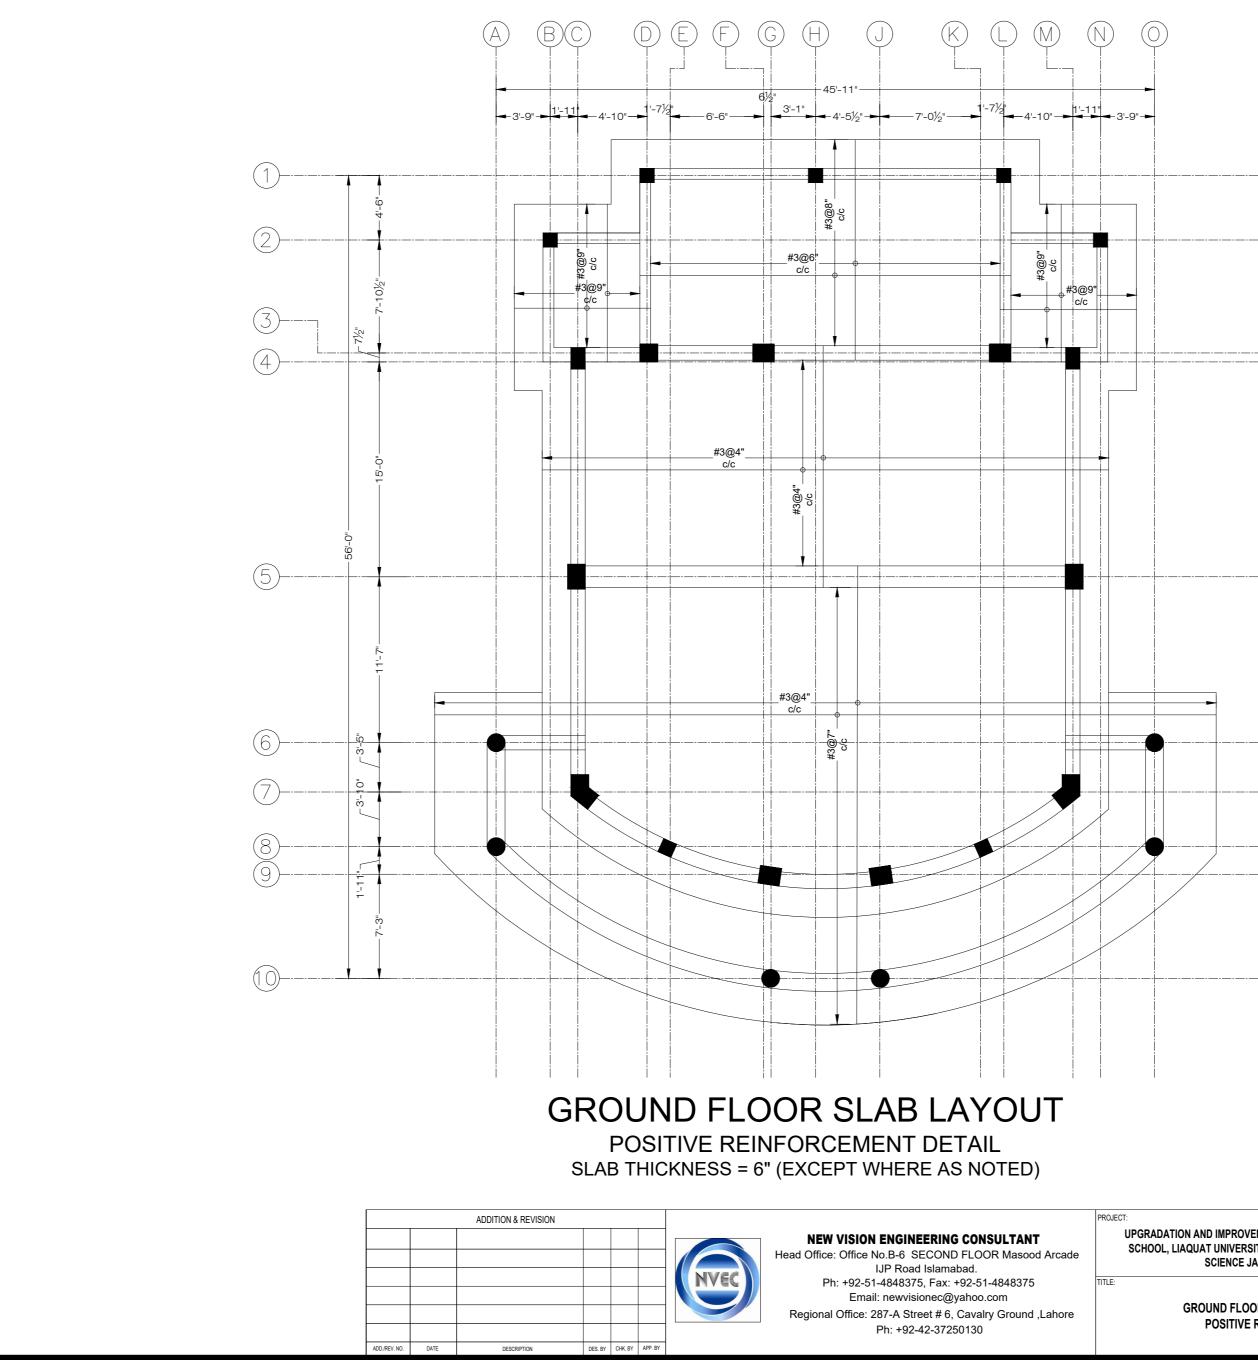

UPGRADATION AND IMPROVEMENT OF PEOPLE NURSING SCHOOL, LIAQUAT UNIVERSITY OF MEDICIAL & HEALTH SCIENCE JAMSHORO

> GROUND FLOOR SLAB LAYOUT POSITIVE REINF. PLAN


CLIENT:												
LIAQUAT UNIVERSITY OF MEDICIAL & HEALTH SCIENCE												
	JAMSHORO											
DESIGNED BY: ENG.ZAIN ARSHAD	APPROVED BY:	DATE :	MARCH. 2024									
ENG.ZAIN ARSHAD			MANGH, 2024									
DRAWN BY:	JOB NO.	SCALE:										
MATHEW SIMON			N.T.S									
DRG. NO.	ST-18											

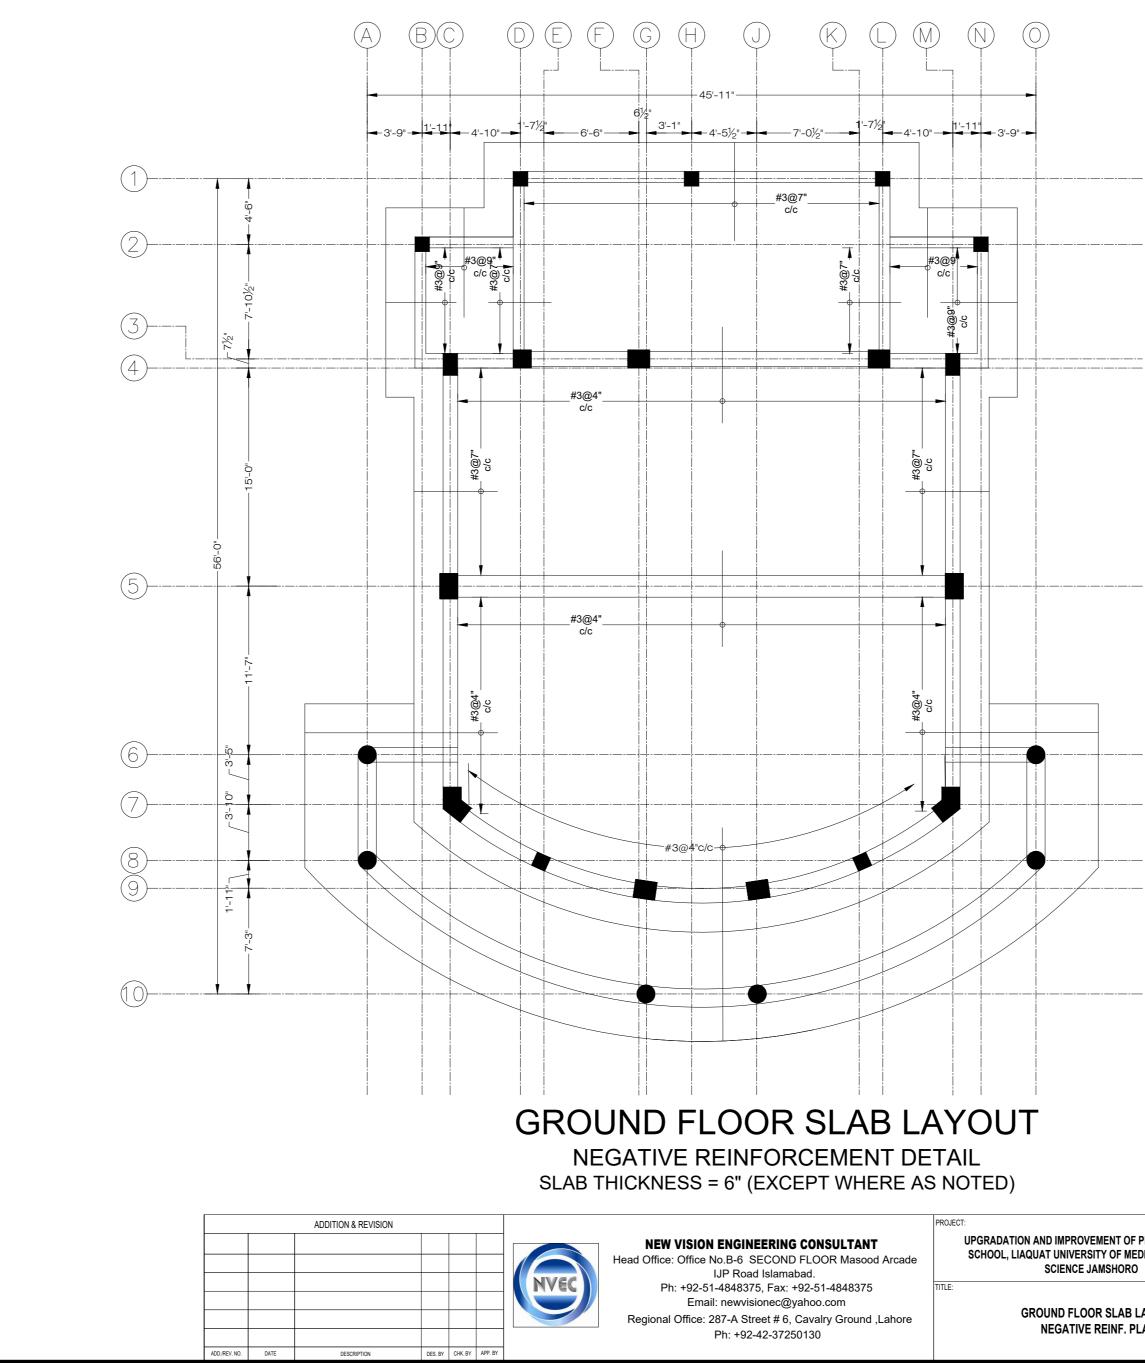


UPGRADATION AND IMPROVEMENT OF PEOPLE NURSING SCHOOL, LIAQUAT UNIVERSITY OF MEDICIAL & HEALTH

> GROUND FLOOR SLAB LAYOUT NEGATIVE REINF. PLAN

CLIENT: LIAQUAT UN	IVERSITY OF MEDICIAL & HE JAMSHORO	ALTH SC	IENCE
 DESIGNED BY: ENG.ZAIN ARSHAD	APPROVED BY:	DATE :	MARCH, 2024
DRAWN BY: MATHEW SIMON	JOB NO.	SCALE:	N.T.S
DRG. NO.	ST-19		

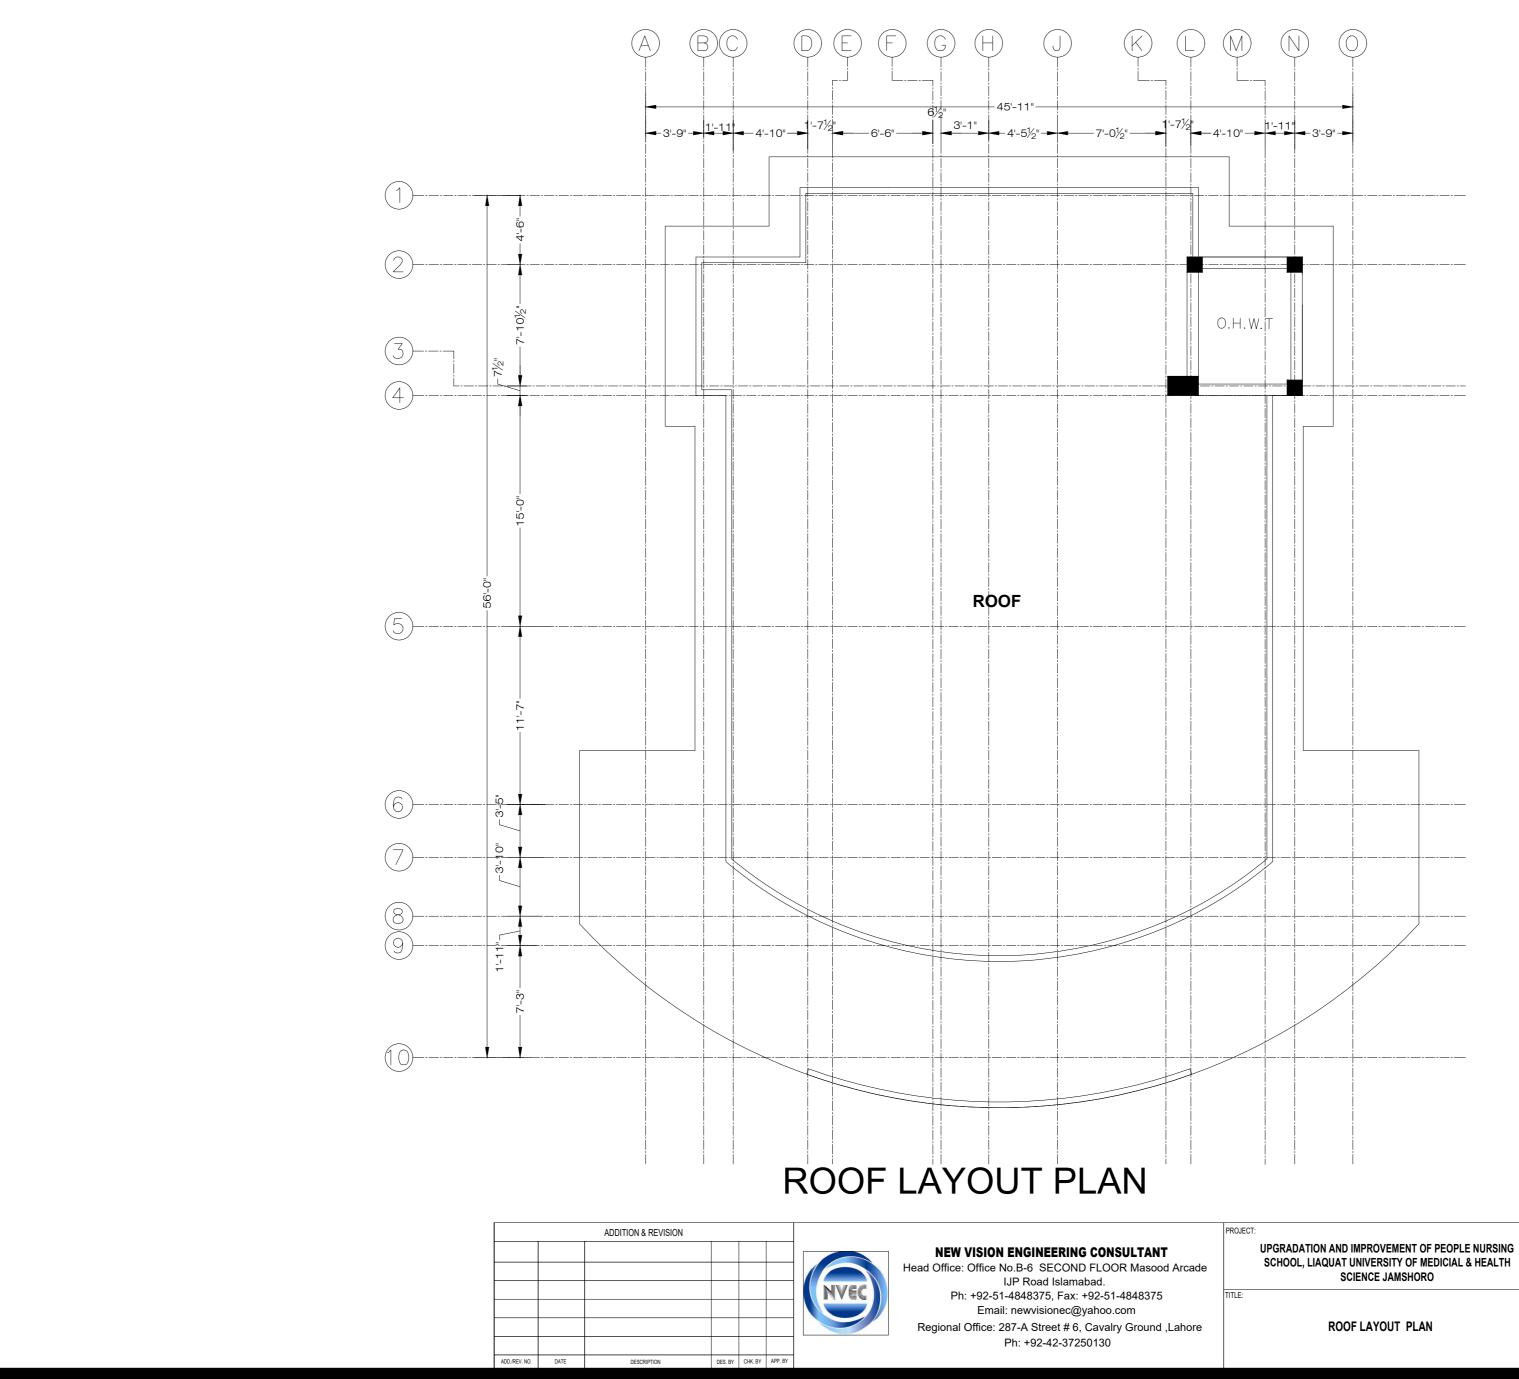

CLIENT: LIAQUAT UNIVERSITY OF MEDICIAL & HEALTH SCIENCE JAMSHORO DESIGNED BY: APPROVED BY: DATE : MARCH, 2024 ENG.ZAIN ARSHAD DRAWN BY: MATHEW SIMON JOB NO. SCALE: N.T.S DRG. NO. ST-20

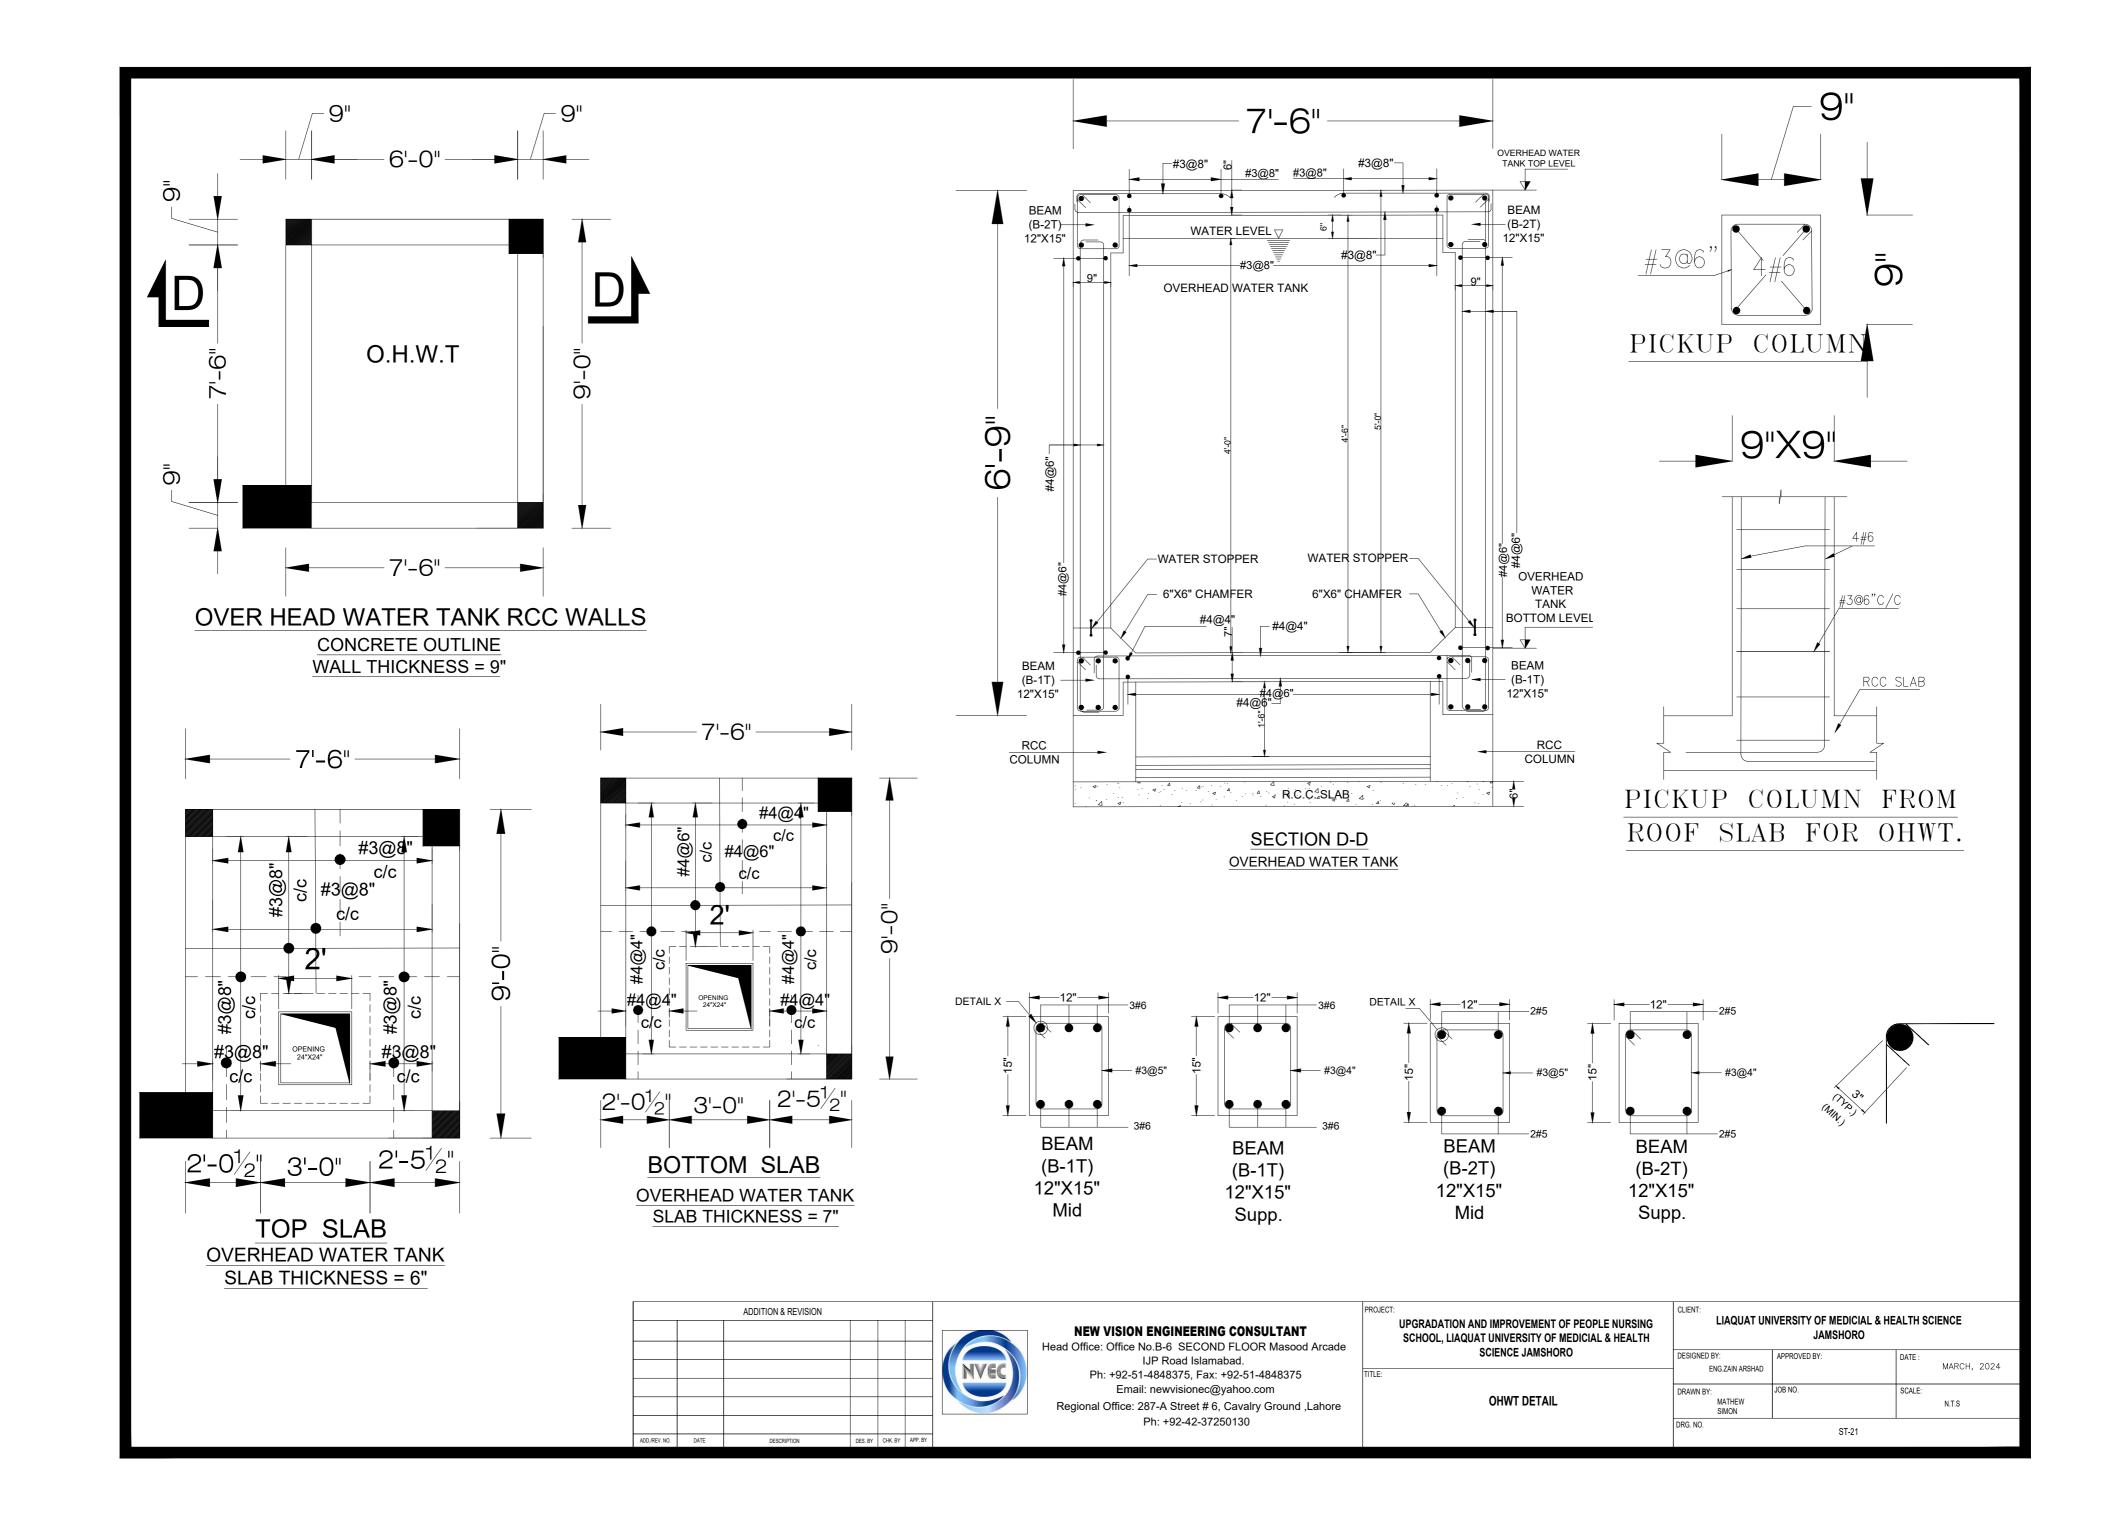



S.NO.	DRAWING TITLE	DRG. NO			
	ELECTRICAL DRAWINGS				
1	LIST OF DRAWING	EL-00			
2	GENERAL NOTES	EL-01			
3	MOUNTING HEIGHT OF FIXTURE DETAIL DETAIL	EL-02			
4	LEGEND AND SYMBOLS	EL-03			
5	EARTHING DETAIL	EL-04			
6	DISTRIBUTION BOARD DB-CAFETERIA	EL-05			
7	GROUND FLOOR LIGHTING LAYOUT	EL-06			
8	GROUND FLOOR POWER LAYOUT	EL-07			

		ADDITION & REVISION					
ADD./REV. NO	DATE	DESCRIPTION	DES. BY	CHK. BY	APP. BY	NVEC	NEW VISION EN Head Office: Office No IJI Ph: +92-51-4 Email: r Regional Office: 287 Pt

GENERAL

ELEC TRICAL SYSTEMS

ELEC TRICAL SYSTEMS

S.#

1

2

3

4

5

6

7

8

- FOLLOWING NOTES SHALL IN GENERAL APPLY TO ALL ELECTRICAL DRAWINGS. THE INSTRUCTIONS IN THESE NOTES SHALL BE FOLLOWED UNLESS STATED OTHERWISE.
- 2. THESE NOTES SHALL BE APPLICABLE TO THE ENTIRE ELECTRICAL WORKS. IF THE SITE CONDITIONS NECESSITATE ANY ALTERATIONS OR DEVIATIONS THE DIRECTIONS OF THE ENGINEER SHALL BE OBSERVED AS FINAL INSTRUCTIONS.
- 3. ALL ELECTRICAL DRAWINGS SHALL BE READ IN CONJUNCTION WITH BOQ, TECHNICAL SPECIFICATIONS, ARCHITECTURAL, STRUCTURAL, PLUMBING AND HVAC DRAWINGS & ALL OTHER RELEVANT DETAILS.
- 4. DIMENSIONS/MEASUREMENTS GIVEN IN LAYOUT AND DETAILED DRAWINGS ARE APPROXIMATE. THE CONTRACTOR SHALL BE RESPONSIBLE TO CALCULATE THE ACTUAL DIMENSIONS/ MEASUREMENTS ACCORDING TO STRUCTURAL AND ARCHITECTURAL DRAWINGS.
- THE CONTRACTOR SHALL SUBMIT SHOP DRAWINGS WITH ALL RELEVANT DETAILS TO THE ENGINEER FOR APPROVAL ACCORDING TO THE GENERAL CONDITIONS OF CONTRACT WELL IN TIME BEFORE COMMENCEMENT OF THAT WORK.
- PROPER CO-ORDINATION OF ELECTRICAL WORKS WITH OTHER SERVICES SHALL BE CARRIED OUT AT SITE.
- 7. ALL NON CURRENT CARRYING PARTS i.e. OUTER CASINGS OF EQUIPMENT SUCH AS HT & LT PANELS, DISTRIBUTIONS BOARDS, CABLE TRAYS, AUXILIARY CONSTRUCTIONS FOR EQUIPMENT ETC. SHALL BE CONNECTED TO THE GROUNDING/ EARTHING SYSTEM AT REQUIRED NUMBER OF POINTS WITH SPECIFIED SIZES OF CONDUCTORS. WATER PIPES ALONG ELECTRICAL LINE SHALL BE BONDED TO THE EARTHING SYSTEM WITH 10 sq.mm. SINGLE CORE, COPPER CONDUCTOR PVC CABLE.
- 8. ELECTRICAL POINTS FOR EQUIPMENT SHALL BE INSTALLED IN CO-ORDINATION WITH THE RELEVANT DRAWINGS OF OTHER SERVICES, SUCH AS COMMUNICATION SYSTSMS, HVAC, PLUMBING ETC. THE LOCATION ON ELECTRICAL DRAWINGS IS ONLY INDICATIVE.
- ARRANGEMENT OF ELECTRICAL EQUIPMENTS ON ELECTRICAL DRAWINGS ARE TENTATIVE. EXACT ARRANGEMENT OF EQUIPMENTS SHALL BE MADE IN VIEW OF ITS PHYSICAL DIMENSIONS AND EASE OF MAINTENANCE. AND AS PER SITE REQUIREMENTS.
- 10. LOADS ON ALL PHASES SHALL BE BALANCED AT THE TESTING/ COMMISSIONING STAGE.
- 11. CONDUIT/DUCT RUN UNDER FLOOR SHALL HAVE A MINIMUM COVER OF <u>TWO</u> INCHES FROM TOP OF CONDUIT/DUCT TO FINISH FLOOR LEVEL.

12. RUN GREEN-YELLOW OR GREEN SINGLE CORE PVC INSULATED COPPER CONDUCTOR CABLE OF SPECIFIED SIZES AS PROTECTIVE EARTH CONDUCTOR (ECC) ALL ALONG LIGHT AND POWER WIRING. WHEREVER THE SIZE IS NOT SPECIFIED THE FOLLOWING CRITERIA SHALL BE OBSERVED TO DETERMINE MINIMUM CROSS SECTIONAL AREA OF EARTH CONTINUITY CONDUCTOR (ECC) IN RELATION TO THE AREA OF ITS PHASE CONDUCTORS. RUN SEPARATE ECC FOR EACH CIRCUIT.

- ECC & PHASE CONDUCTOR OF SAME SIZE FOR UPTO AND INCLUDING 16 SQMM CABLES
- 16 SQMM ECC FOR PHASE CONDUCTOR OF 16 SQMM, 25SQMM & 35 SQMM CABLES
- FOR CABLES OF 50 SQMM AND ABOVE SIZES, ECC IS HALF SIZE OF PHASE CONDUCTOR.
- MAXIMUM SIZE OF ECC IS 70 SQMM.

		ADDITION & REVISION						PROJECT:	CLIENT:				
							IJP Road Islamabad.	UPGRADATION AND IMPROVEMENT OF PEOPLE NURSING SCHOOL, LIAQUAT UNIVERSITY OF MEDICIAL & HEALTH SCIENCE	LIAQUAT UNIVERSITY OF MEDICIAL & HEALTH SCIENCE JAMSHORO				
			<u> </u>					JAMSHORO	DESIGNED BY:	APPROVED BY:	DATE :	MARCH, 2024	
						NVEC		TITLE:	ENG.SHADAB		1 # 4101 IJ 202 I		
									DRAWN BY:	JOB NO.	SCALE:		
							Regional Office: 287-A Street # 6, Cavalry Ground ,Lahore	GENERAL NOTES	ENG.AHMAD			N.T.S	
							Ph: +92-42-37250130		DRG. NO.				
D./REV. NO.	DATE	DESCRIPTION	DES. BY	Y CHK.	BY APP. BY					EL-01			

NOTES

13. THE MAXIMUM CAPACITY OF PVC CONDUITS FOR SIMULTANEOUS DRAWING OF PVC INSULATED CABLES SHALL BE DETERMINED AS PER BS 4607. THE FOLLOWING TABLE SHALL BE USED TO DETERMINE THE MAXIMUM NUMBER OF CABLES.

NOMINAL CONDUCTOR SIZE(SQMM)	NO. & DIA OF WIRES	NOMINAL OVERALL DIA	20 MM DIA (3/4" DIA)	25 MM DIA (1" DIA)	32 MM DIA (1/ " DIA)
1.5	1/1.38	3.1	10	18	30
2.5	1/1.78	3.5	8	14	23
2.5	7/0.67	3.8	7	12	20
4	7/0.85	4.3	5	9	15
6	7/1.04	4.9	4	7	12
10	7/1.35	6.2	2	4	7
16	7/1.70	7.3	-	3	5
25	7/2.14	9.0	-	2	3
35	19/1.53	10.3	-	-	2

14. NORMAL & EMERGENCY CIRCUITS SHALL RUN IN SEPARATE CONDUITS.


15. ALL WIRING FOR CONTROLS SHALL BE CARRIED OUT WITH 1 CORE PVC CABLES OF SPECIFIED VOLTAGE GRADE AND SIZES.

16. THE WIRING SHALL BE CONTINUOUS LOOPING-IN TYPE AND NO JOINT IN WIRES SHALL BE ALLOWED.

17. THE WIRING SYSTEM SHALL BE CARRIED OUT ONLY AFTER THE CONDUIT SYSTEM IS COMPLETELY INSTALLED AND ALL OUTLET BOXES, ETC. ARE FIXED IN POSITION.


 MOUNTING HEIGHTS OF ELECTRICAL FITTINGS WHEN MEASURED FROM FINISHED FLOOR LEVEL (F.F.L.) TO THE BOTTOM OF FITTINGS SHALL BE AS UNDER, UNLESS OTHERWISE SHOWN OR INSTRUCTED.


MAIN SWITCH BOARD	48 INCHES
DISTRIBUTION BOARD	48 INCHES
CONTROL PANEL	48 INCHES
ON/OFF PUSH BUTTON STATION	48 INCHES
DIMMER CONTROL UNIT	48 INCHES
LIGHT CONTROL SWITCH (ONE WAY/TWO WAY)	48 INCHES
5A SOCKET OUTLETS IN GENERAL AREAS	10 INCHES
15A SOCKET OUTLETS IN GENERAL AREAS	10 INCHES
20A SOCKET OUTLETS IN GENERAL AREAS	10 INCHES
15A SOCKET OUTLETS IN KITCHEN (ABOVE COUNTER)	10 INCHES
CEILING FAN	96 INCHES
EXHAUST FAN	REFER ARCH. DRGS.

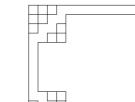

S.NO	SYMBOLS	DESCRIPT
1	1	24 WATT LED/SMD LIGHT FIXTUR
2	Ò	18 WATT LED LIGHT FIXTURE SU
3	\bigotimes	12 WATT LED LIGHT FIXTURE SU OR EQUIVALENT.
4		10 " DIA EXHAUST FAN WITH
5		48" OR 56" DIA CEILING FA
6		INDICATES GANG TYPE SWITCH INDICATES NUMBER OF SWITCHE
7		INDICATES 3 PIN COMBINED SW ON PLASTIC BACK BOX
8		INDICATES ROUND PIN 15 AMPS ON PLASTIC BACK BOX
9		20 Watt Flood Light
10	DB-XXX	DISTRIBUTION BOARD(DB-XXX) XXX-DENOTES NAME

	LIGHTING AND POWER										
BOLS	DESCRIPTION										
1)	24 WATT LED/SMD LIGHT FIXTURE OR EQUIVALENT										
Q	18 WATT LED LIGHT FIXTURE SURFACE/RECESSED MOUNTED OR EQUIVALENT.										
Ž	12 WATT LED LIGHT FIXTURE SURFACE/RECESSED MOUNTED, IP-44 RATED OR EQUIVALENT.)									
	10 " DIA EXHAUST FAN WITH PLASTIC BODY,FAN BLADES AND LOUVEF	RS									
	48" OR 56" DIA CEILING FAN										
	INDICATES GANG TYPE SWITCH 10 AMPS, INDICATES NUMBER OF SWITCHES ON SWITCH PLATE										
	INDICATES 3 PIN COMBINED SWITCH SOCKET 10–13 AMPS, ON PLASTIC BACK BOX										
	INDICATES ROUND PIN 15 AMPS SOCKET, ON PLASTIC BACK BOX										
	20 Watt Flood Light										
- X X X	DISTRIBUTION BOARD(DB-XXX) XXX-DENOTES NAME										
ADDITIO	N & REVISION N & REVISION NEW VISION ENGINEERING CONSULTANT Head Office: Office No.B-6 SECOND FLOOR Masood Arcade IJP Road Islamabad. Ph: +92-51-4848375, Fax: +92-51-4848375 Email: newvisionec@yahoo.com PROJECT: UPGRADATION AND IMPROVEMENT OF PEOPLE NURSING SCHOOL, LIAQUAT UNIVERSITY OF MEDICIAL & HEALTH SCIENCE JAMSHORO TITLE:		NIVERSITY OF MEDI SCIENCE JAMSHO APPROVED BY: JOB NO.								
D./REV. NO. DATE	Regional Office: 287-A Street # 6, Cavalry Ground ,Lahore Ph: +92-42-37250130	ENG.AHMAD DRG. NO.	EL-02	N.T.S							

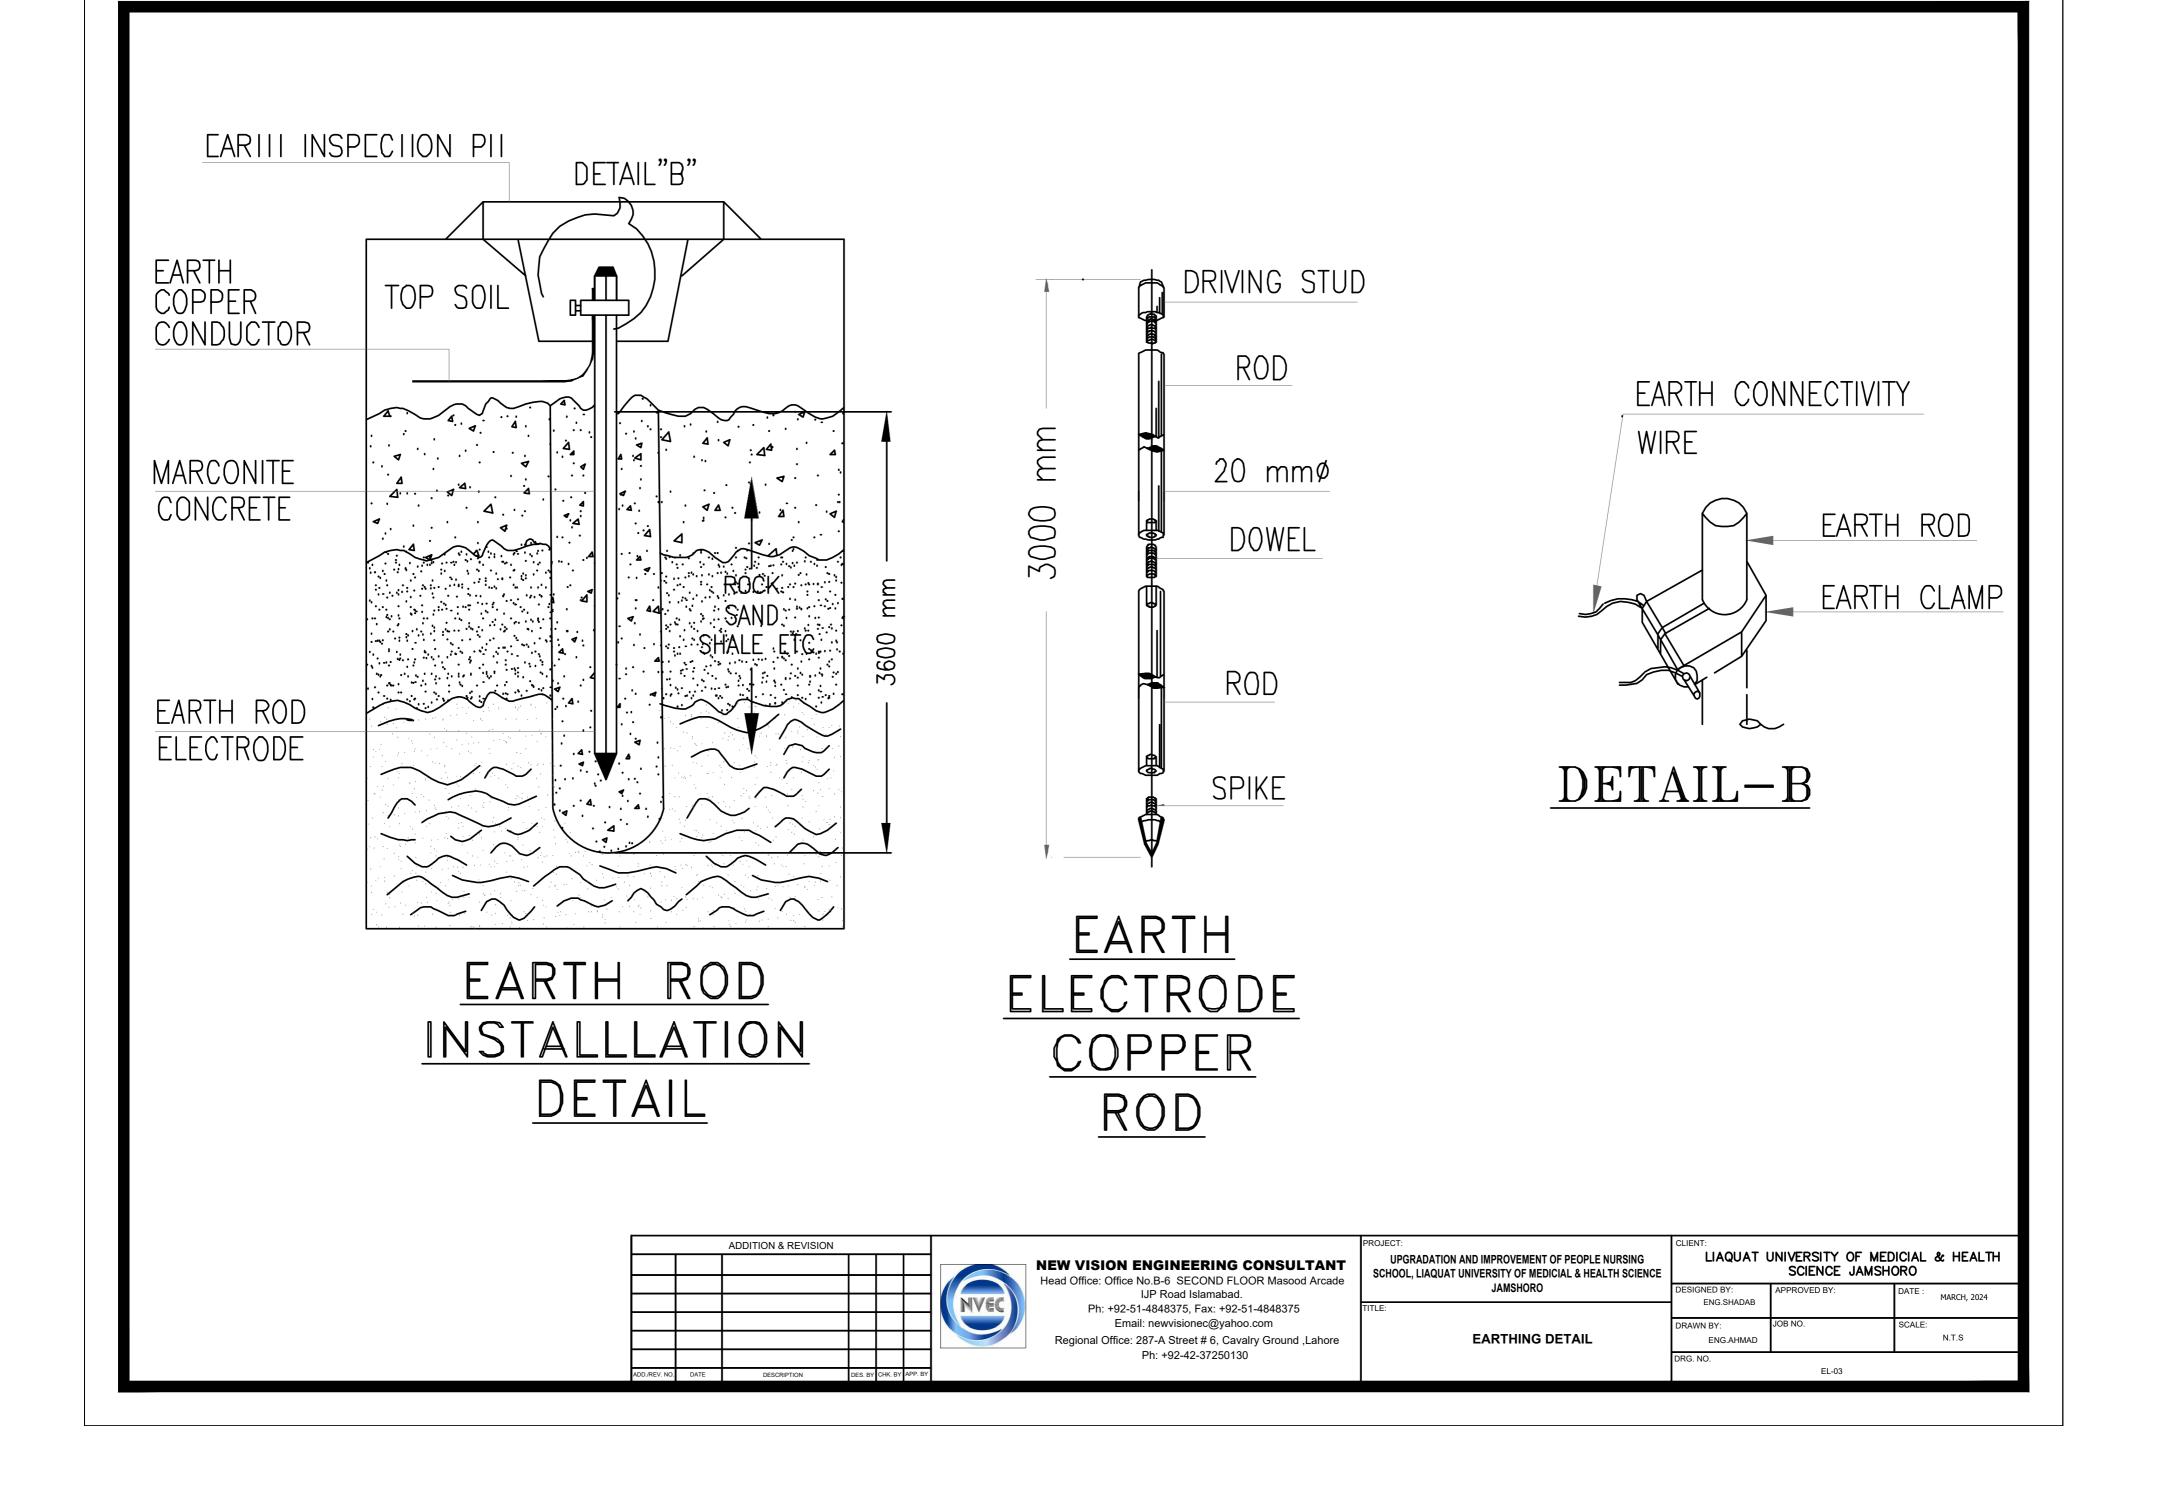


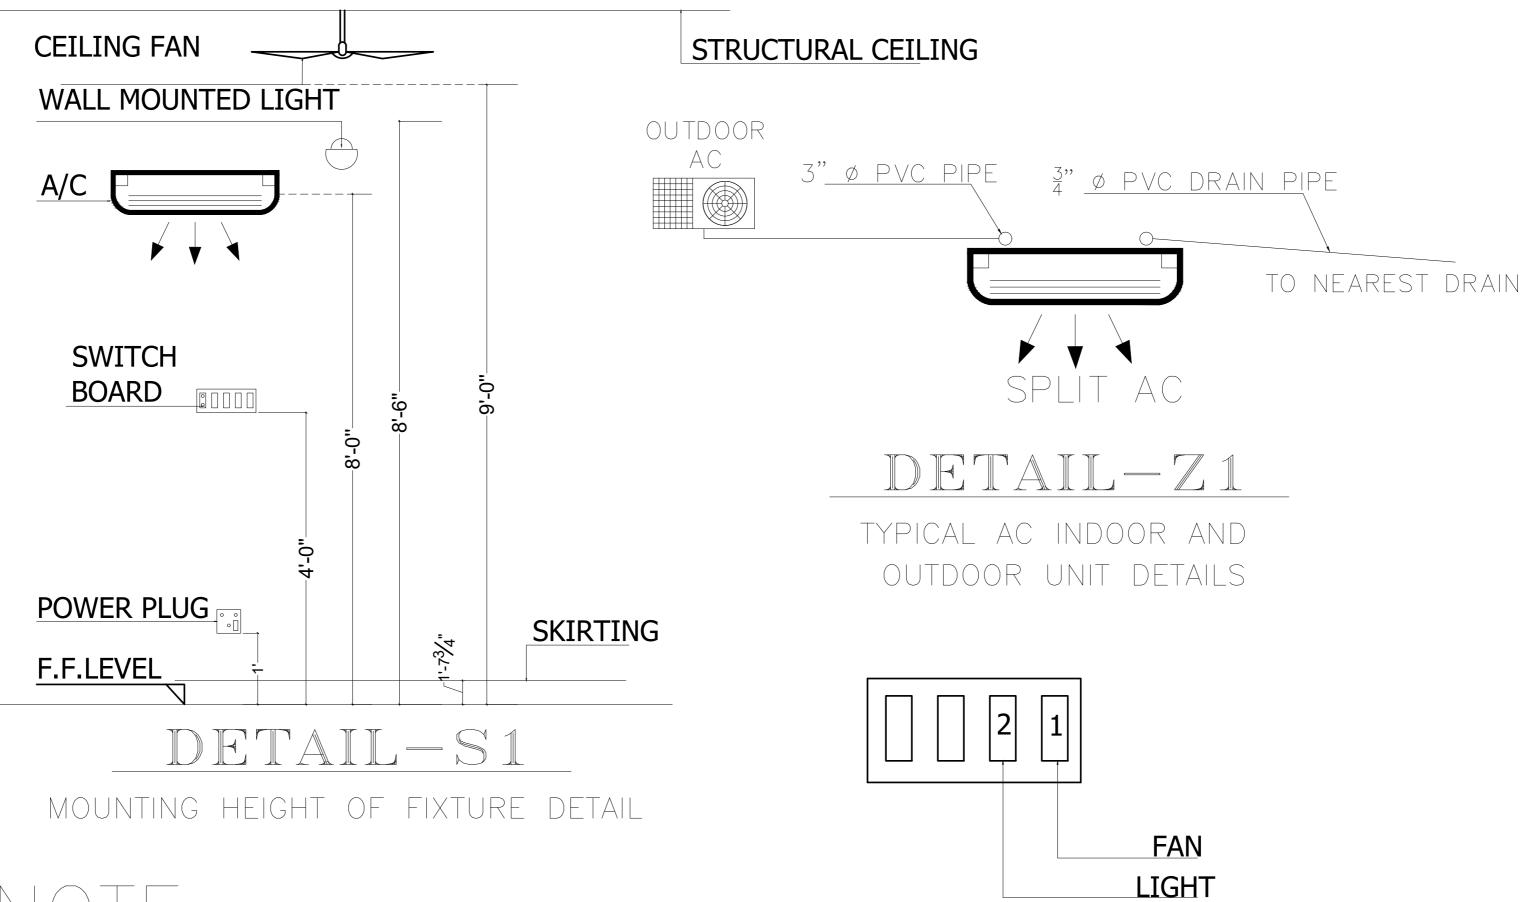



LOCATION OF ACs INDOOR, OUTDOOR UNIT AND ACs POWER SOCKETS IN APARTMENTS AREA ARE TENTATIVE SUBJECT TO FINAL FININSHING DETAIL DECIDED BY CLIENT, ARCHITECT IN CHARGE AND CONCERENED SITE ENGINEER

		ADDITION & REVISION					
						NVEC	NEW VISION ENG Head Office: Office No.B- IJP F Ph: +92-51-484 Email: nev
ADD./REV. NO.	DATE	DESCRIPTION	DES. BY	СНК. ВҮ	APP. BY		Regional Office: 287-A Ph:

PROJECT: CLIENT LIAQUAT UNIVERSITY OF MEDICIAL & HEALTH UPGRADATION AND IMPROVEMENT OF PEOPLE NURSING GINEERING CONSULTANT SCIENCE JAMSHORO SCHOOL, LIAQUAT UNIVERSITY OF MEDICIAL & HEALTH SCIENCE B-6 SECOND FLOOR Masood Arcade JAMSHORO ESIGNED BY: PROVED B Road Islamabad. MARCH, 2024 ENG.SHADAB 348375, Fax: +92-51-4848375 ewvisionec@yahoo.com RAWN BY SCALE: **TYPICAL DETAILS OF MOUNTING** N.T.S -A Street # 6, Cavalry Ground ,Lahore ENG.AHMAD +92-42-37250130 HEIGHT DRG. NO. EL-04

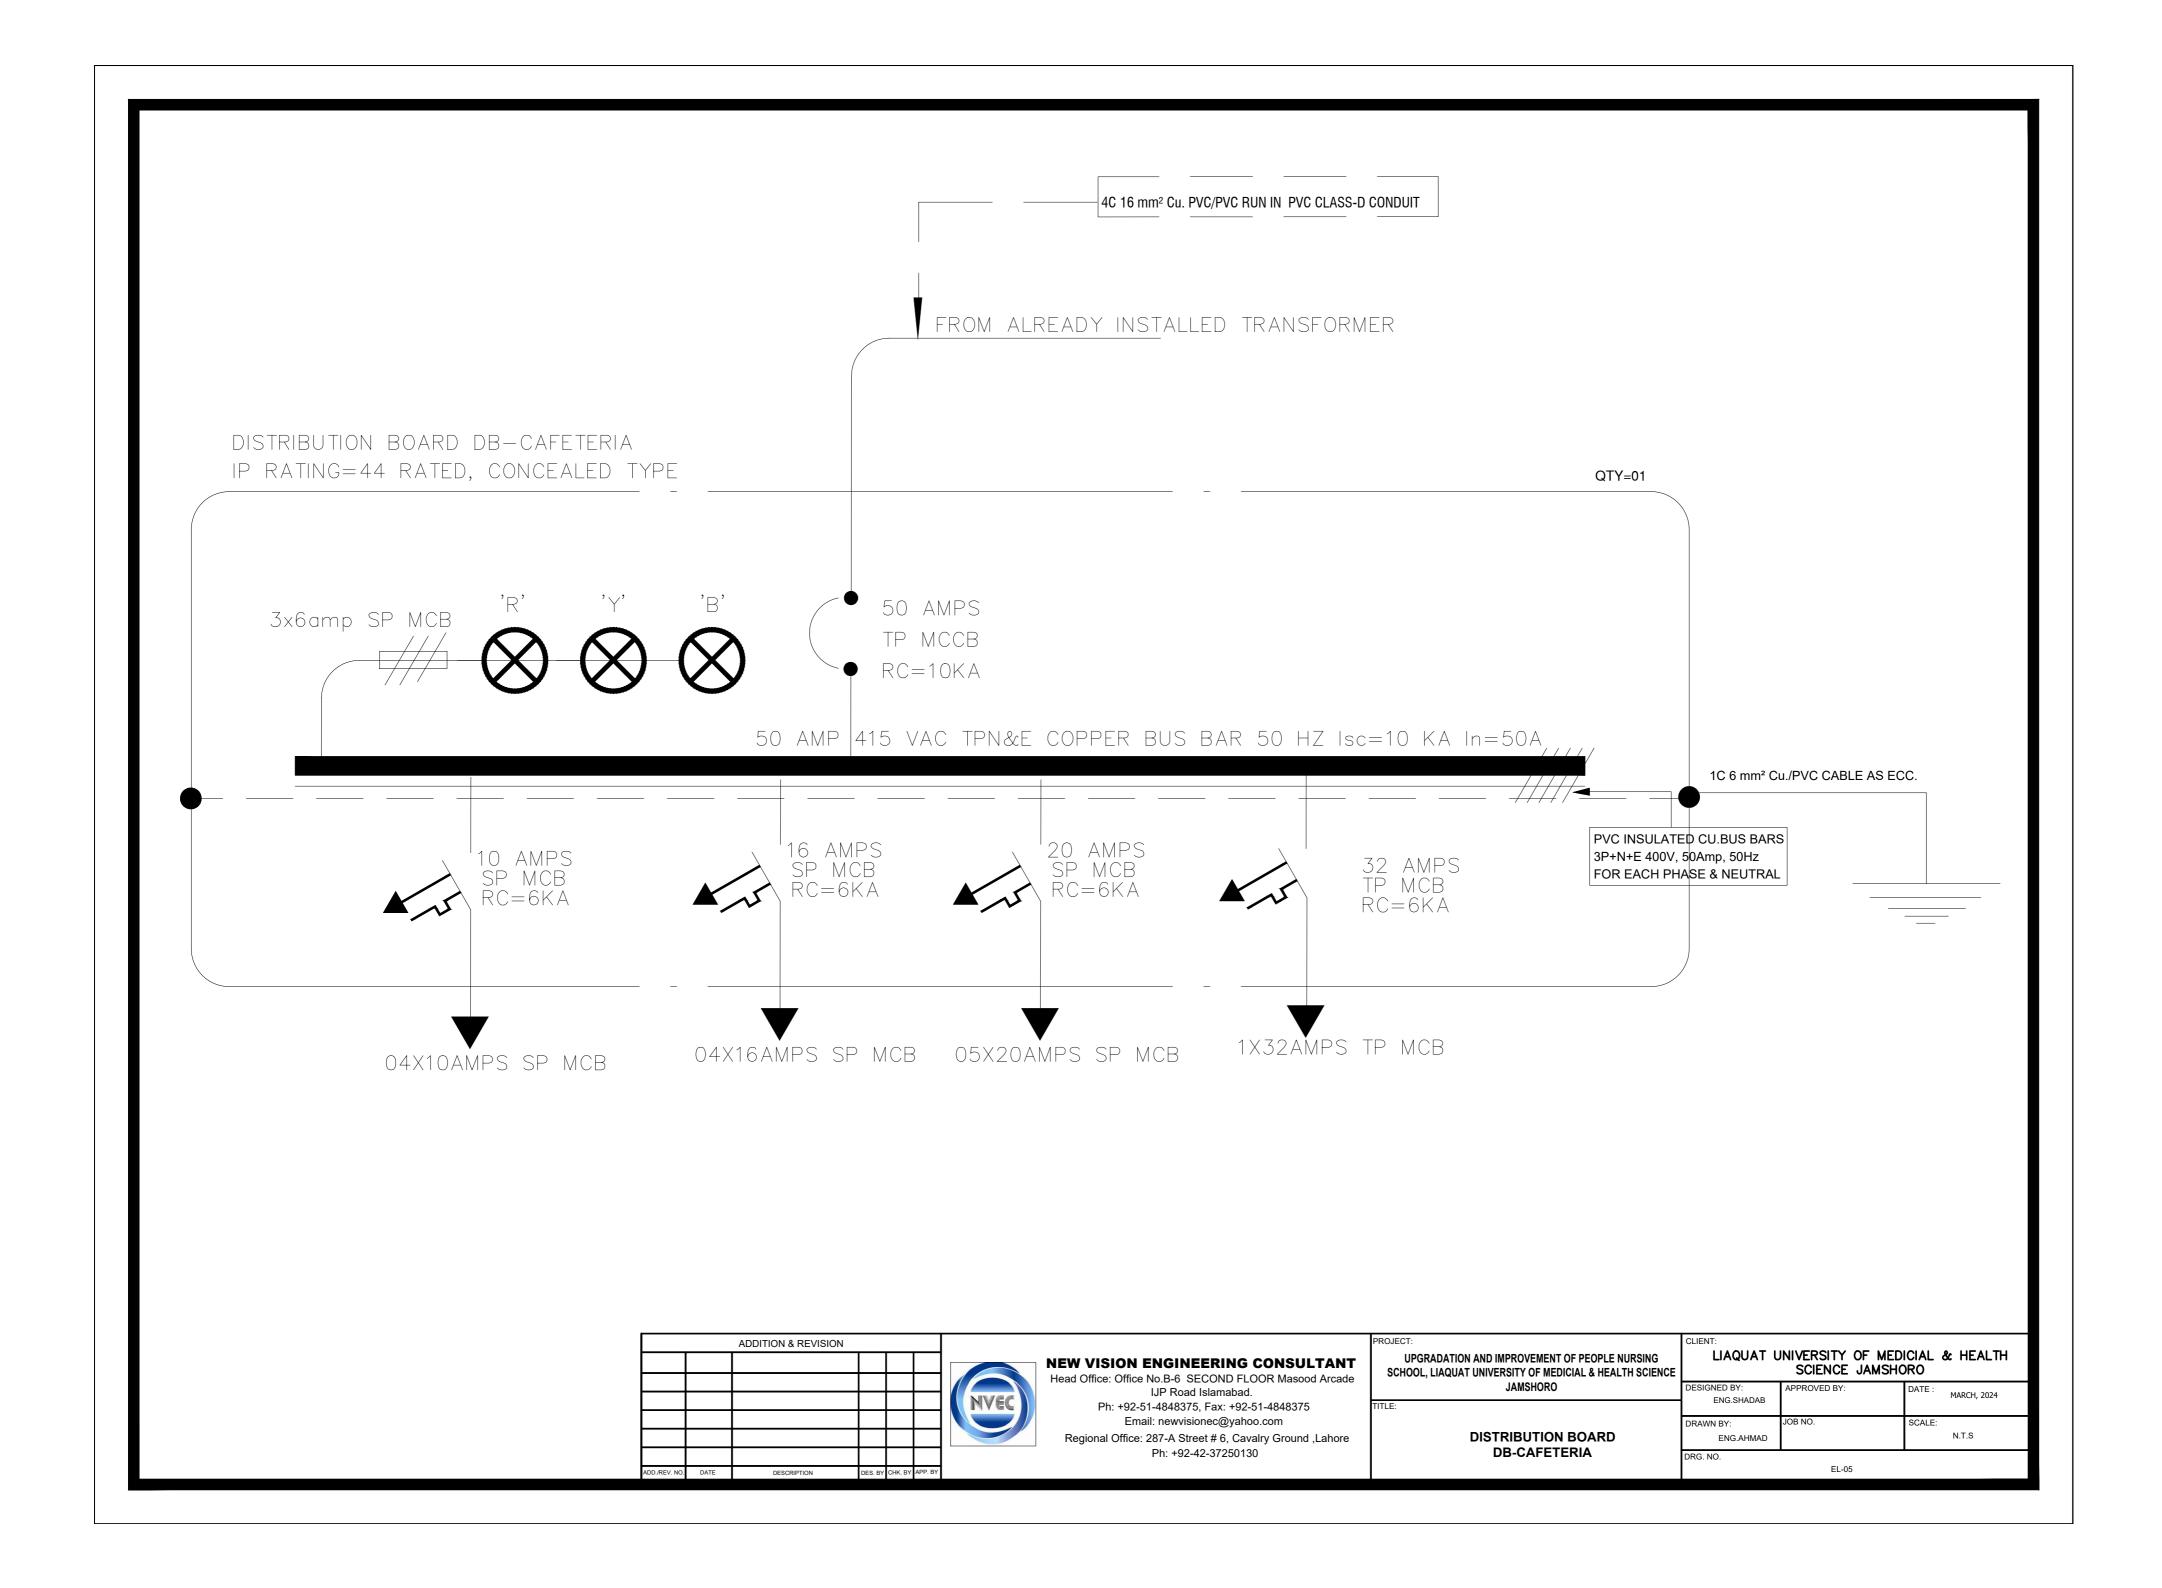

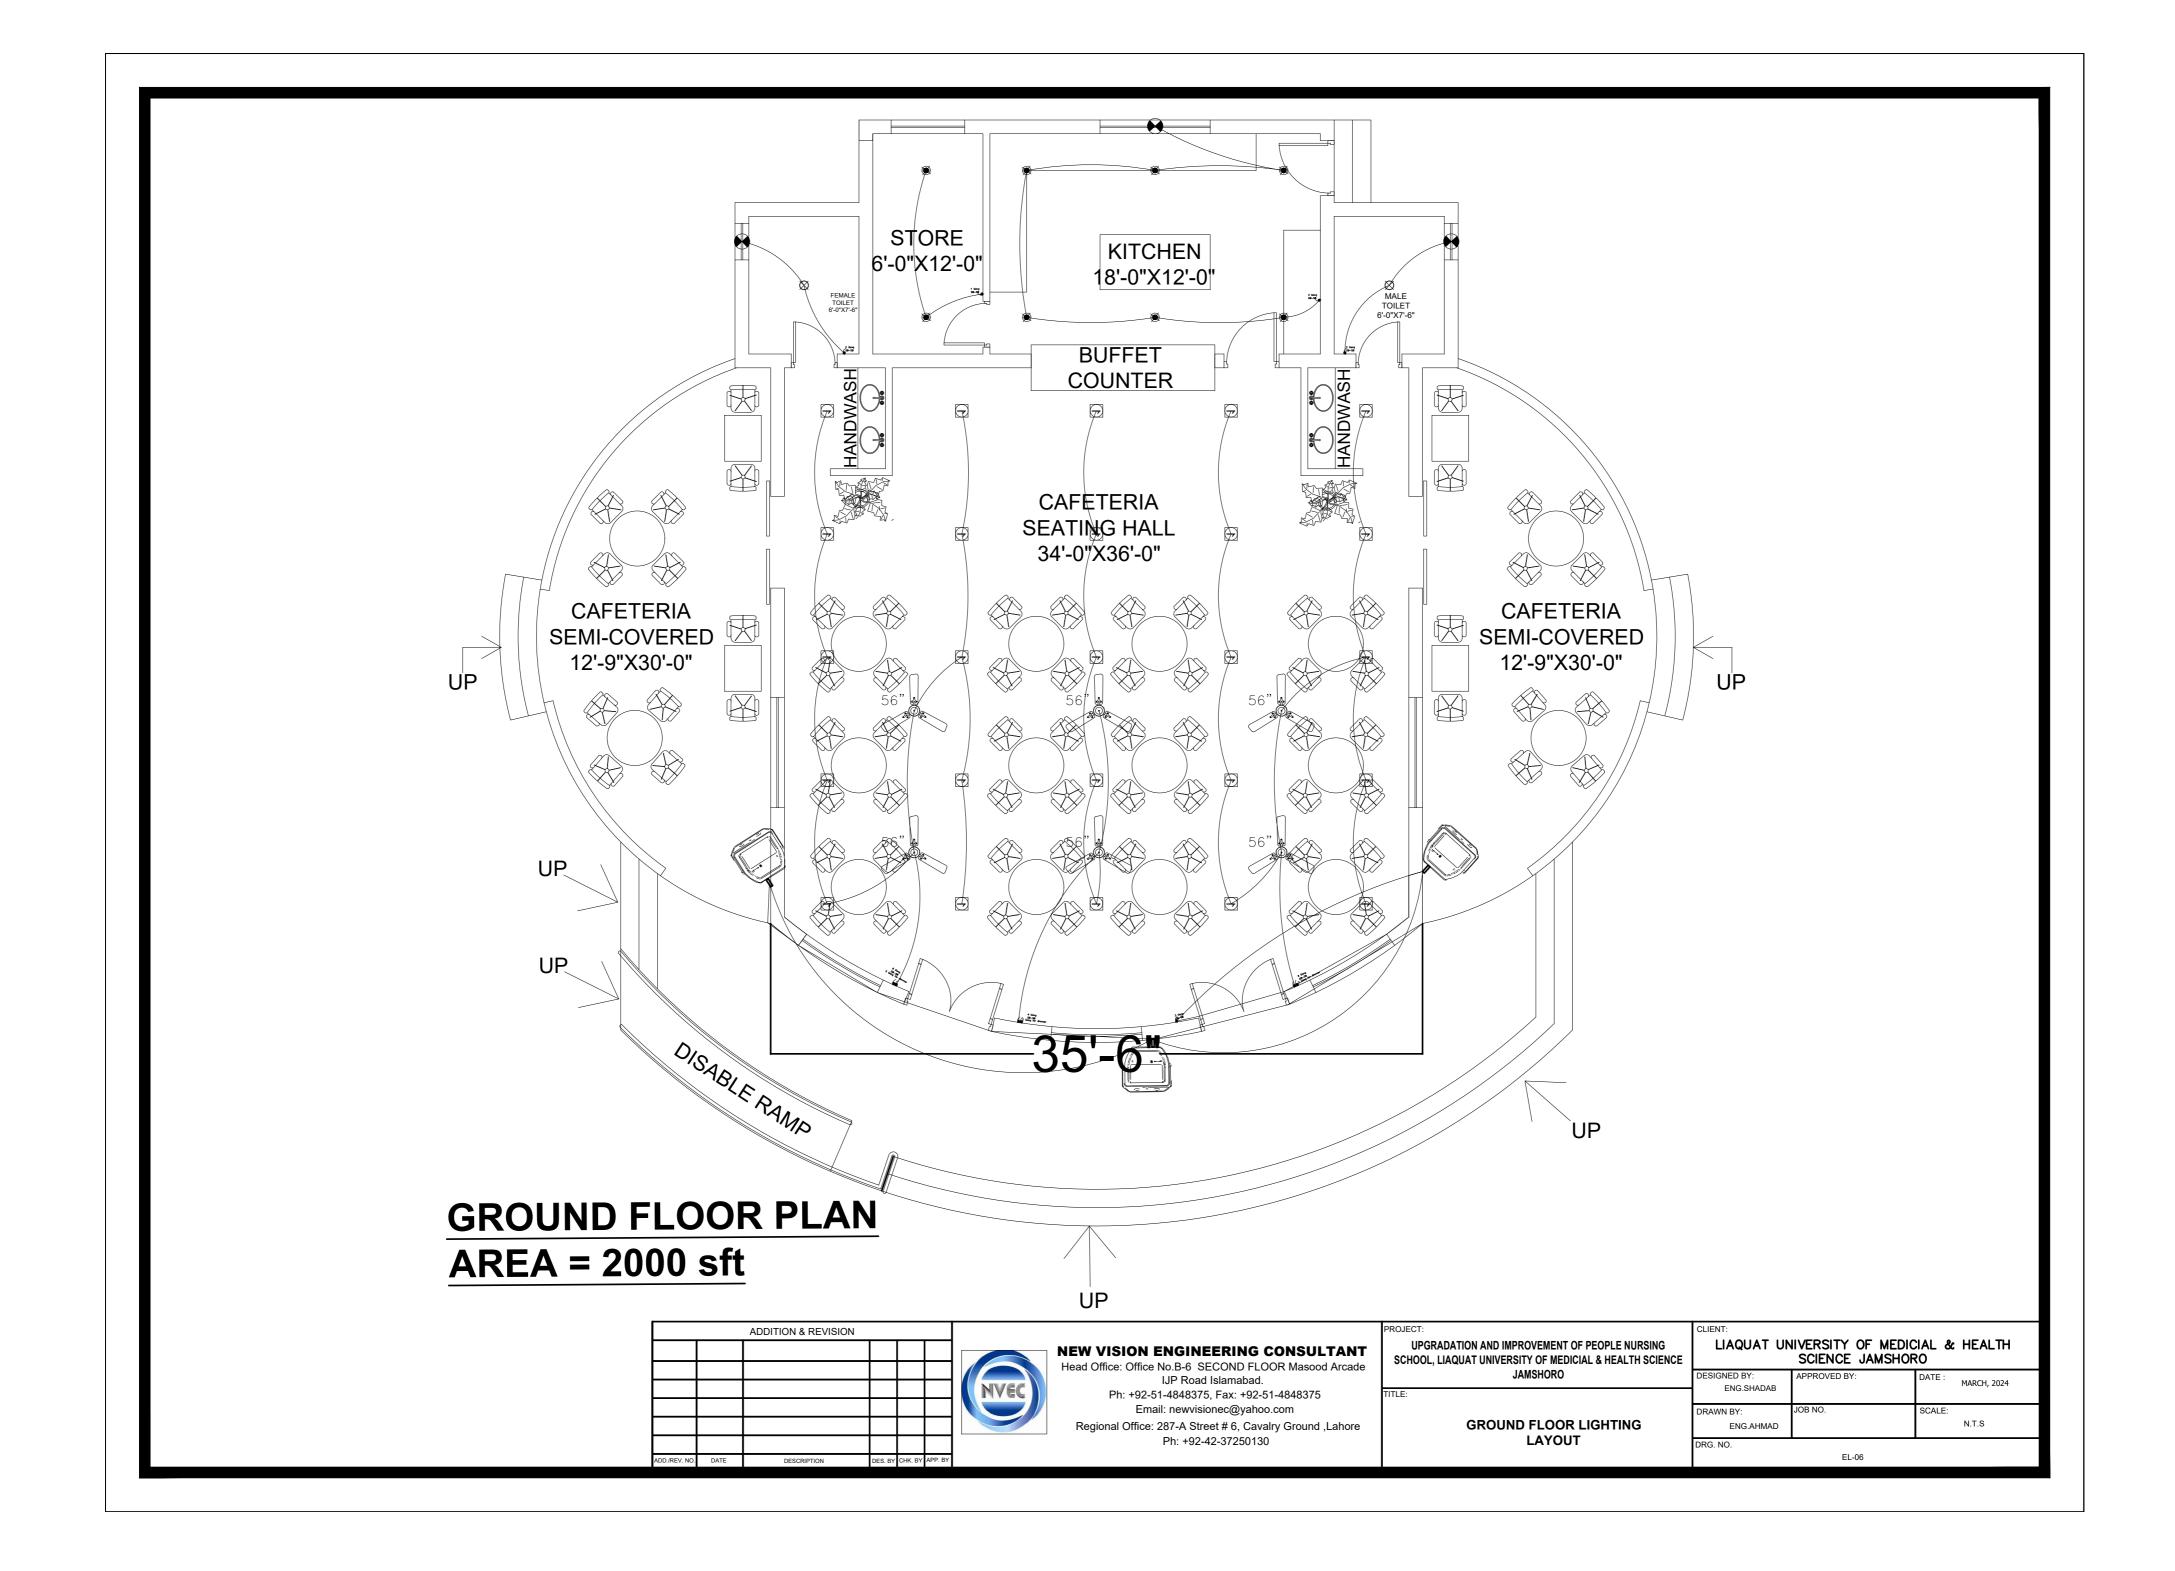

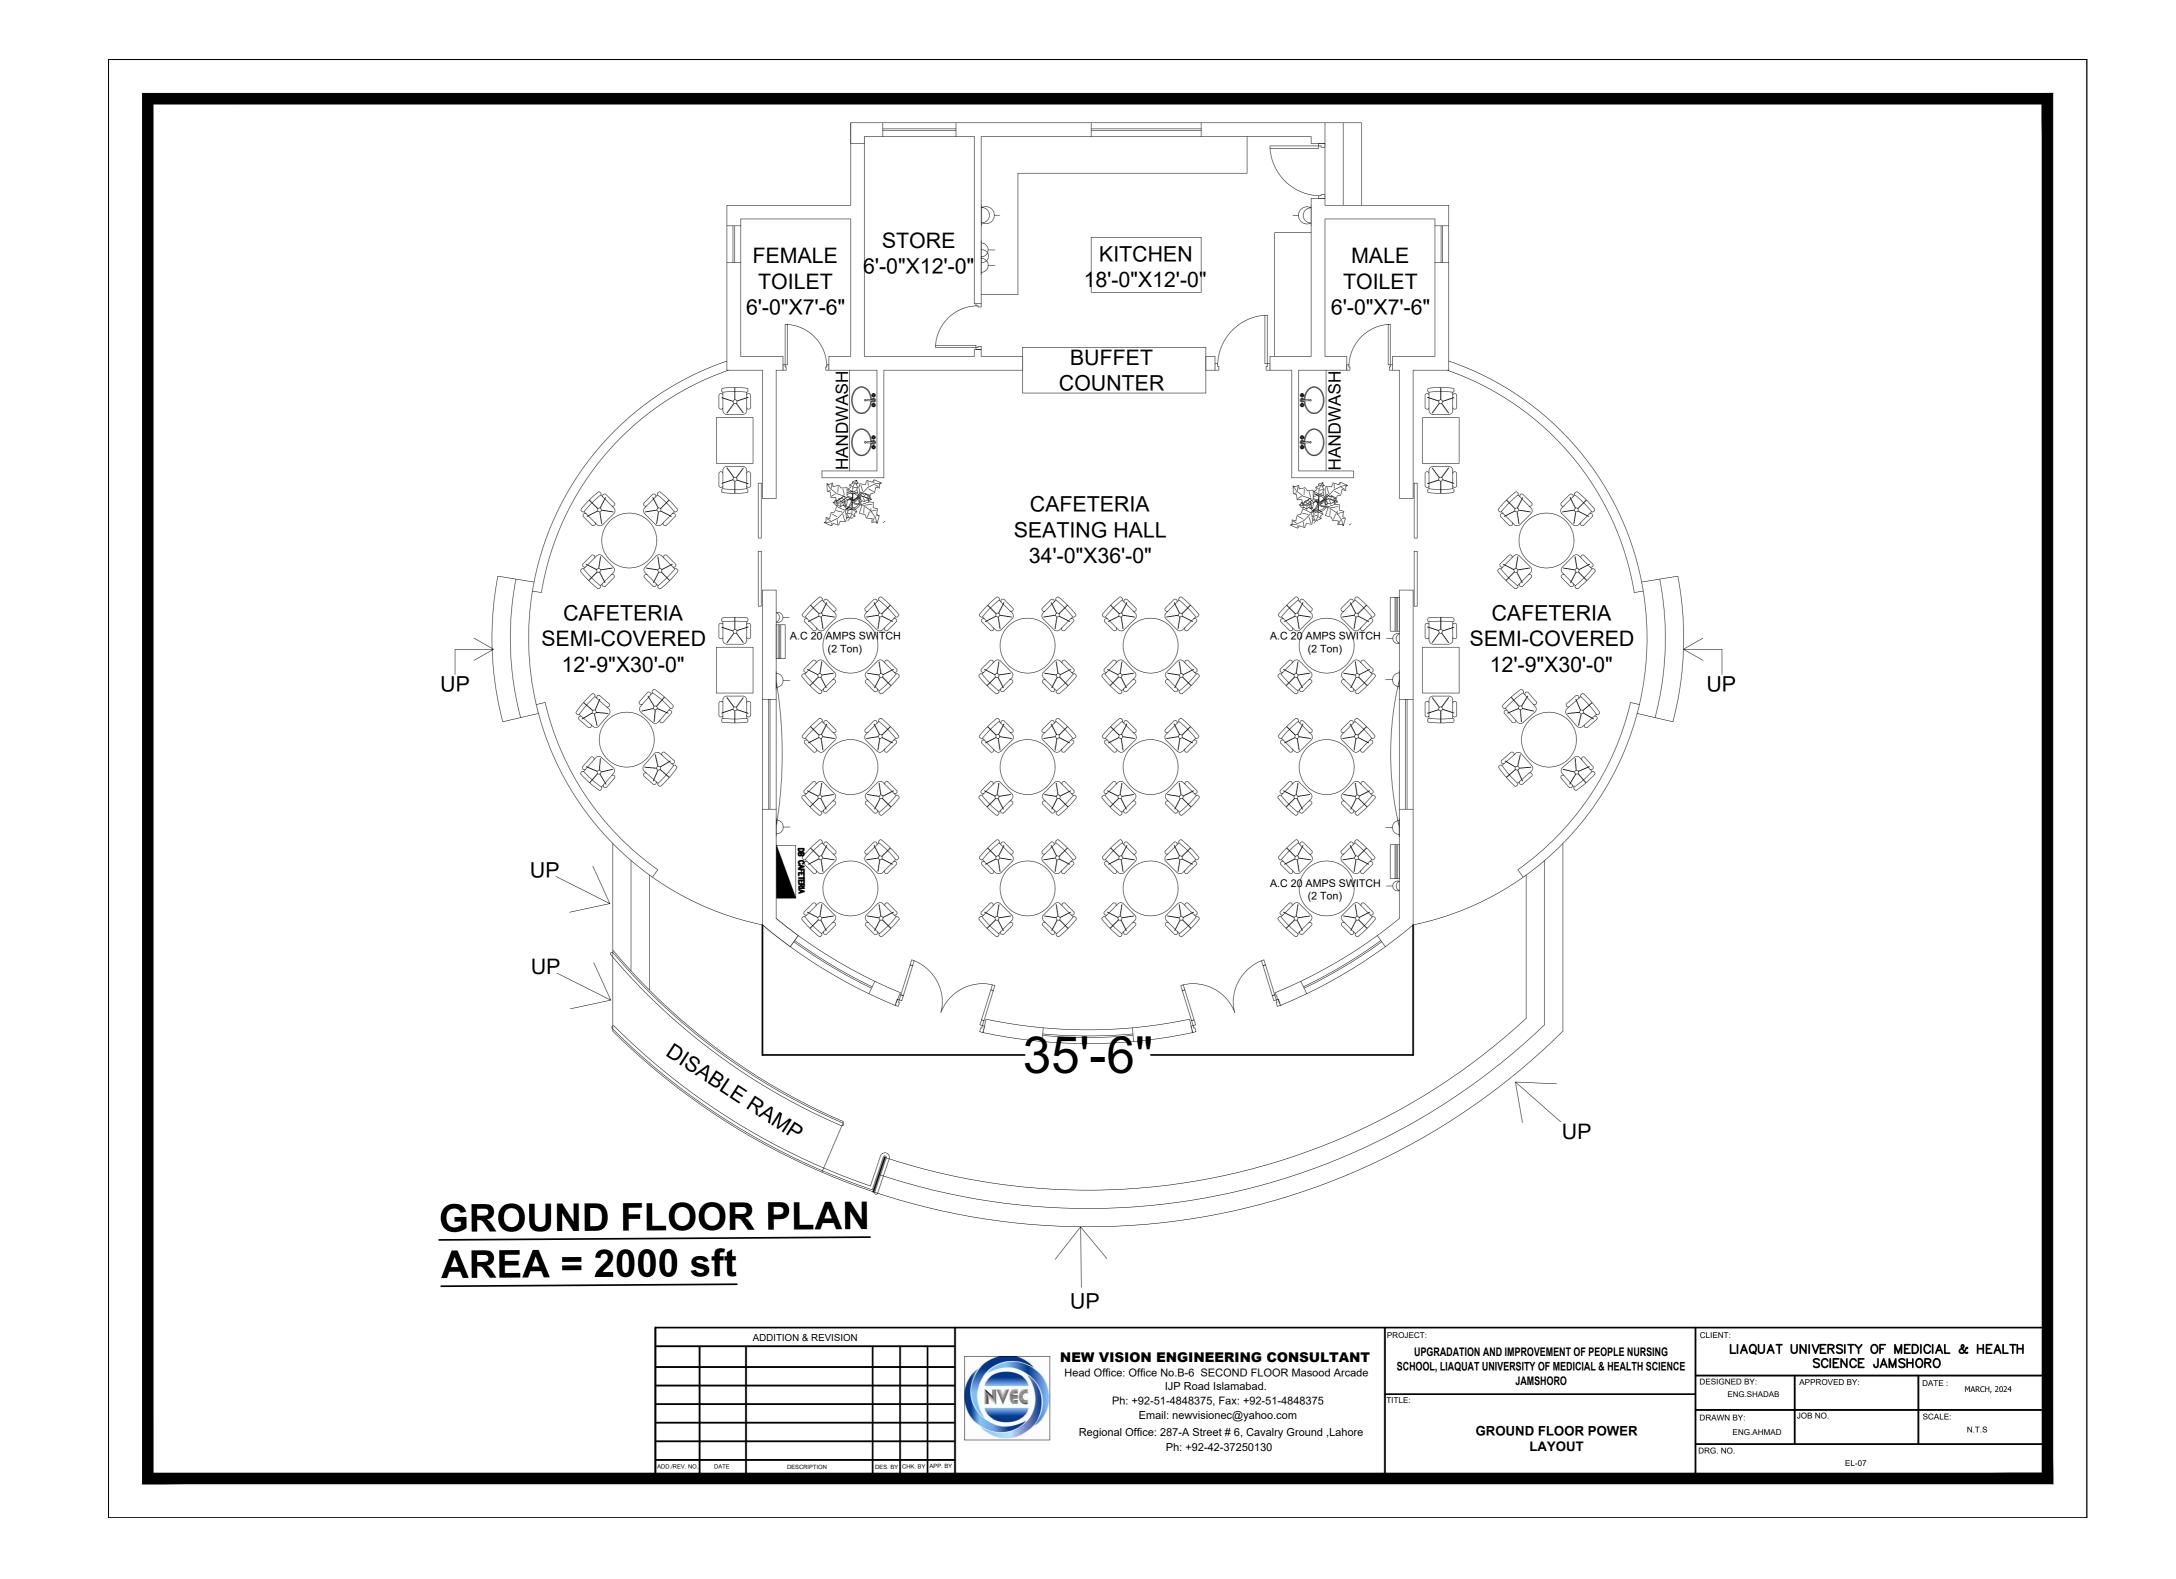

PLUMBING LUMHS CAFETERIA

LIST OF DRAWINGS									
S.NO.	DRAWING TITLE	DRG. NO							
PLUMBING DRAWINGS									
1	LIST OF DRAWING	PL-00							
2	GENERAL NOTES	PL-01							
3	GROUND FLOOR PLAN (SANITARY DRAINAGE LAYOUT)	PL-02							
4	ROOF FLOOR PLAN (STORM WATER DRAINAGE LAYOUT)	PL-03							
5	GROUND FLOOR PLAN (WATER SUPPLY LAYOUT)	PL-04							
6	ROOF PLAN (WATER SUPPLY LAYOUT)	PL-05							
7	GROUND FLOOR PLAN (GAS SUPPLY LAYOUT)	PL-06							
8	TYPICAL DETAILS	PL-07							
9	TYPICAL DETAILS	PL-08							


		ADDITION & REVISION					
						DESIGNER:	NEW VI
							Head Office:
						NVEC	Ph: +
							Regional Of
ADD./REV. NO.	DATE	DESCRIPTION	DES. BY	CHK. BY	APP. BY		


	PROJECT:	CLIENT:			
SION ENGINEERING CONSULTANT	UPGRADATION AND IMPROVEMENT OF PEOPLE NURSING SCHOOL, LIAQUAT UNIVERSITY OF	LIAQUAT UNIVERSITY OF MEDICIAL & HEALTH SCIENCE JAMSHORO			
e: Office No.B-6 SECOND FLOOR Masood Arcade	MEDICIAL & HEALTH SCIENCE JAMSHORO	DESIGNED BY:	APPROVED BY:	DATE :	
IJP Road Islamabad.	TITLE:	MATHEW		MARCH, 2024	
+92-51-4848375, Fax: +92-51-4848375 Email: newvisionec@yahoo.com)ffice: 287-A Street # 6, Cavalry Ground ,Lahore	LIST OF DRAWINGS	DRAWN BY: MATHEW SIMON	JOB NO.	SCALE: N.T.S	
Ph: +92-42-37250130		DRG. NO.	PL-00		


GENERAL NOTES.

- 1 PIPE PASSING THROUGH WALL, FLOOR OR ROOF SHALL BE PROTECTED WITH SLEEVES
- 2 PIPE SIZES & DIMENSIONS ARE IN INCHES, UNLESS OTHERWISE MENTIONED
- 3 PLUMBING SERVICES, SHALL BE CO-ORDINATED WITH OTHER SERVICES SUCH AS ELECTRICAL, ETC. TO AVOID CONFLIT OR INTERFERENCE WITH THEM.
- 4 SIZE OF FLOOR DRAIN UNLESS OTHERWISE STATED SHALL BE SAME AS THE SIZE OF OUTLET DRAIN PIPE.
- 5 WHEREVER FLOOR DRAIN/TRAP IS SHOWN, SLOPE FLOOR TOWARDS DRAIN/TRAP.
- 6 HORIZONTAL DRAINAGE PIPING OF 3 INCH DIAMETER & LESS SHALL BE INSTALLED WITH A SLOPE OF NOT LESS THEN 1/4 INCH PER FOOT, LARGER ONES WITH A SLOPE OF NOT LESS THAN 1/8 INCH PER FOOT.
- 7 EXTENSION OF VENT PIPES THROUGH A ROOF SHALL BE TERMINATED AT LEAST 6 INCHES ABOVE FINISHED ROOF LEVEL. EACH VENT TERMINAL SHALL BE MADE WATER TIGHT WITH THE ROOF BY PROPER FLASHING
- 8 SIZE OF ANYTHING GIVEN ON PLUMBING DRAWING MEANS ITS CLEAR DIMENSIONS (CAPACITY), UNLESS OTHERWISE MENTIONED.
- 9 THE "VERTICAL DISTANCE" FROM FIXTURE OUTLET TO THE TRAP WEIR SHALL PREFERABLY BE NOT MORE THAN 12 INCHES. HOWEVER, THIS "VERTICAL DISTANCE" FROM THE FIXTURE OUTLET TO THE TRAP WEIR SHALL NOT EXCEED 24 INCHES.
- 10 WHERE THE CHANGE OF DIRECTION IS 45° OR LESS, IT IS NOT NECESSARY TO PROVIDE A CLEAN OUT. BUT WHEN THE CHANGE IN DIRECTION IS MORE THAN 45°, A CLEAN OUT SHOULD BE REQUIRED.
- 11 ALL TRAPS AND FLOOR DRAINS SHALL HAVE A WATER SEAL NOT LESS THAN 2 INCHES.
- 12 (EXTERNAL SERVICES) THE BOTTOM OF WATER-SERVICES PIPE, AT ALL POINTS, SHALL BE AT LEAST 12 INCHES ABOVE THE TOP OF THE SEWER LINE AT ITS HIGHEST POINT.
- 13 NO "T" FITTING IS ALLOWED IN SANITARY DRAINAGE LAYOUT. USE ONLY "Y" FITTINGS.

ABBREV.	DESCRIPTIO
SP	SOIL PIPE
WP	WASTE PIPI
SS	SOIL STACK
WS	WASTE STA
VP	VENT PIPE
VS	VENT STAC
T/A	TO ABOVE
F/A	FROM ABO
T/B	TO BELOW
F/B	FROM BELC

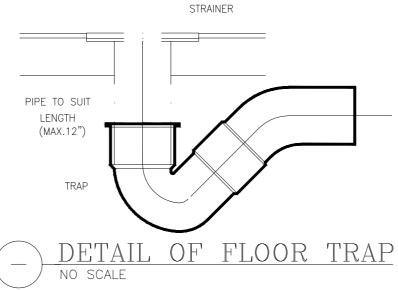

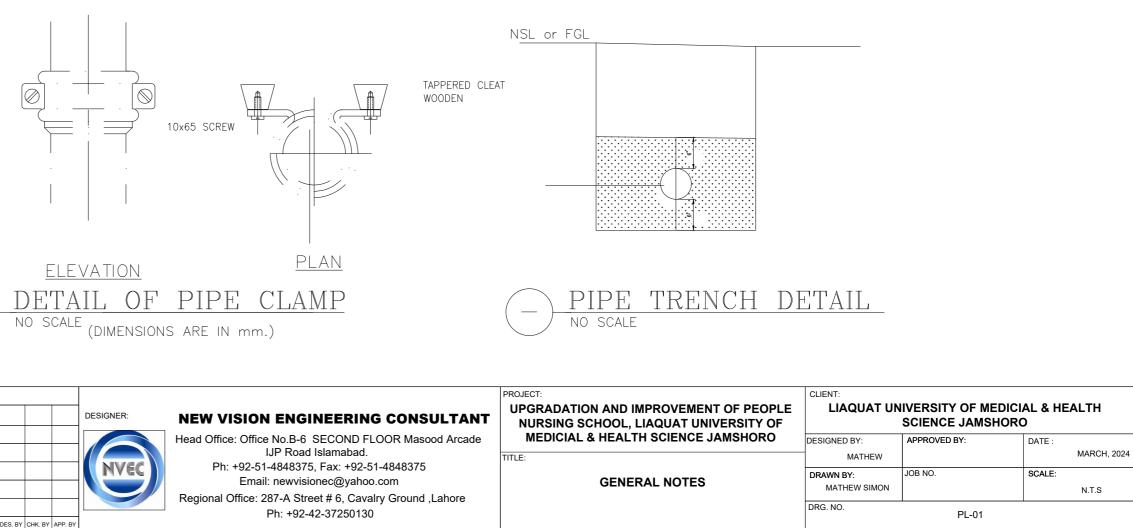

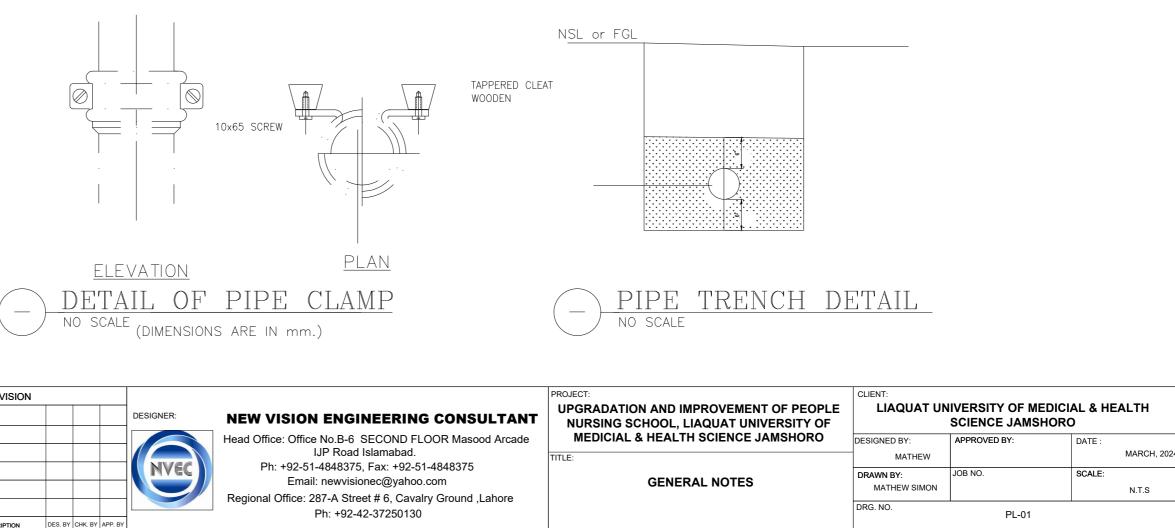


-	ADDITION & REVISION					
					DESIGNER:	NEW VIS
						Head Office:
					NVEC	Ph: +
						Regional Off
DATE	DESCRIPTION	DES BY	СНК. ВУ	APP. BY		
	DATE					DESIGNER:

TABLE-1






ABBREV.	DESCRIPTION
GV	GATE VALVE
WP	WASTE PIPE
SP	SOIL PIPE
HS	HAND SHOWER
G.T	GULLY TRAP
Gr.T	GREASE INTERCEPTOR
MATHEWT	MULTI FLOOR TRAP
FT	FLOOR TRAP
O.H.W.T	OVERHEAD WATER TANK
U.G.W.T	UNDERGROUND WATER TANK
WC	WATER CLOSD
SH	SHOWER
T/A	TO ABOVE
F/A	FROM ABOVE
T/B	TO BELOW
F/B	FROM BELOW
	·J

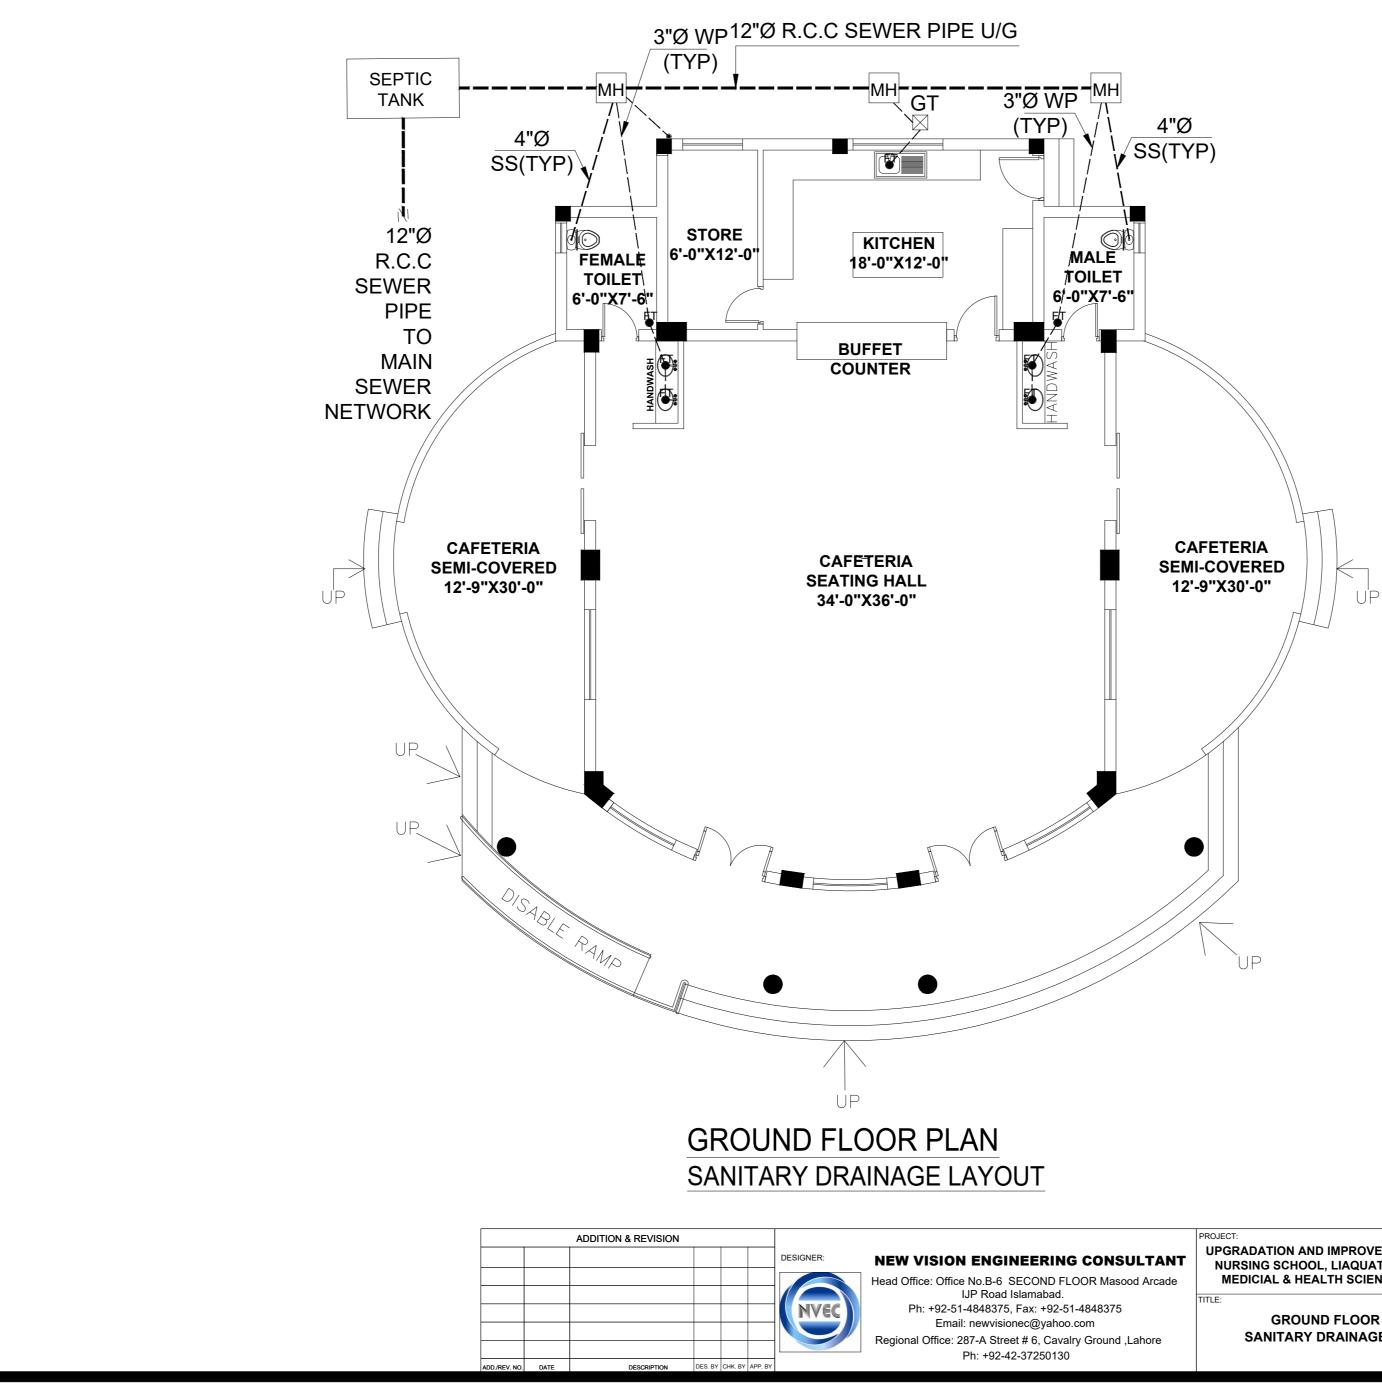



VISION ENGINEERING CONSULTANT	PROJECT: UPGRADATION AND IMPROVEMENT OF PEOPLE NURSING SCHOOL, LIAQUAT UNIVERSITY OF	CLIENT: LIAQUAT UNIVERSITY OF MEDICIAL & HEALTH SCIENCE JAMSHORO		
ffice: Office No.B-6 SECOND FLOOR Masood Arcade IJP Road Islamabad. Ph: +92-51-4848375, Fax: +92-51-4848375 Email: newvisionec@yahoo.com al Office: 287-A Street # 6, Cavalry Ground ,Lahore	MEDICIAL & HEALTH SCIENCE JAMSHORO	DESIGNED BY: MATHEW	APPROVED BY:	DATE : MARCH, 2024
	GROUND FLOOR PLAN SANITARY DRAINAGE LAYOUT	DRAWN BY: MATHEW SIMON	JOB NO.	SCALE: N.T.S
Ph: +92-42-37250130		DRG. NO.	PL-02	

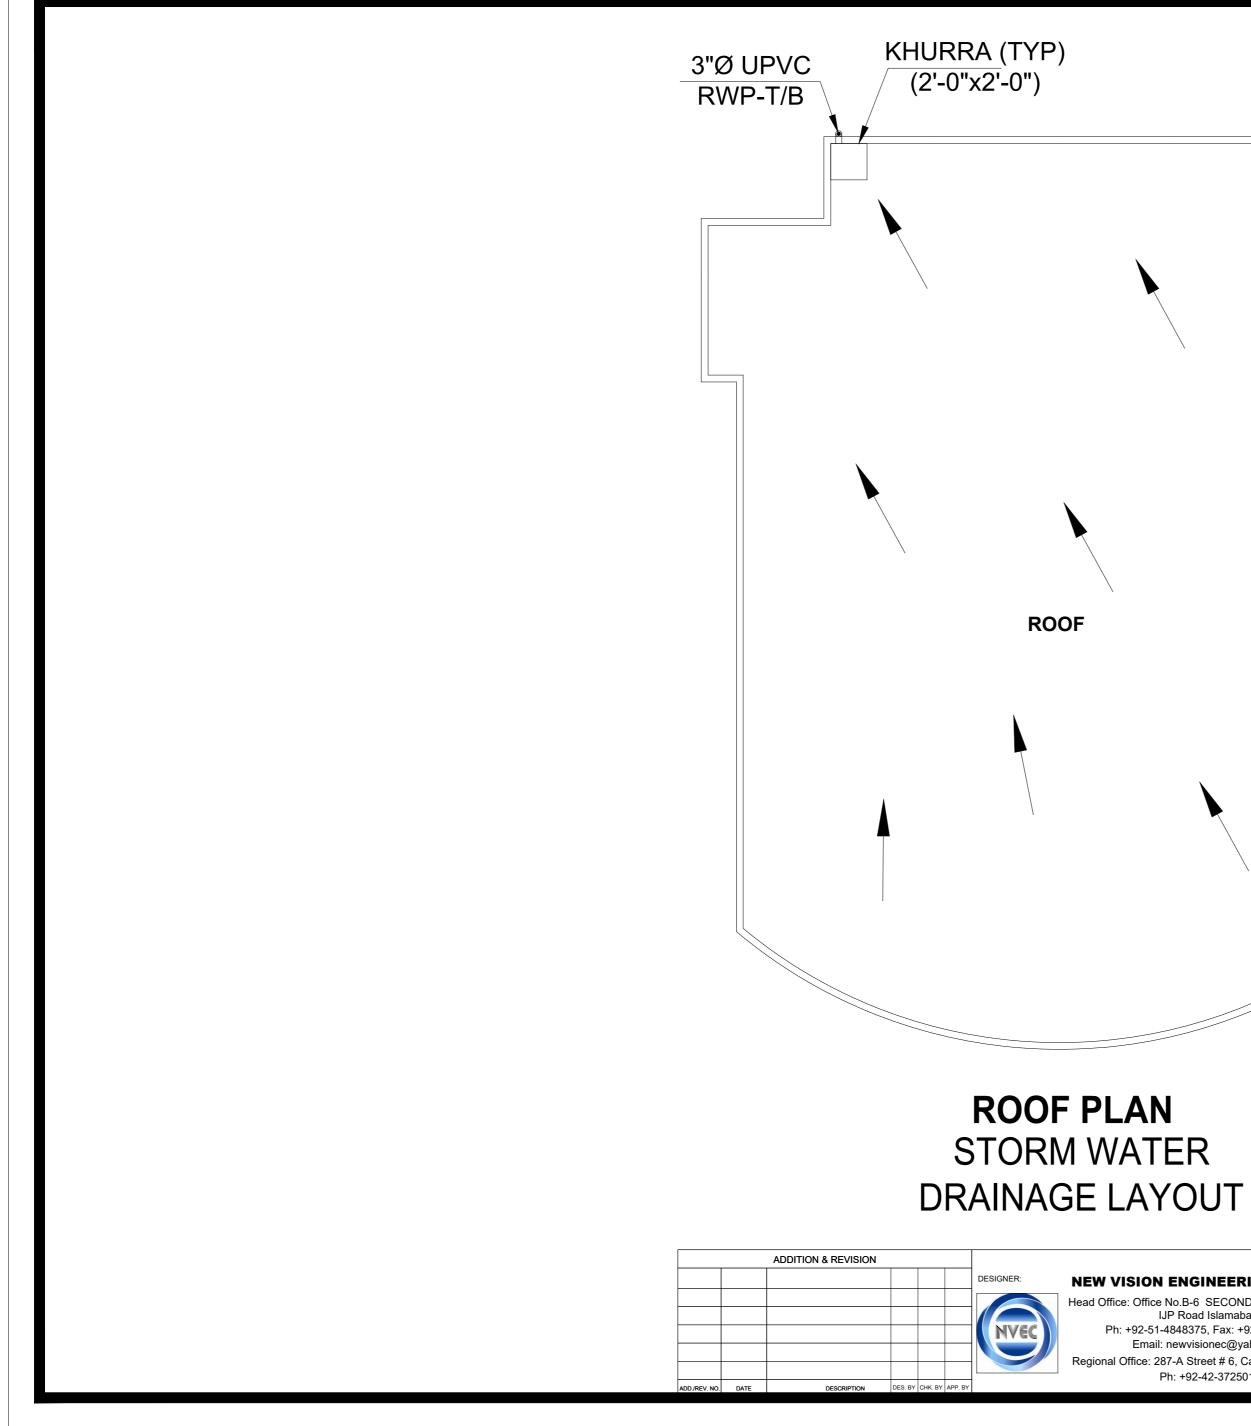


O.H.W.T

VISION ENGINEERING CONSULTANT		CLIENT: LIAQUAT UNIVERSITY OF MEDICIAL & HEALTH SCIENCE JAMSHORO		
ffice: Office No.B-6 SECOND FLOOR Masood Arcade IJP Road Islamabad. Ph: +92-51-4848375, Fax: +92-51-4848375 Email: newvisionec@yahoo.com al Office: 287-A Street # 6, Cavalry Ground ,Lahore		DESIGNED BY: MATHEW DRAWN BY: MATHEW SIMON	APPROVED BY: JOB NO.	DATE : MARCH, 2024 SCALE: N.T.S
Ph: +92-42-37250130		DRG. NO.	PL-03	

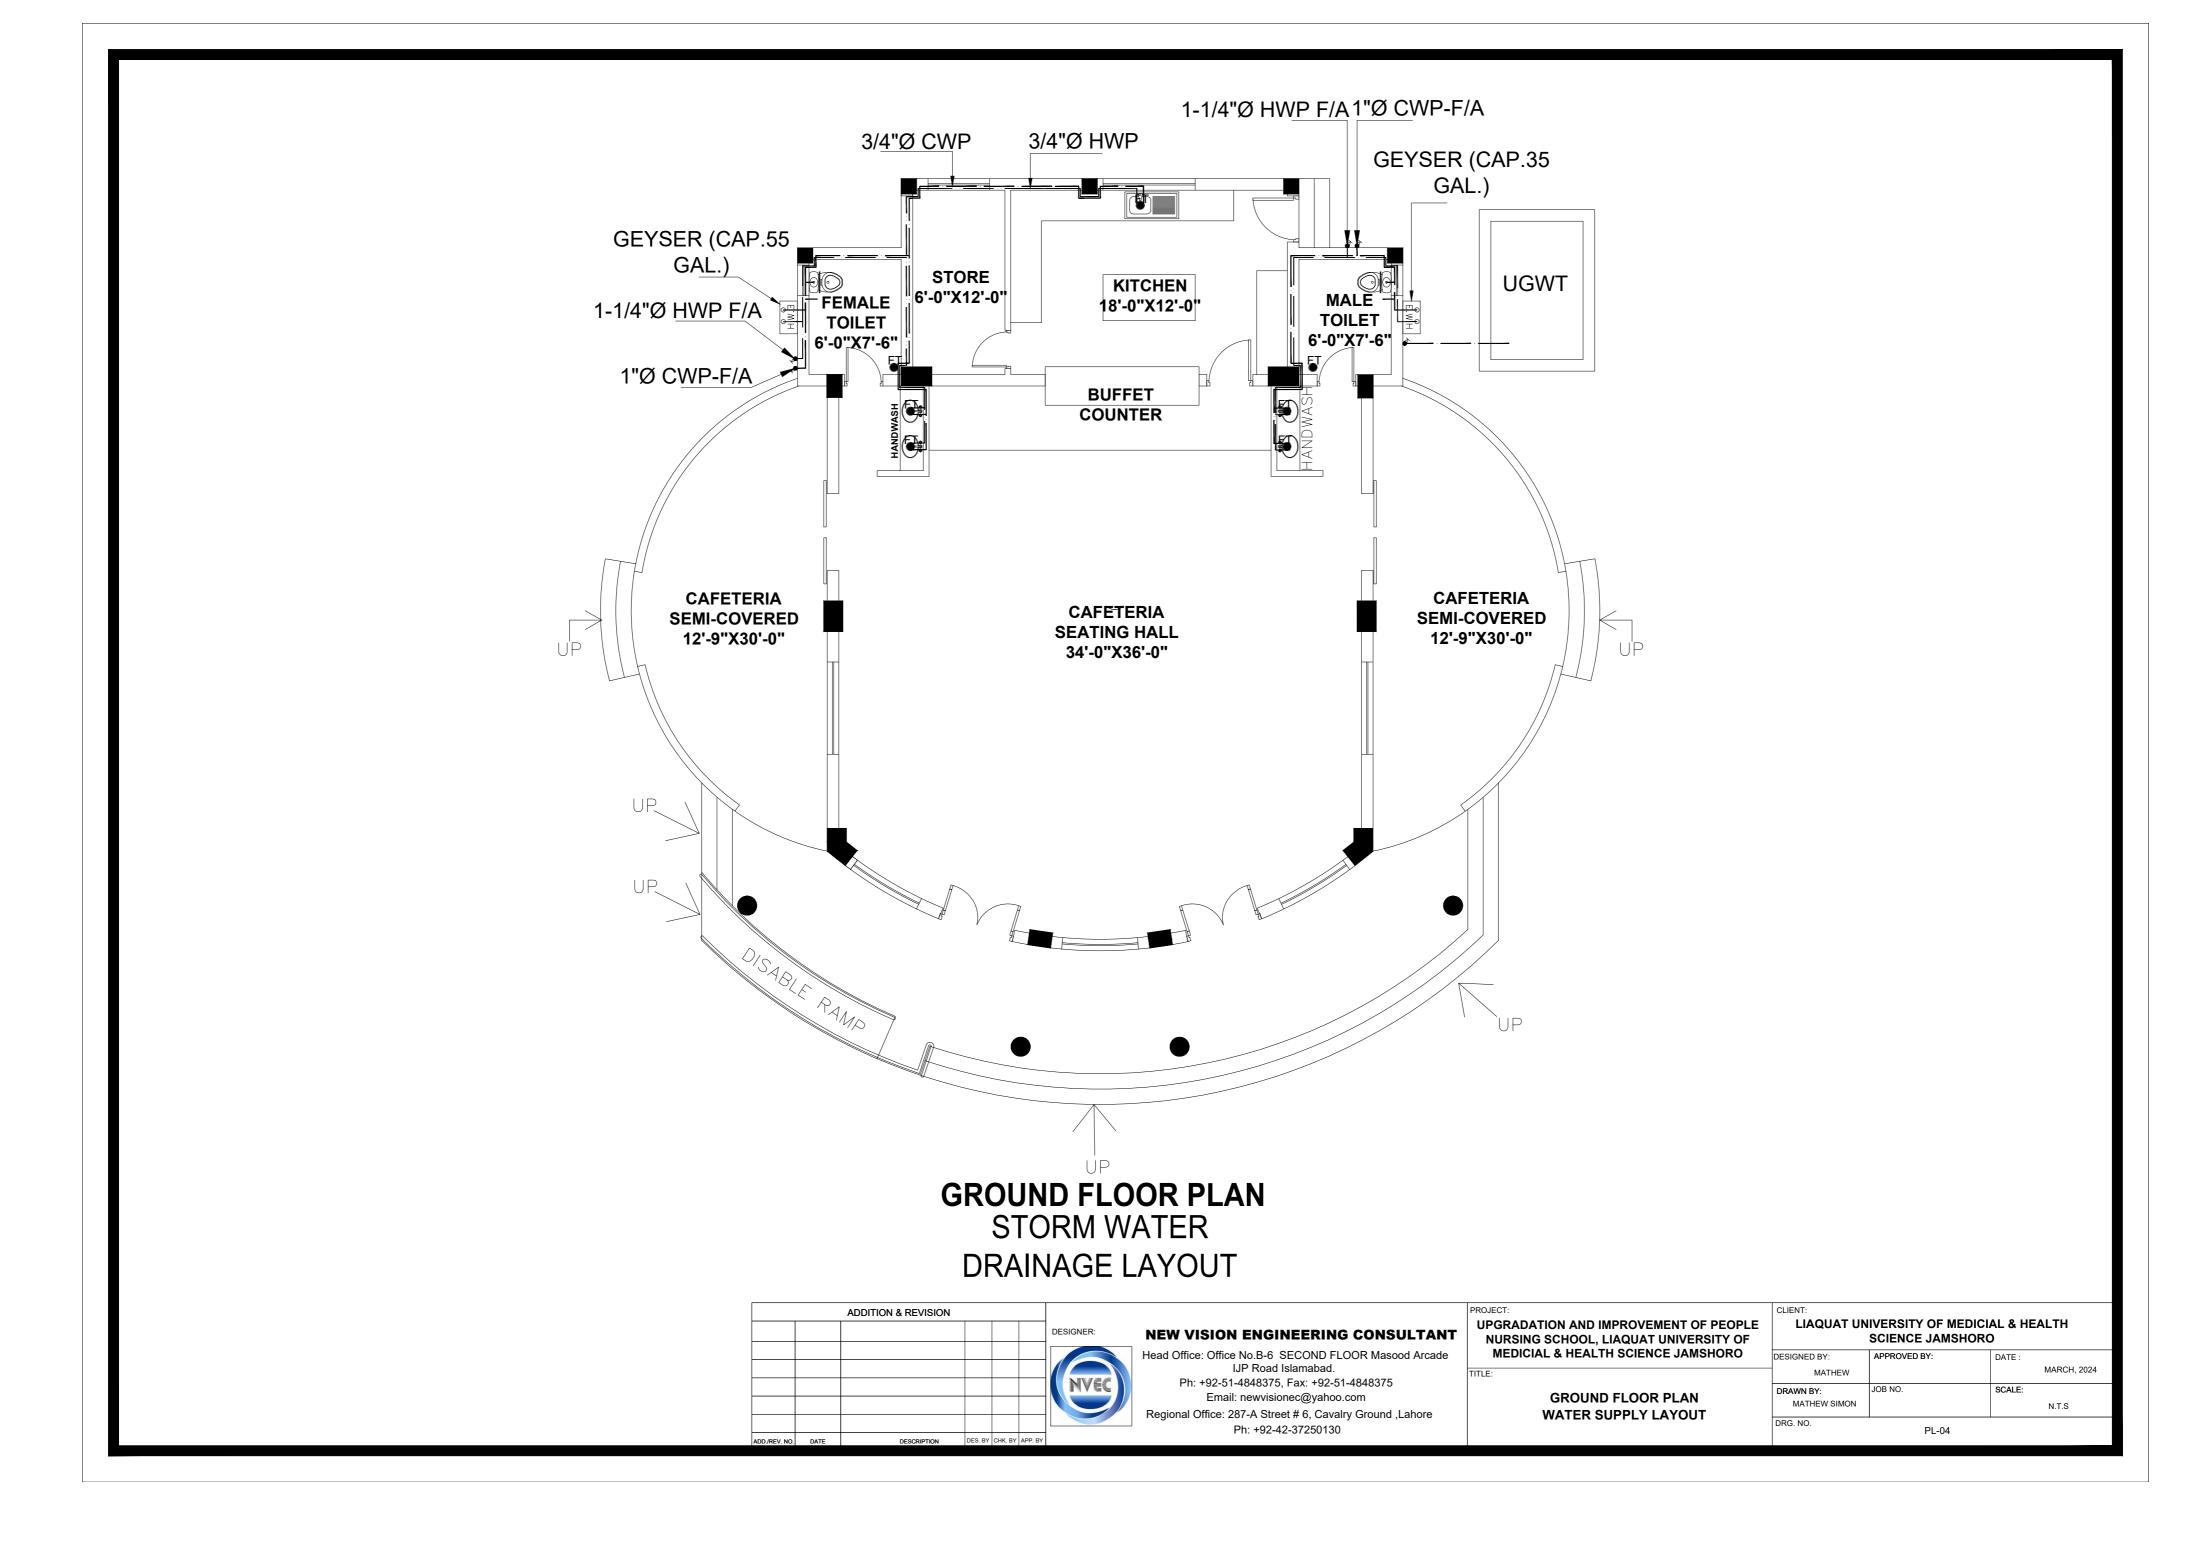

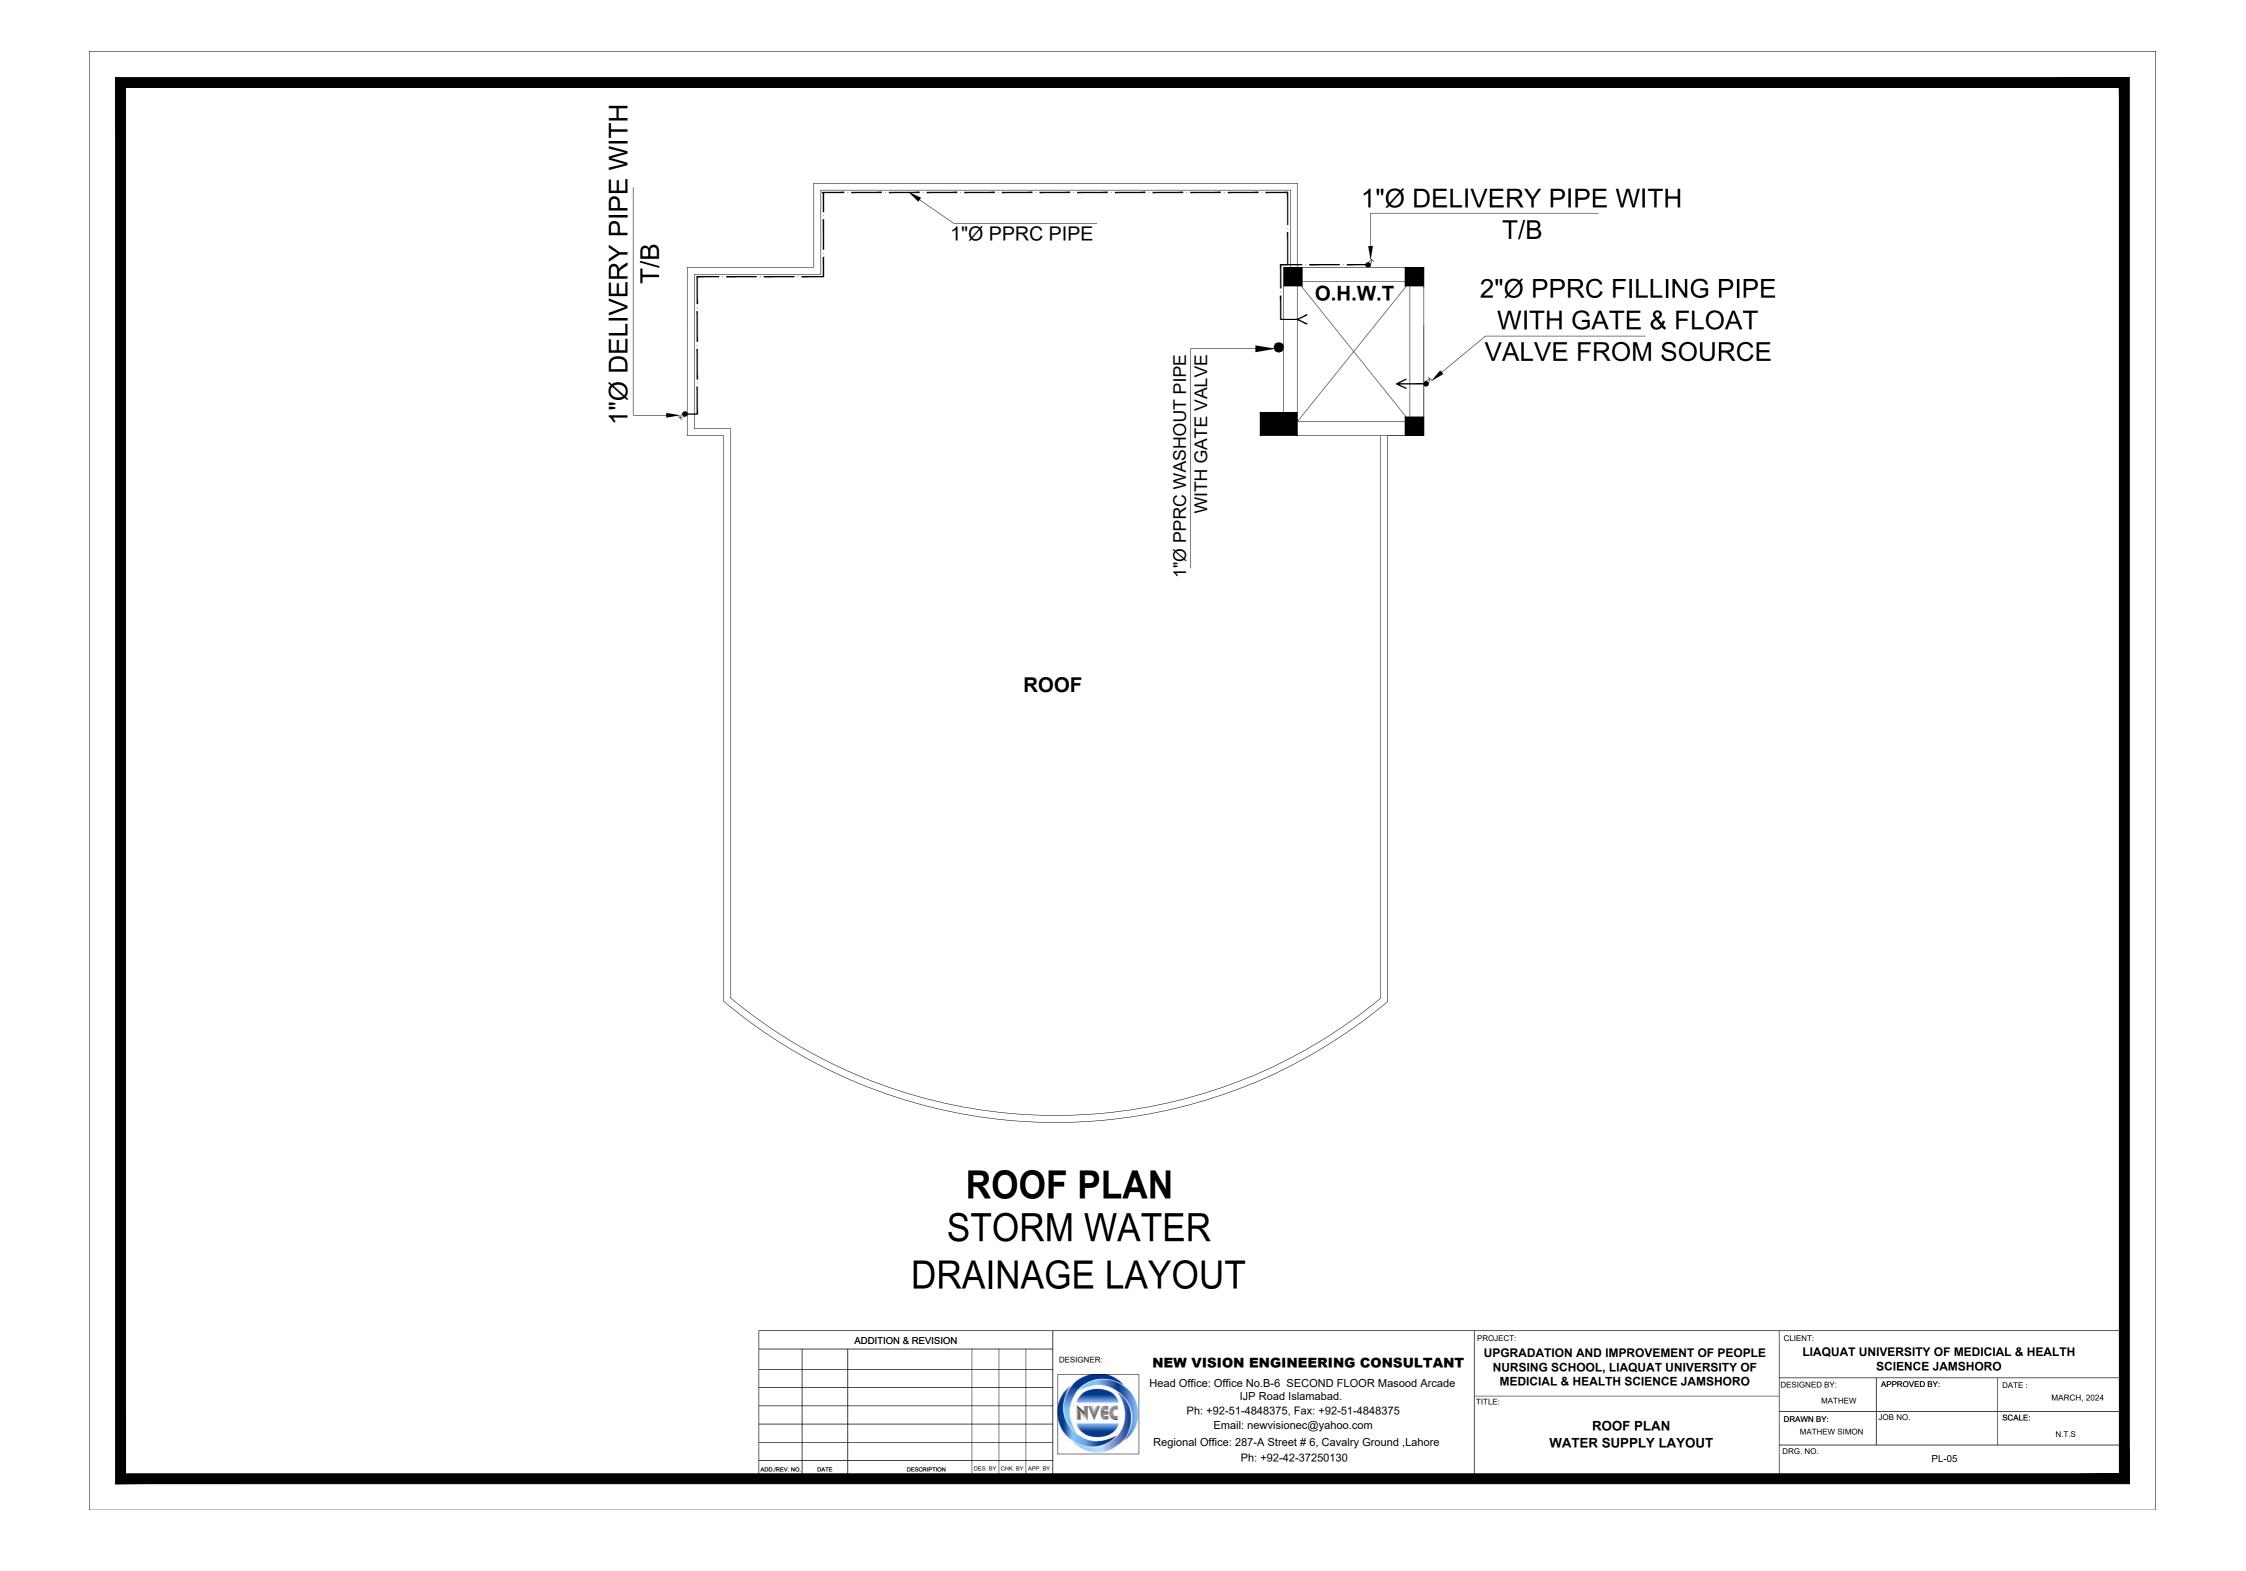

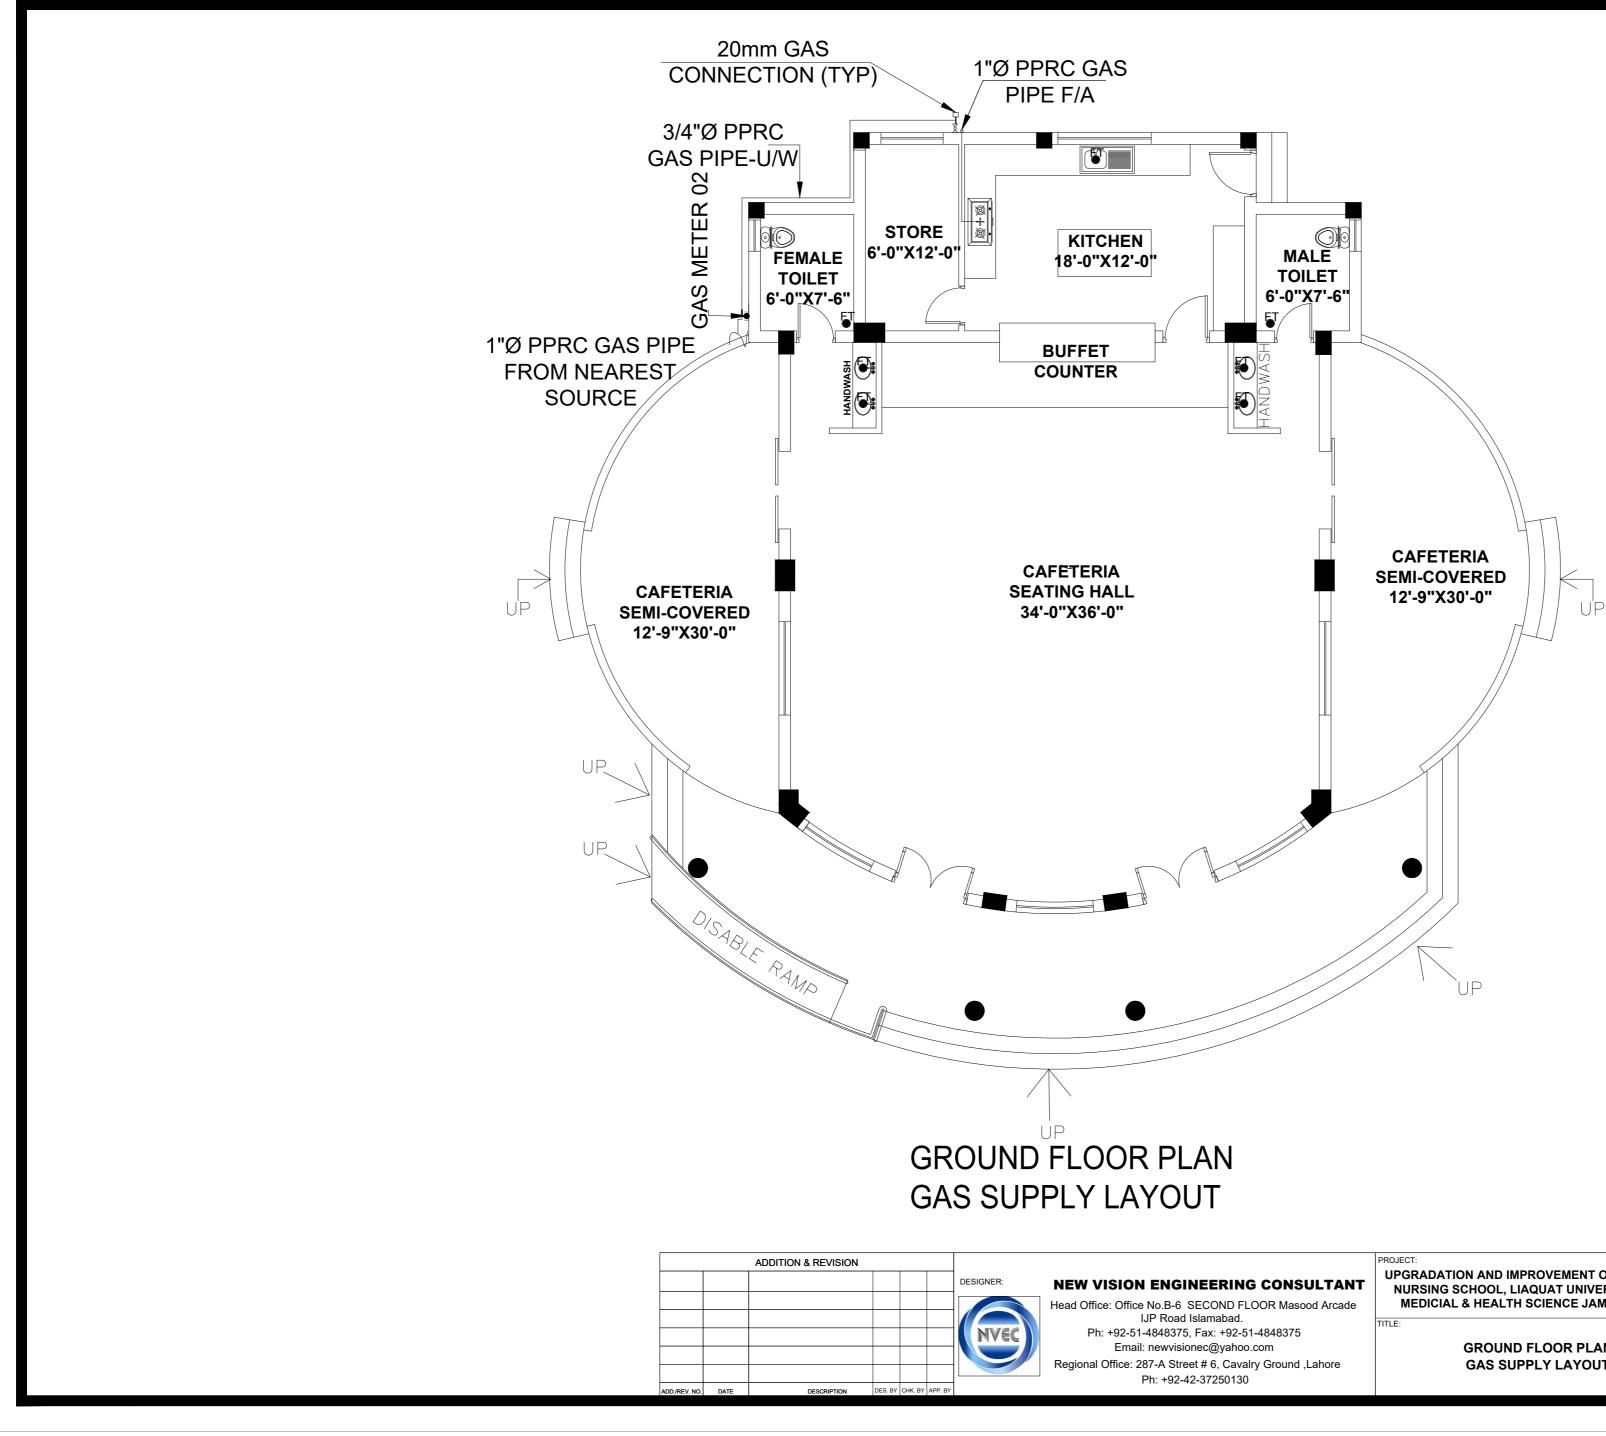

VISION ENGINEERING CONSULTANT	PROJECT: UPGRADATION AND IMPROVEMENT OF PEOPLE NURSING SCHOOL, LIAQUAT UNIVERSITY OF	CLIENT: LIAQUAT UNIVERSITY OF MEDICIAL & HEALTH SCIENCE JAMSHORO		
ffice: Office No.B-6 SECOND FLOOR Masood Arcade IJP Road Islamabad.	MEDICIAL & HEALTH SCIENCE JAMSHORO	DESIGNED BY: MATHEW	APPROVED BY:	DATE : MARCH, 2024
h: +92-51-4848375, Fax: +92-51-4848375 Email: newvisionec@yahoo.com al Office: 287-A Street # 6, Cavalry Ground ,Lahore	GROUND FLOOR PLAN GAS SUPPLY LAYOUT	DRAWN BY: MATHEW SIMON	JOB NO.	SCALE: N.T.S
Ph: +92-42-37250130	GAS SUPPLI LATOUT	DRG. NO.	PL-06	I

