

LIAQUAT UNIVERSITY OF MEDICIAL & HEALTH SCIENCE JAMSHORO

UPGRADATION AND IMPROVEMENT OF PEOPLE NURSING SCHOOL, LIAQUAT UNIVERSITY OF MEDICIAL & HEALTH SCIENCE JAMSHORO

ACADEMIC BLOCK TENDER DRAWINGS

APRIL, 2024

DESIGN BY

NEW VISION ENGINEERING CONSULTANT



HEAD OFFICE:

Office No.B-6 Second Floor Masood Arcade IJP Road Islamabad.

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Email: newvisionec@yahoo.com

REGIONAL OFFICE:

287-A Street # 6, Cavalry Ground ,Lahore Ph: +92-42-37250130

LIST OF DRAWINGS DRAWING TITLE DRG. NO S.NO. ARCHITECTURE DRAWINGS LIST OF DRAWING LS-00 2 MASTER PLAN MP-01 3D VIEW 3 3D-02 3D VIEW 3D-02 4 GROUND FLOOR PLAN 5 AR-01 **ROOF PLAN** 6 AR-02 **ELEVATION E1** AR-03 ELEVATION E2 AR-04 8 **ELEVATION E3** AR-05 9 **ELEVATION E4** 10 AR-06 SECTION A-A 11 AR-07 SCHEDULE OF OPENINGS AR-08 12 DOOR & WINDOW ELEVATION AR-09 13 RAMP SECTION DETAIL AR-09A 14 FLOOR FINISHING DETAILS AR-10 15 TYPICAL SAFETY GRILL DETAIL AR-11 16

		ADDITION & REVISION			
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	TITLE:	LUMHS ACADEMIC BLOCK LIST OF DRAWINGS	DRA


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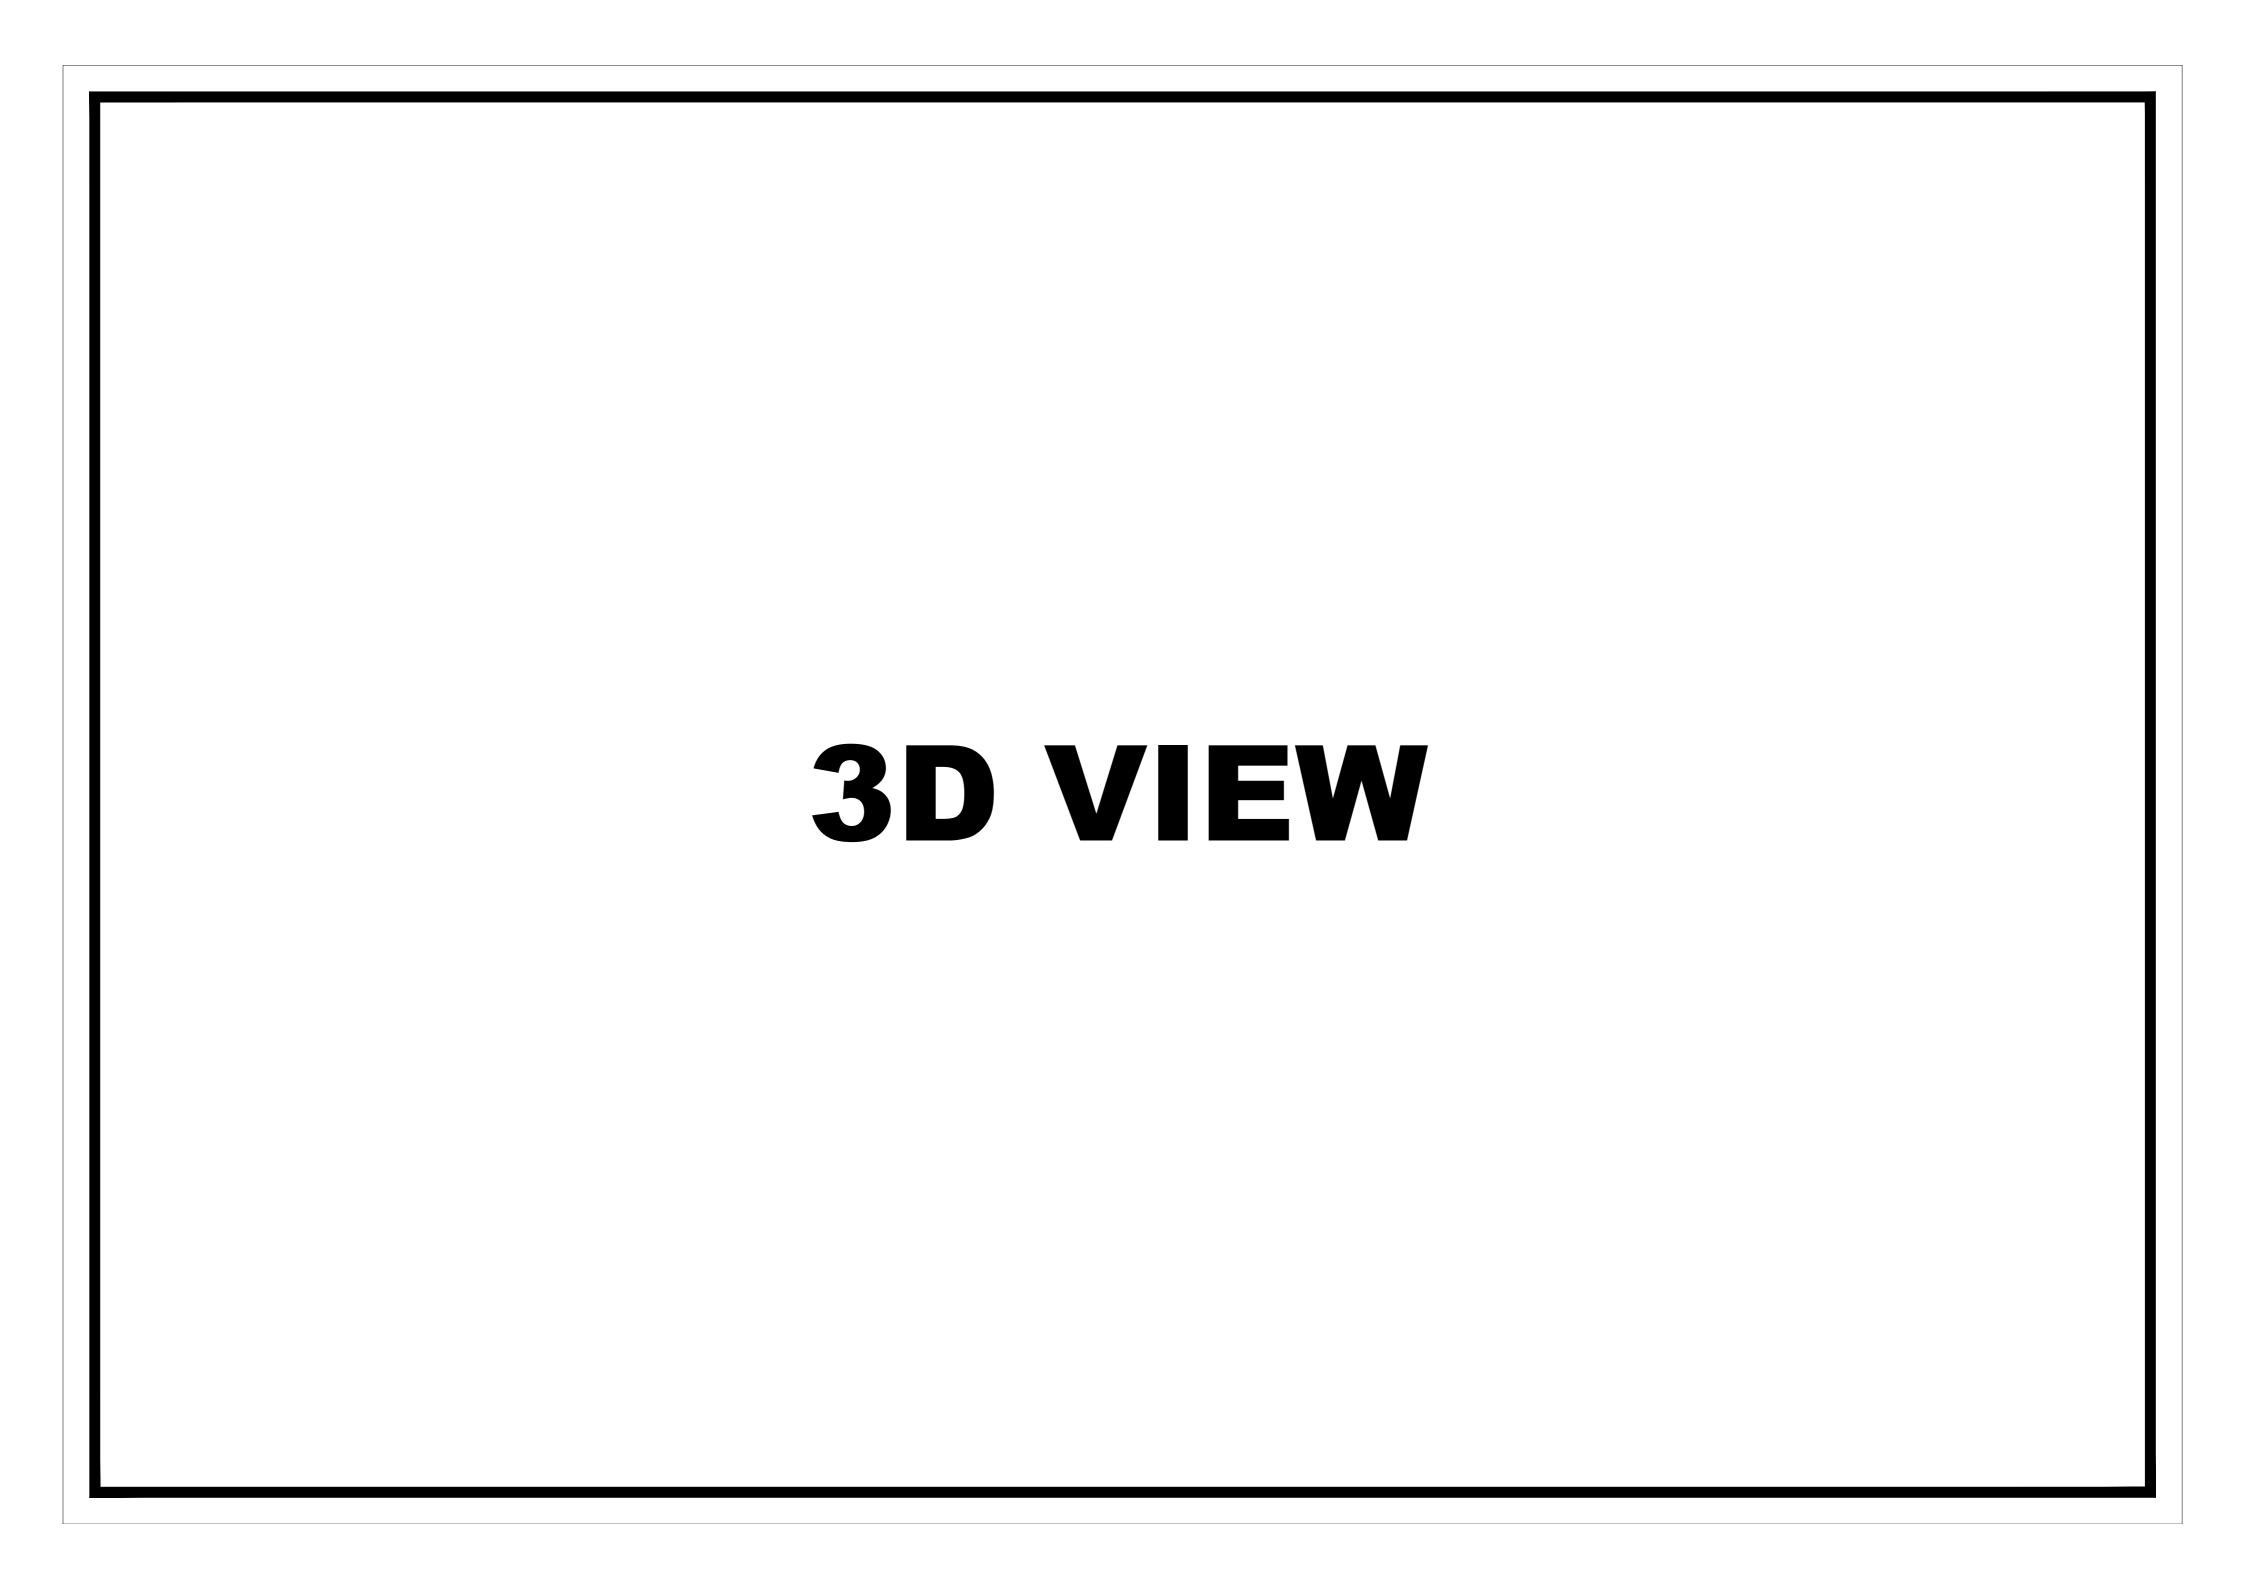
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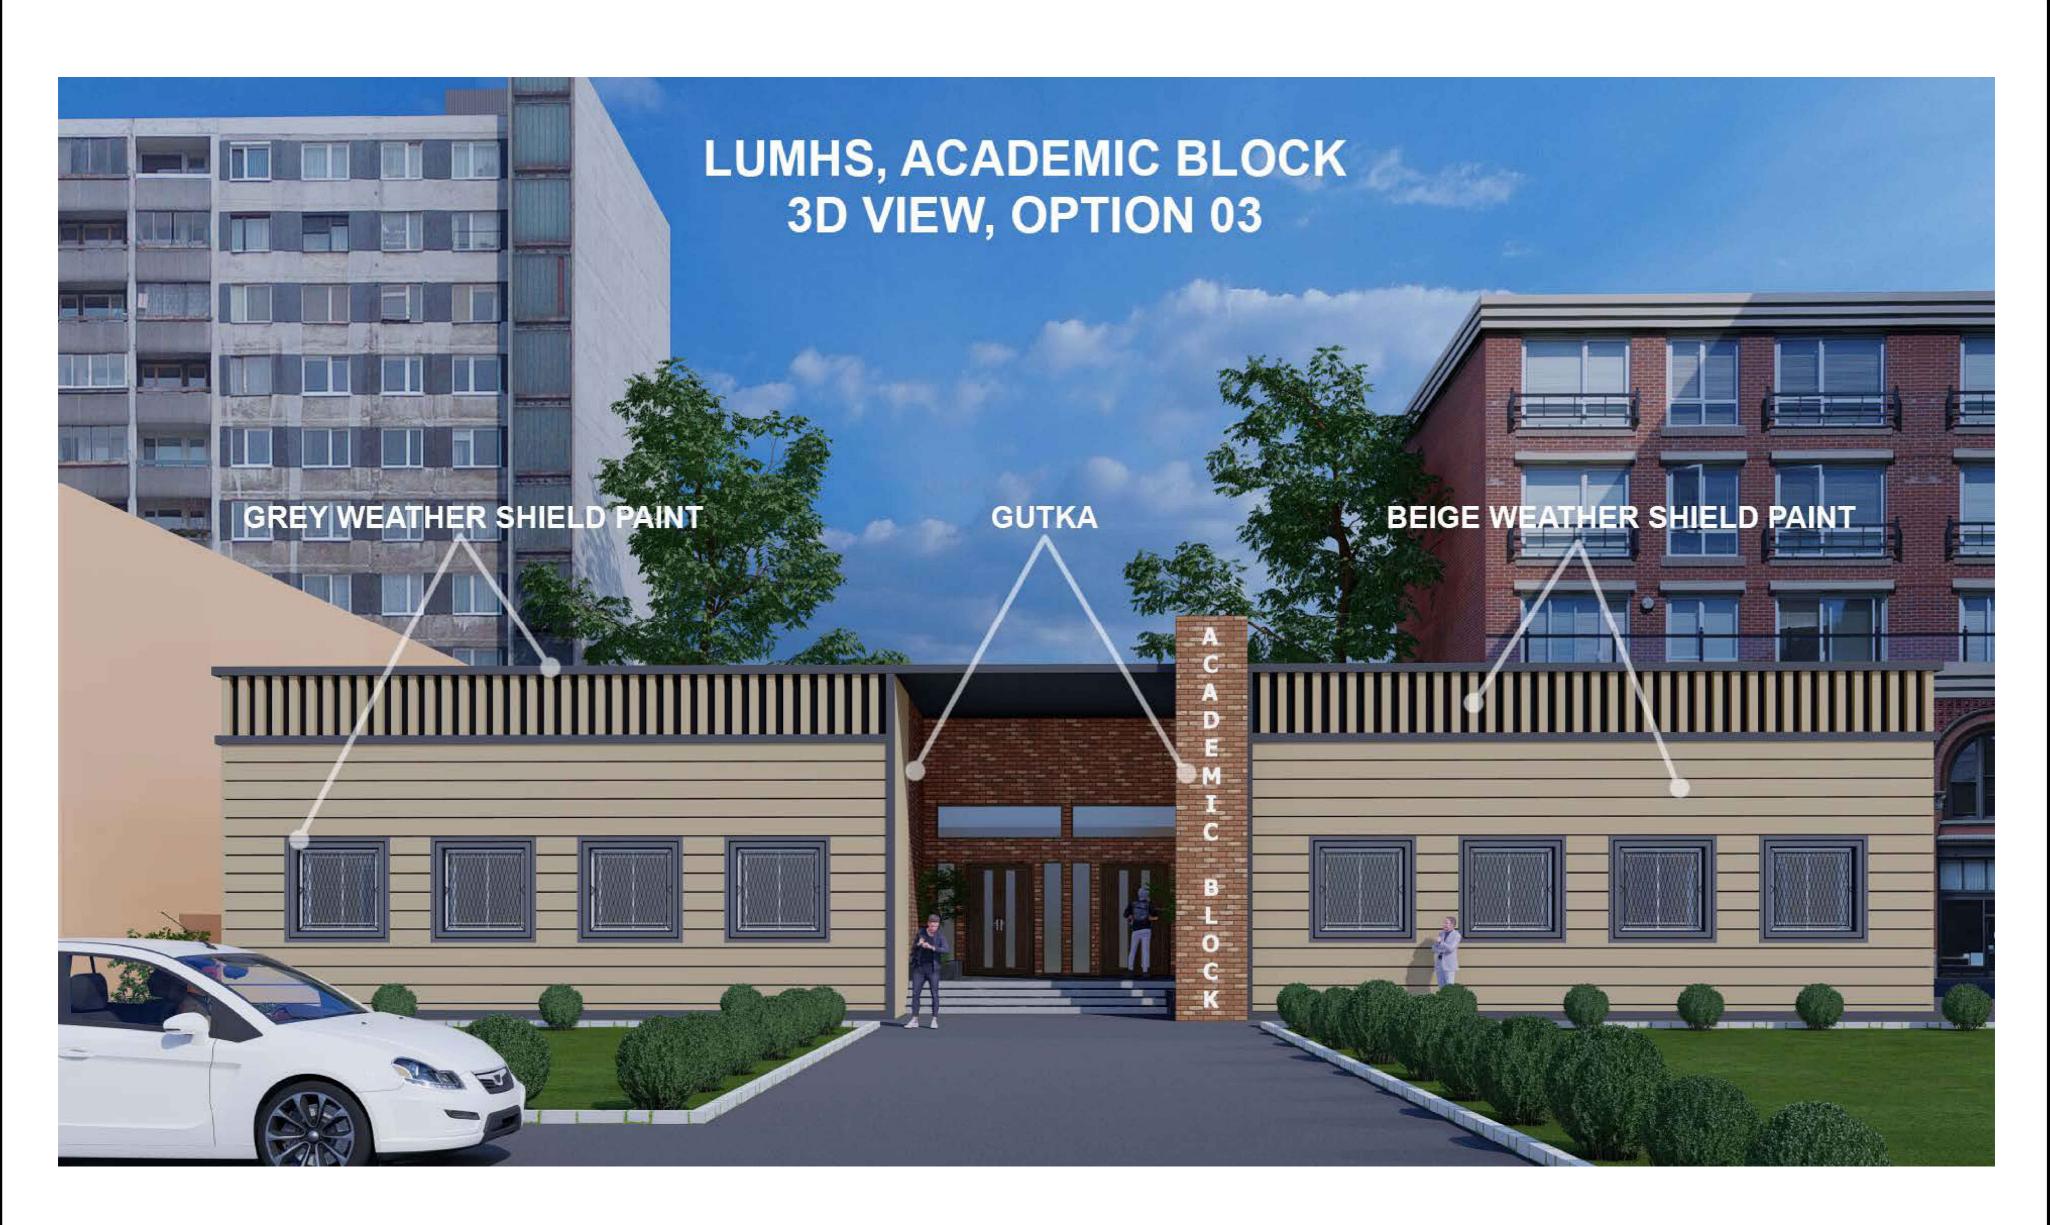
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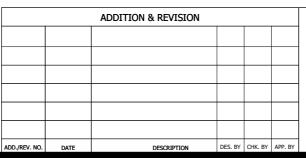
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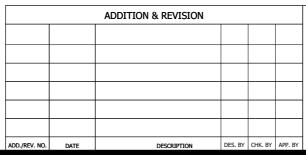
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TITI	E: LUMHS ACADEMIC BLOCK 3D VIEW

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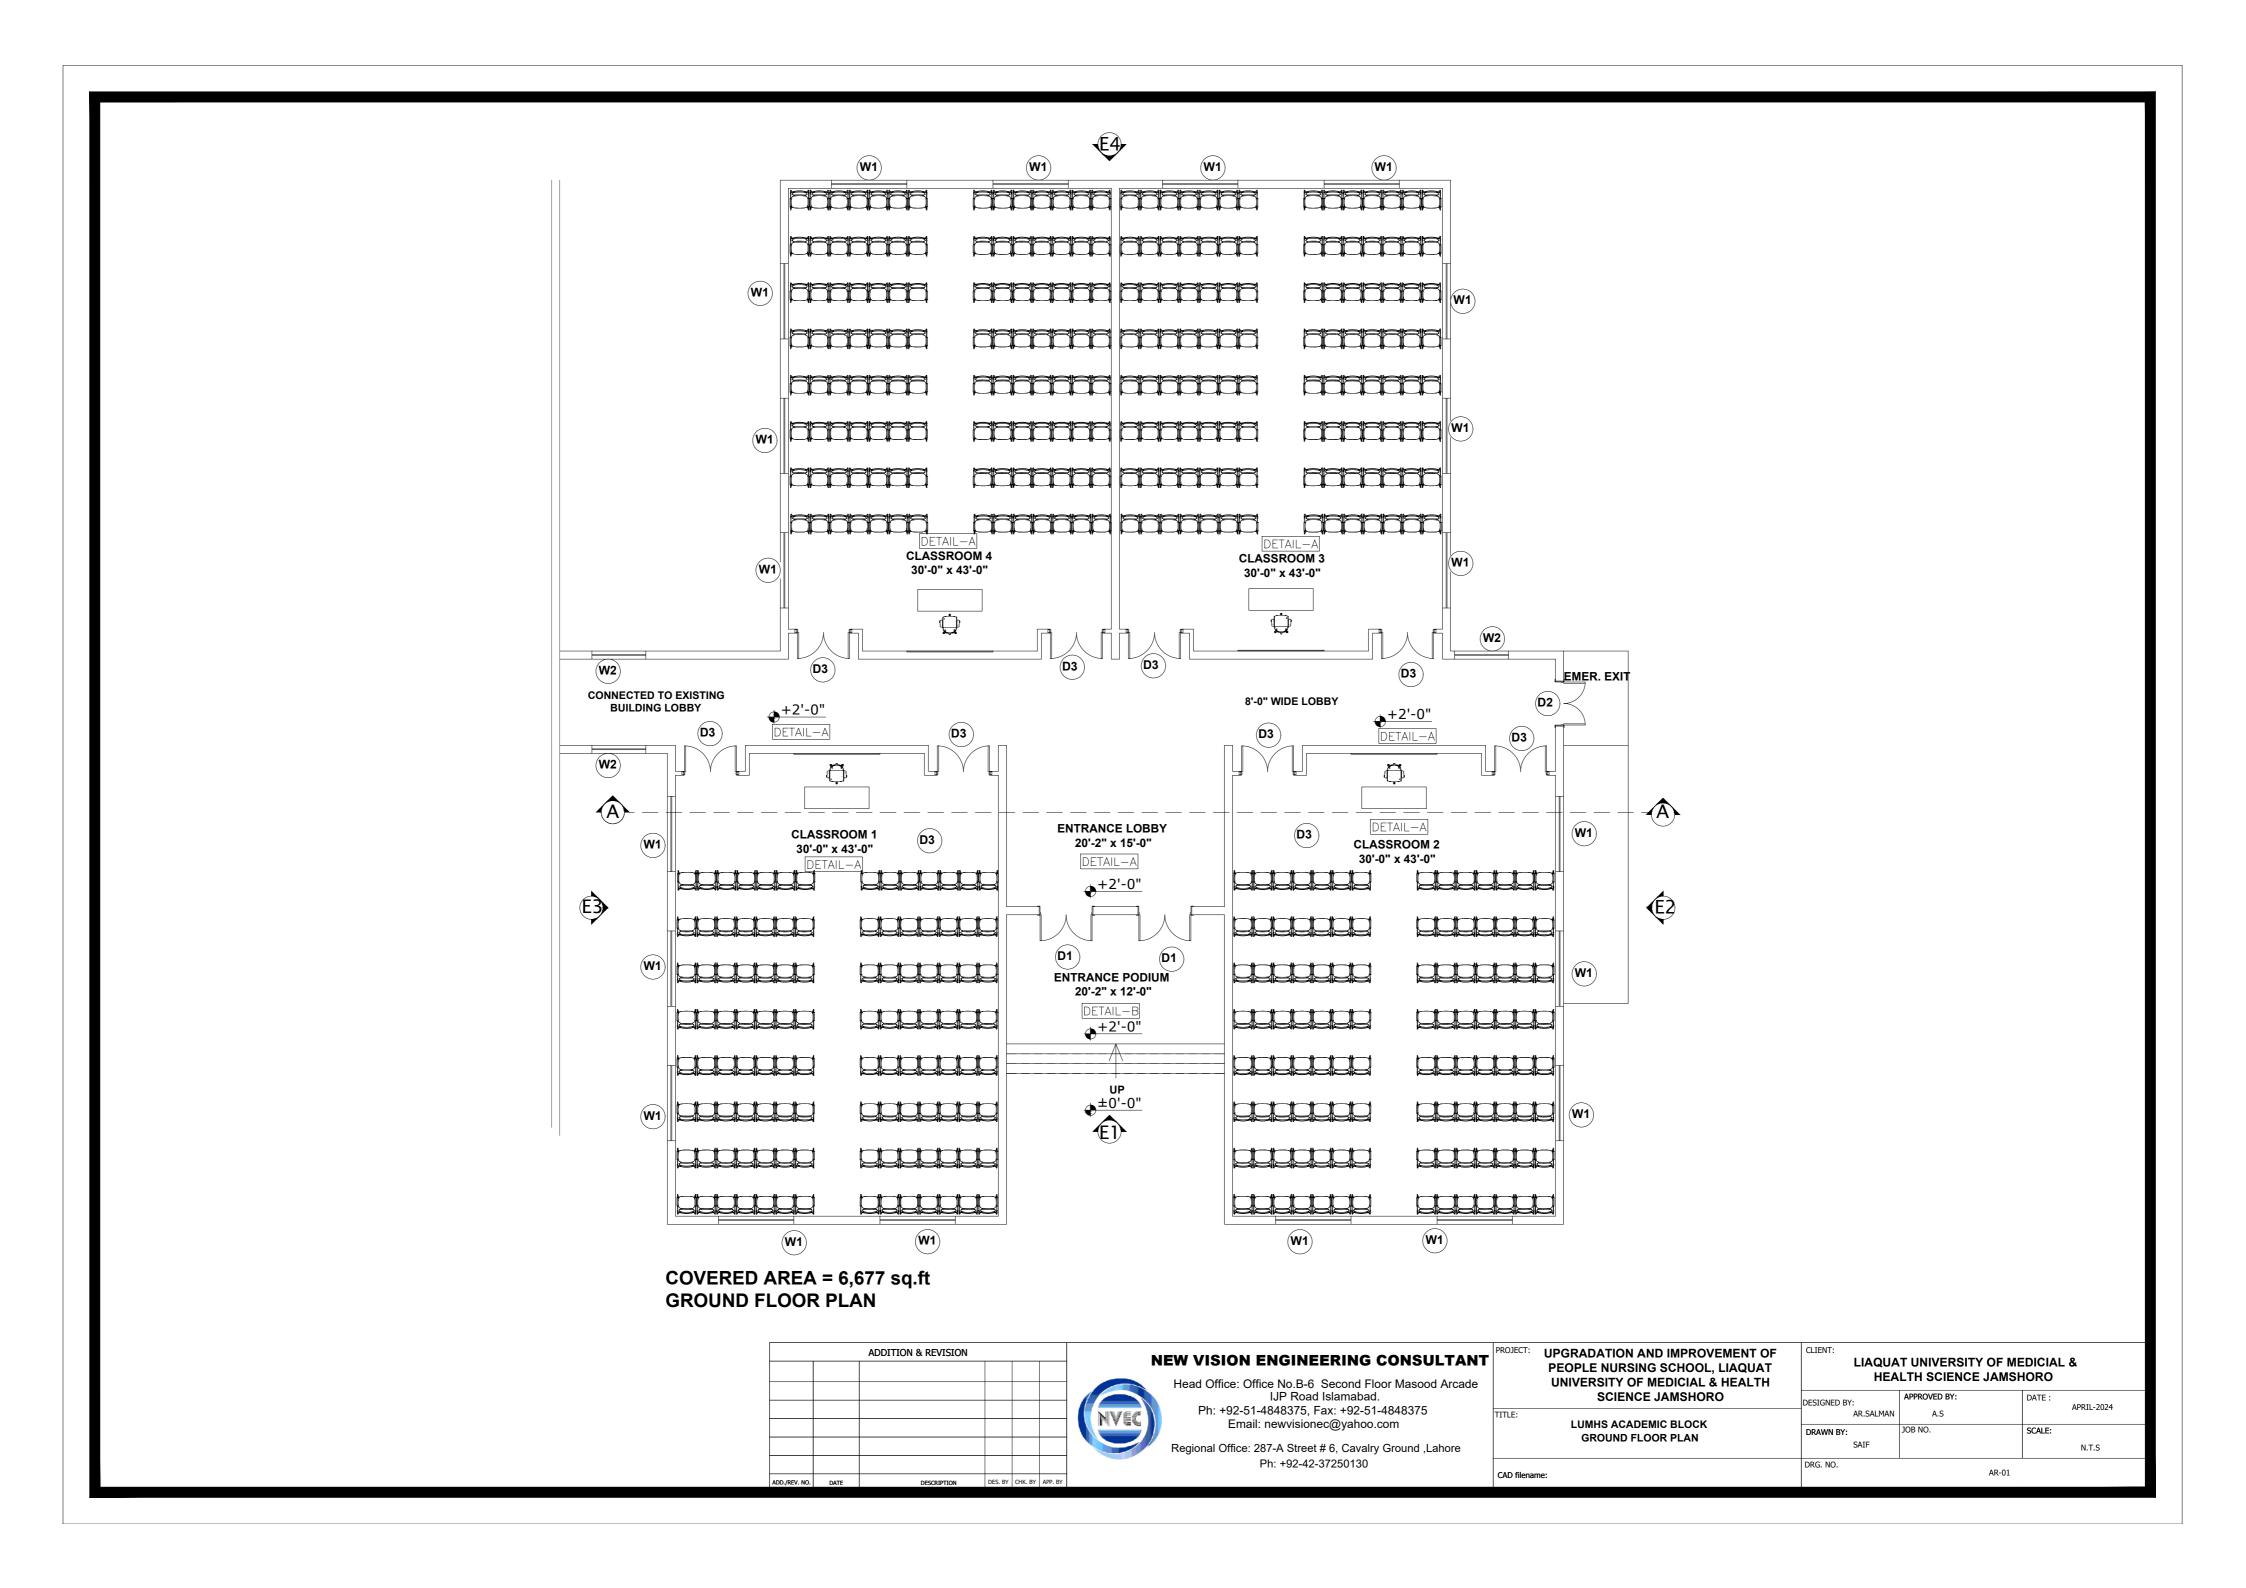
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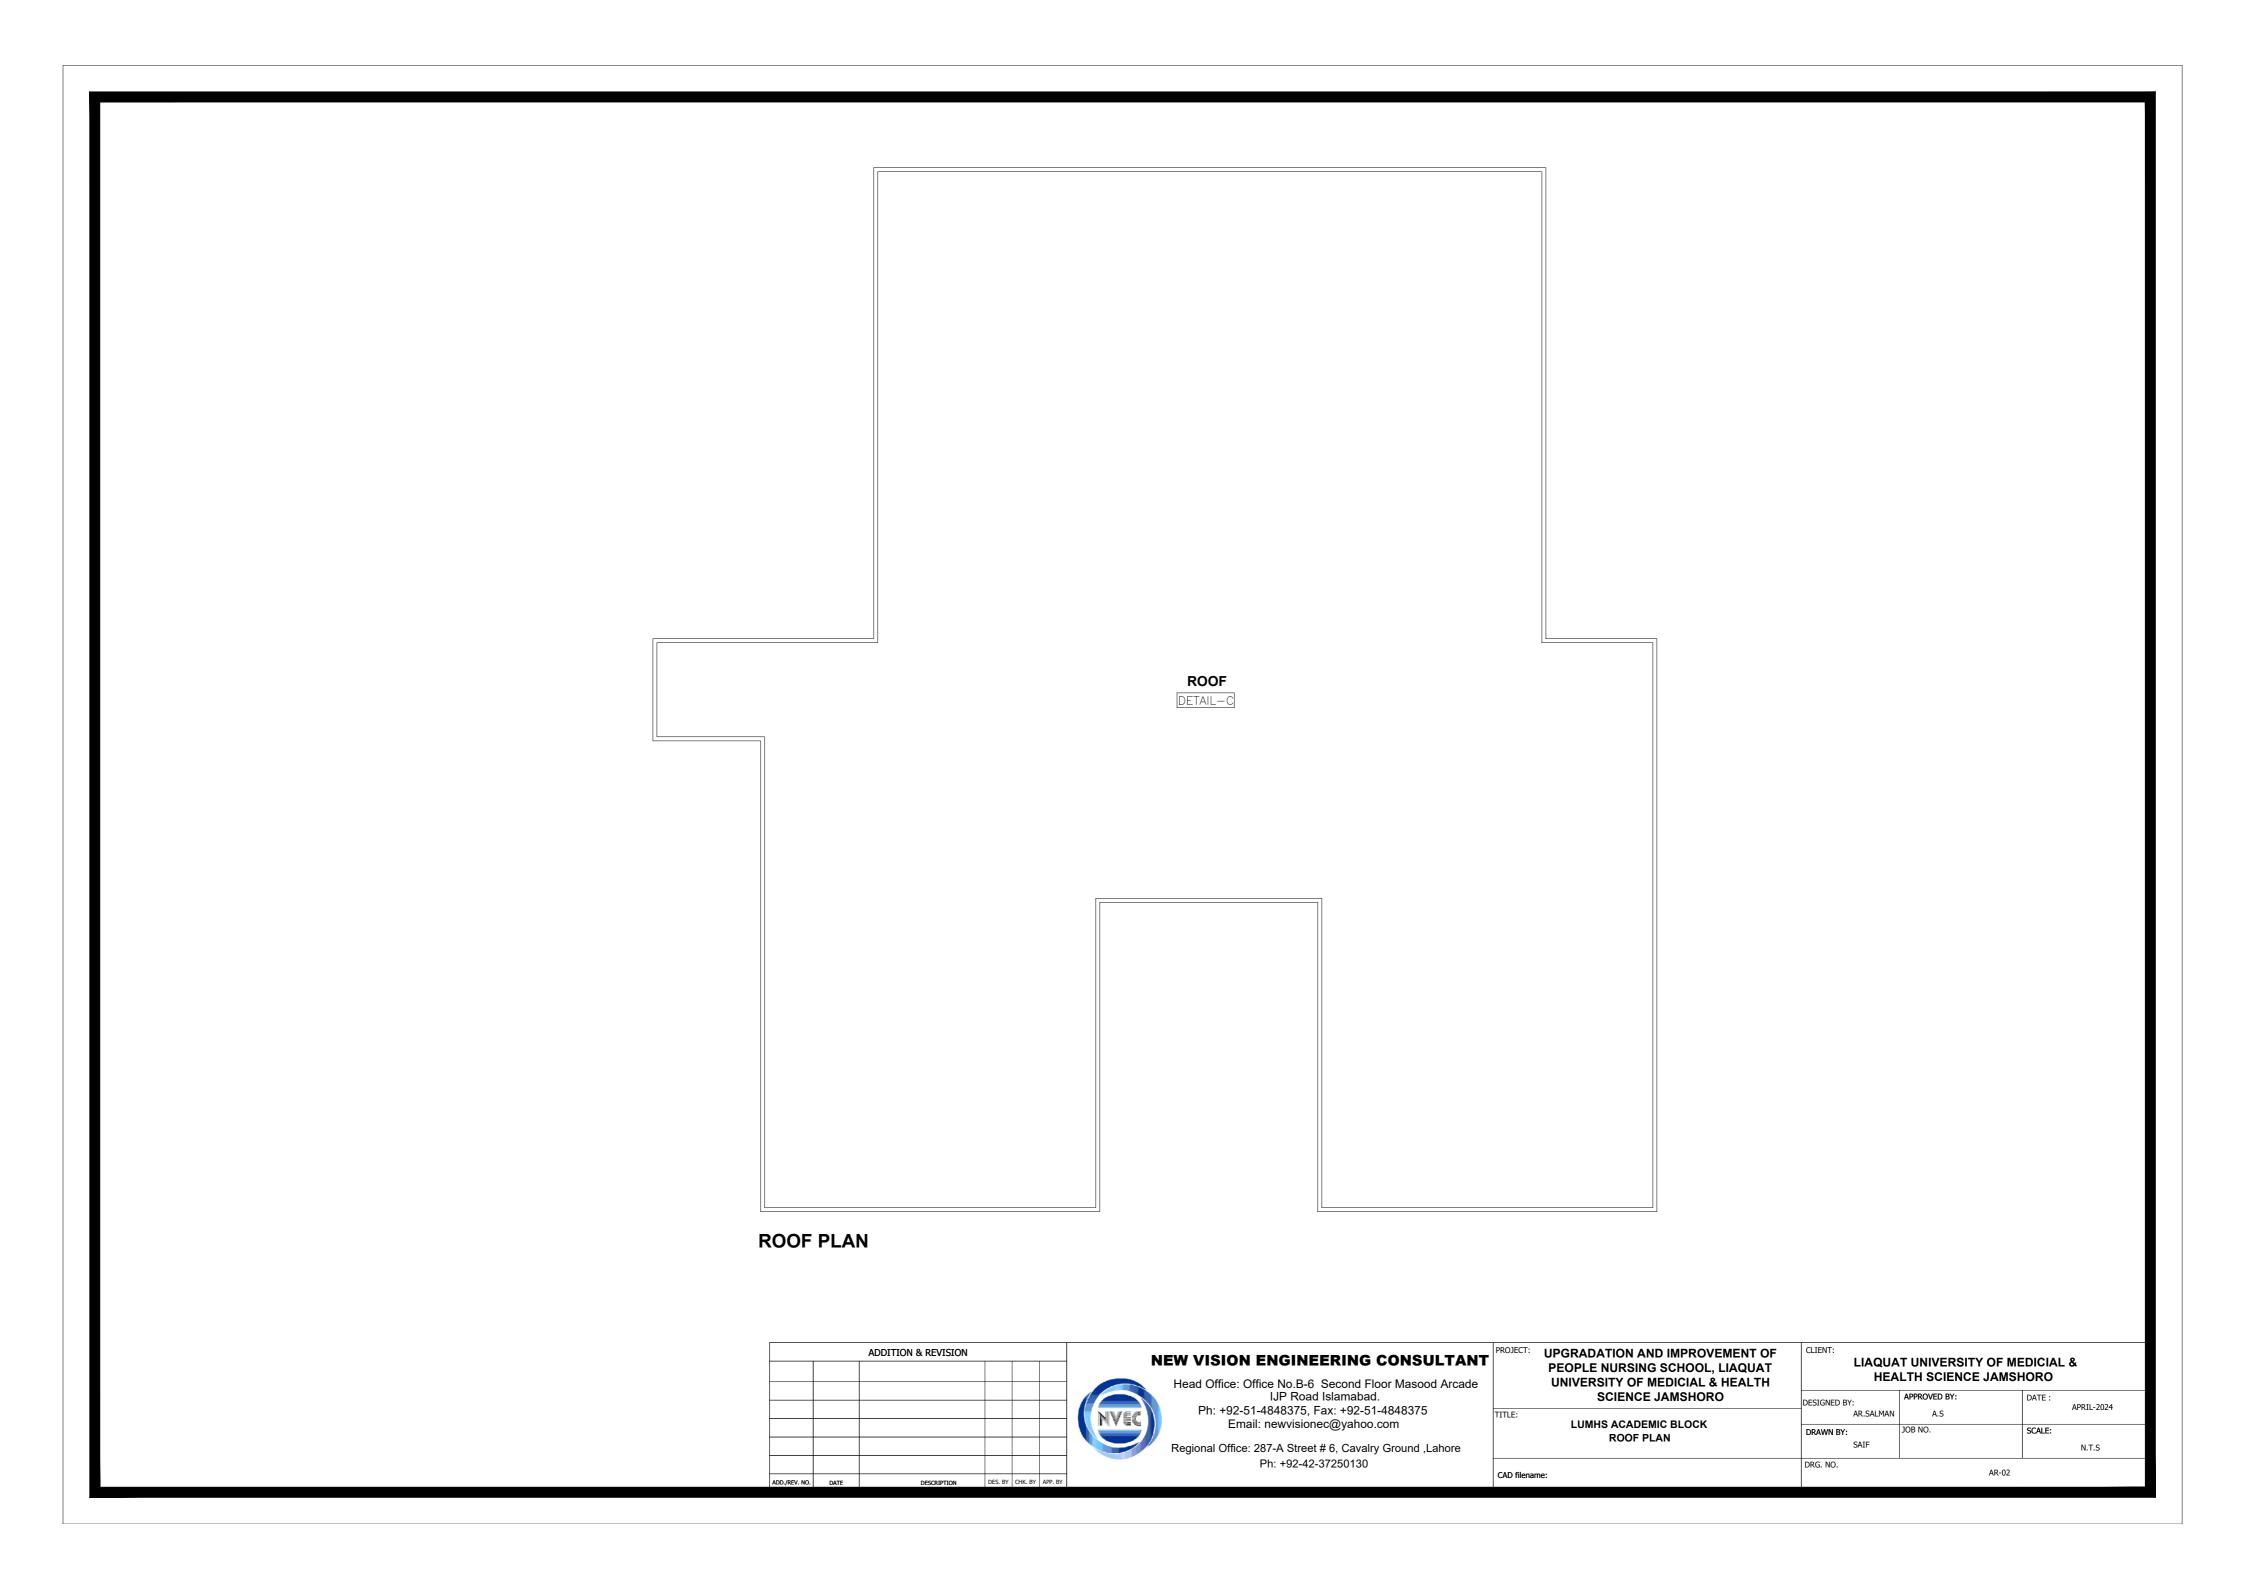
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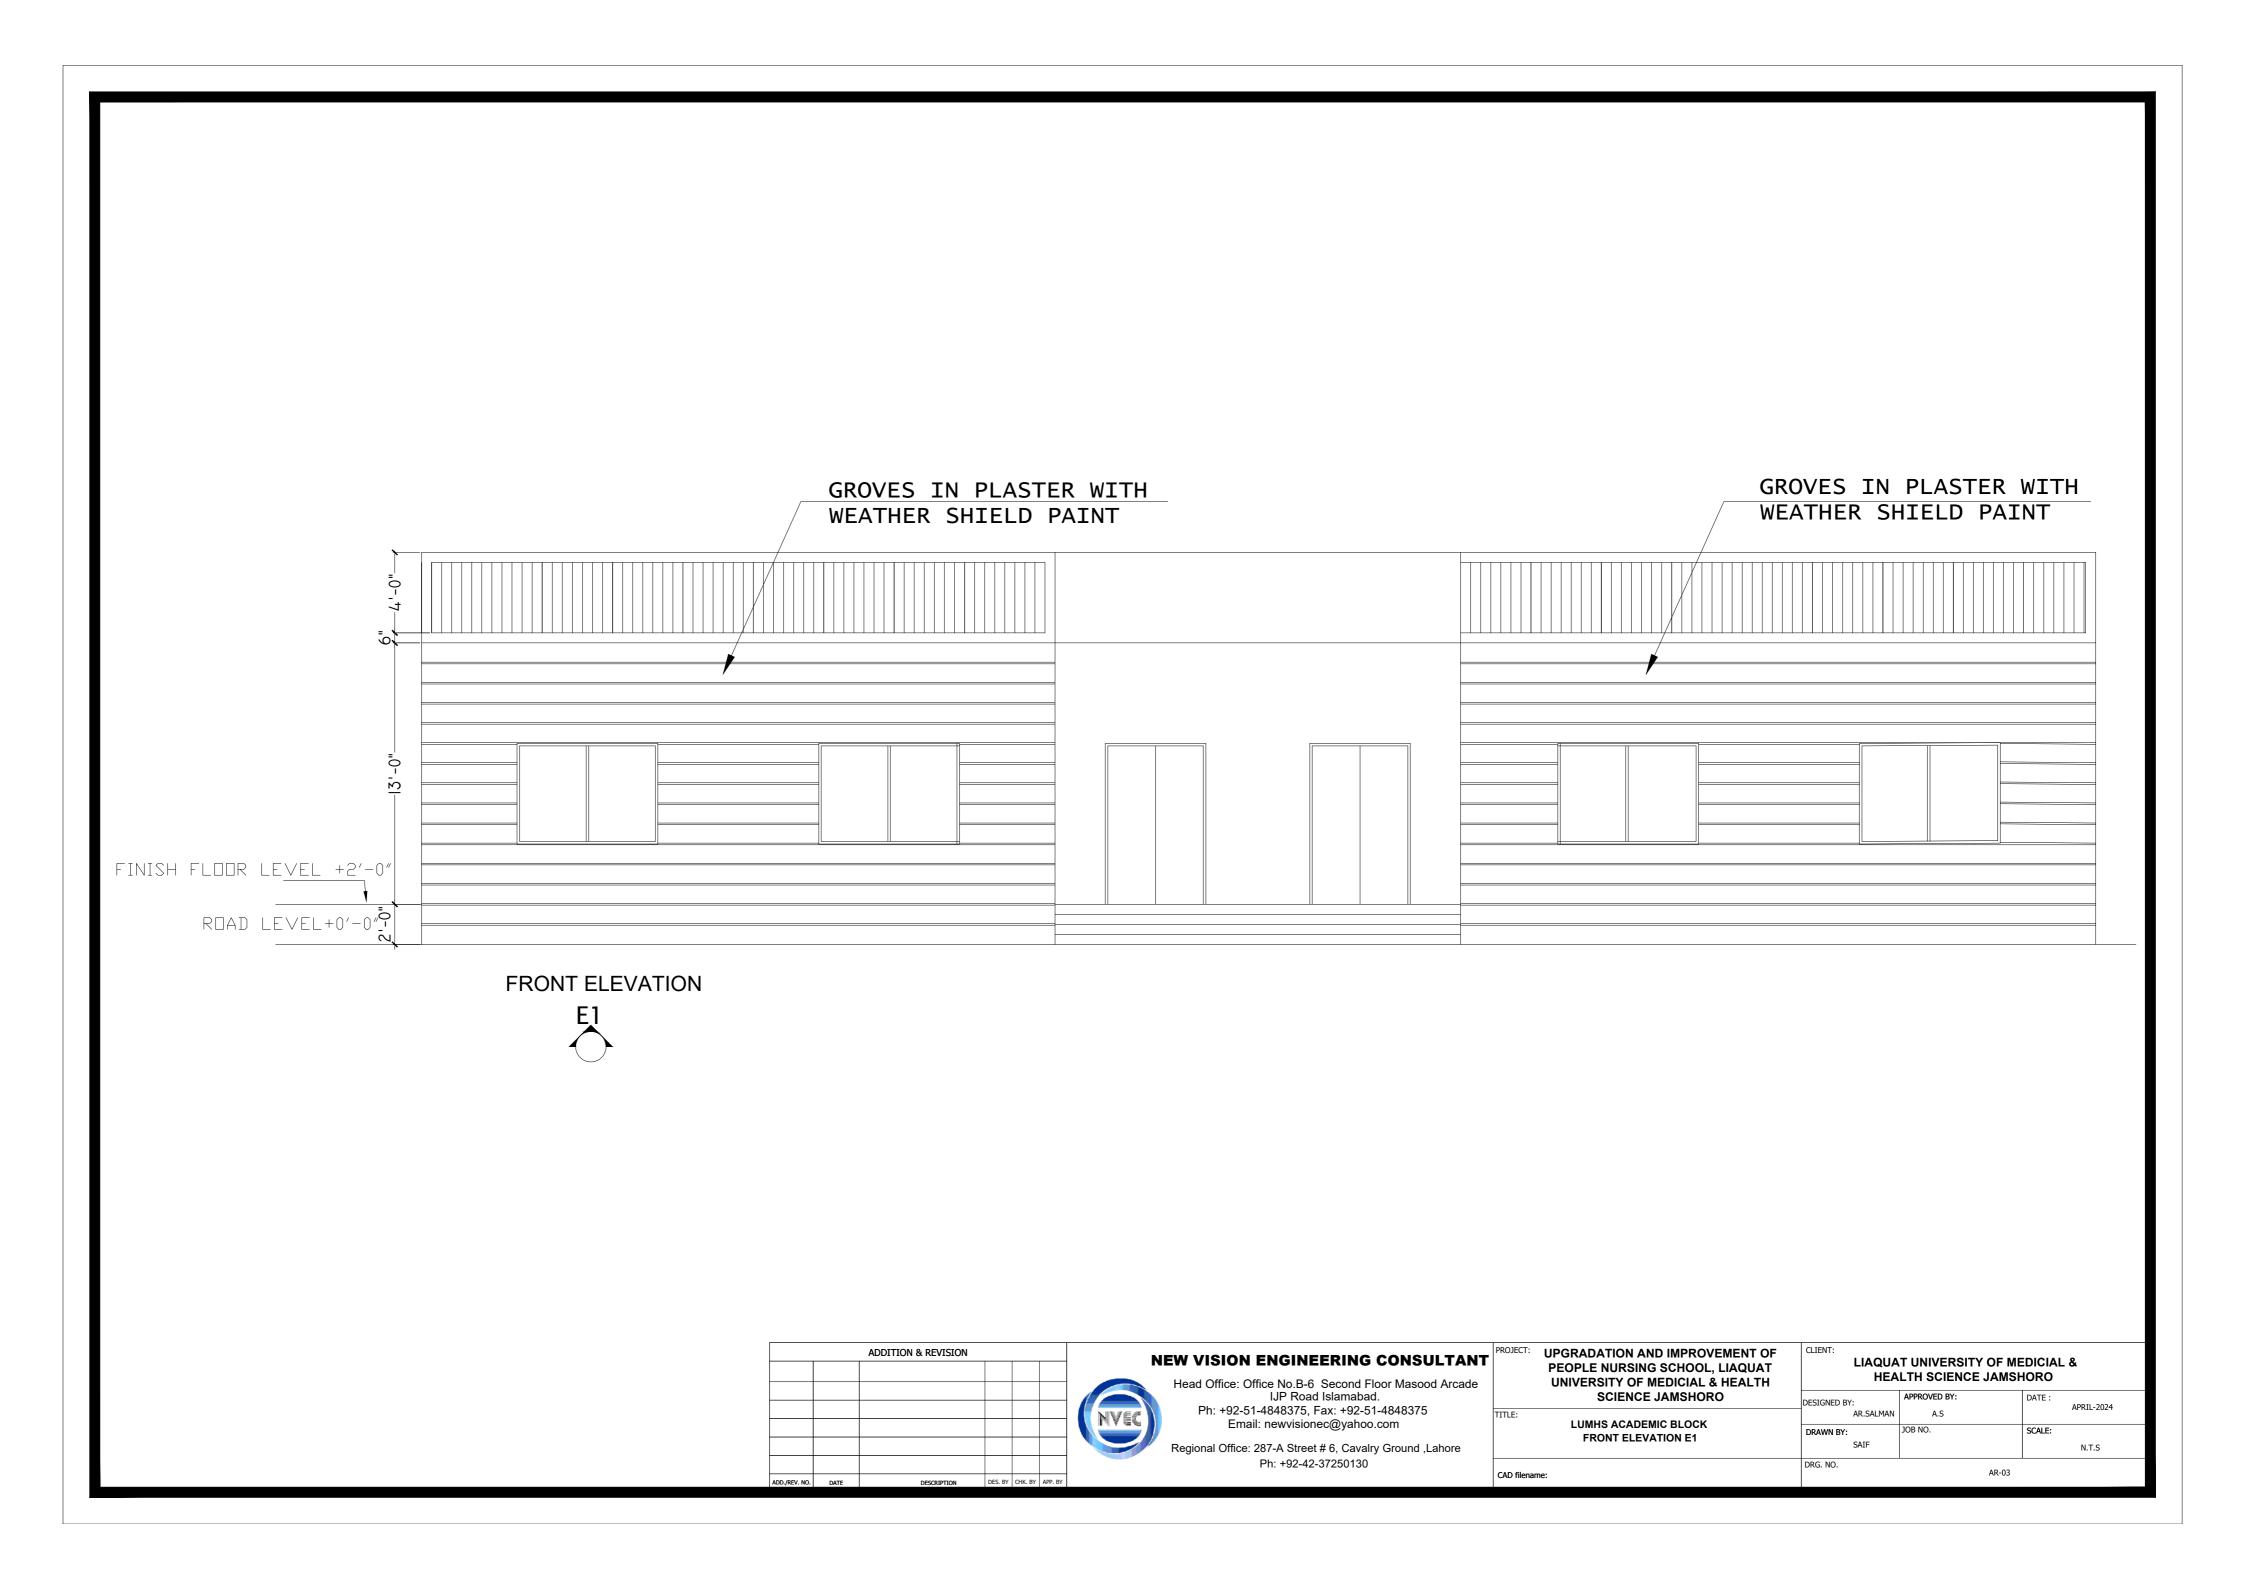
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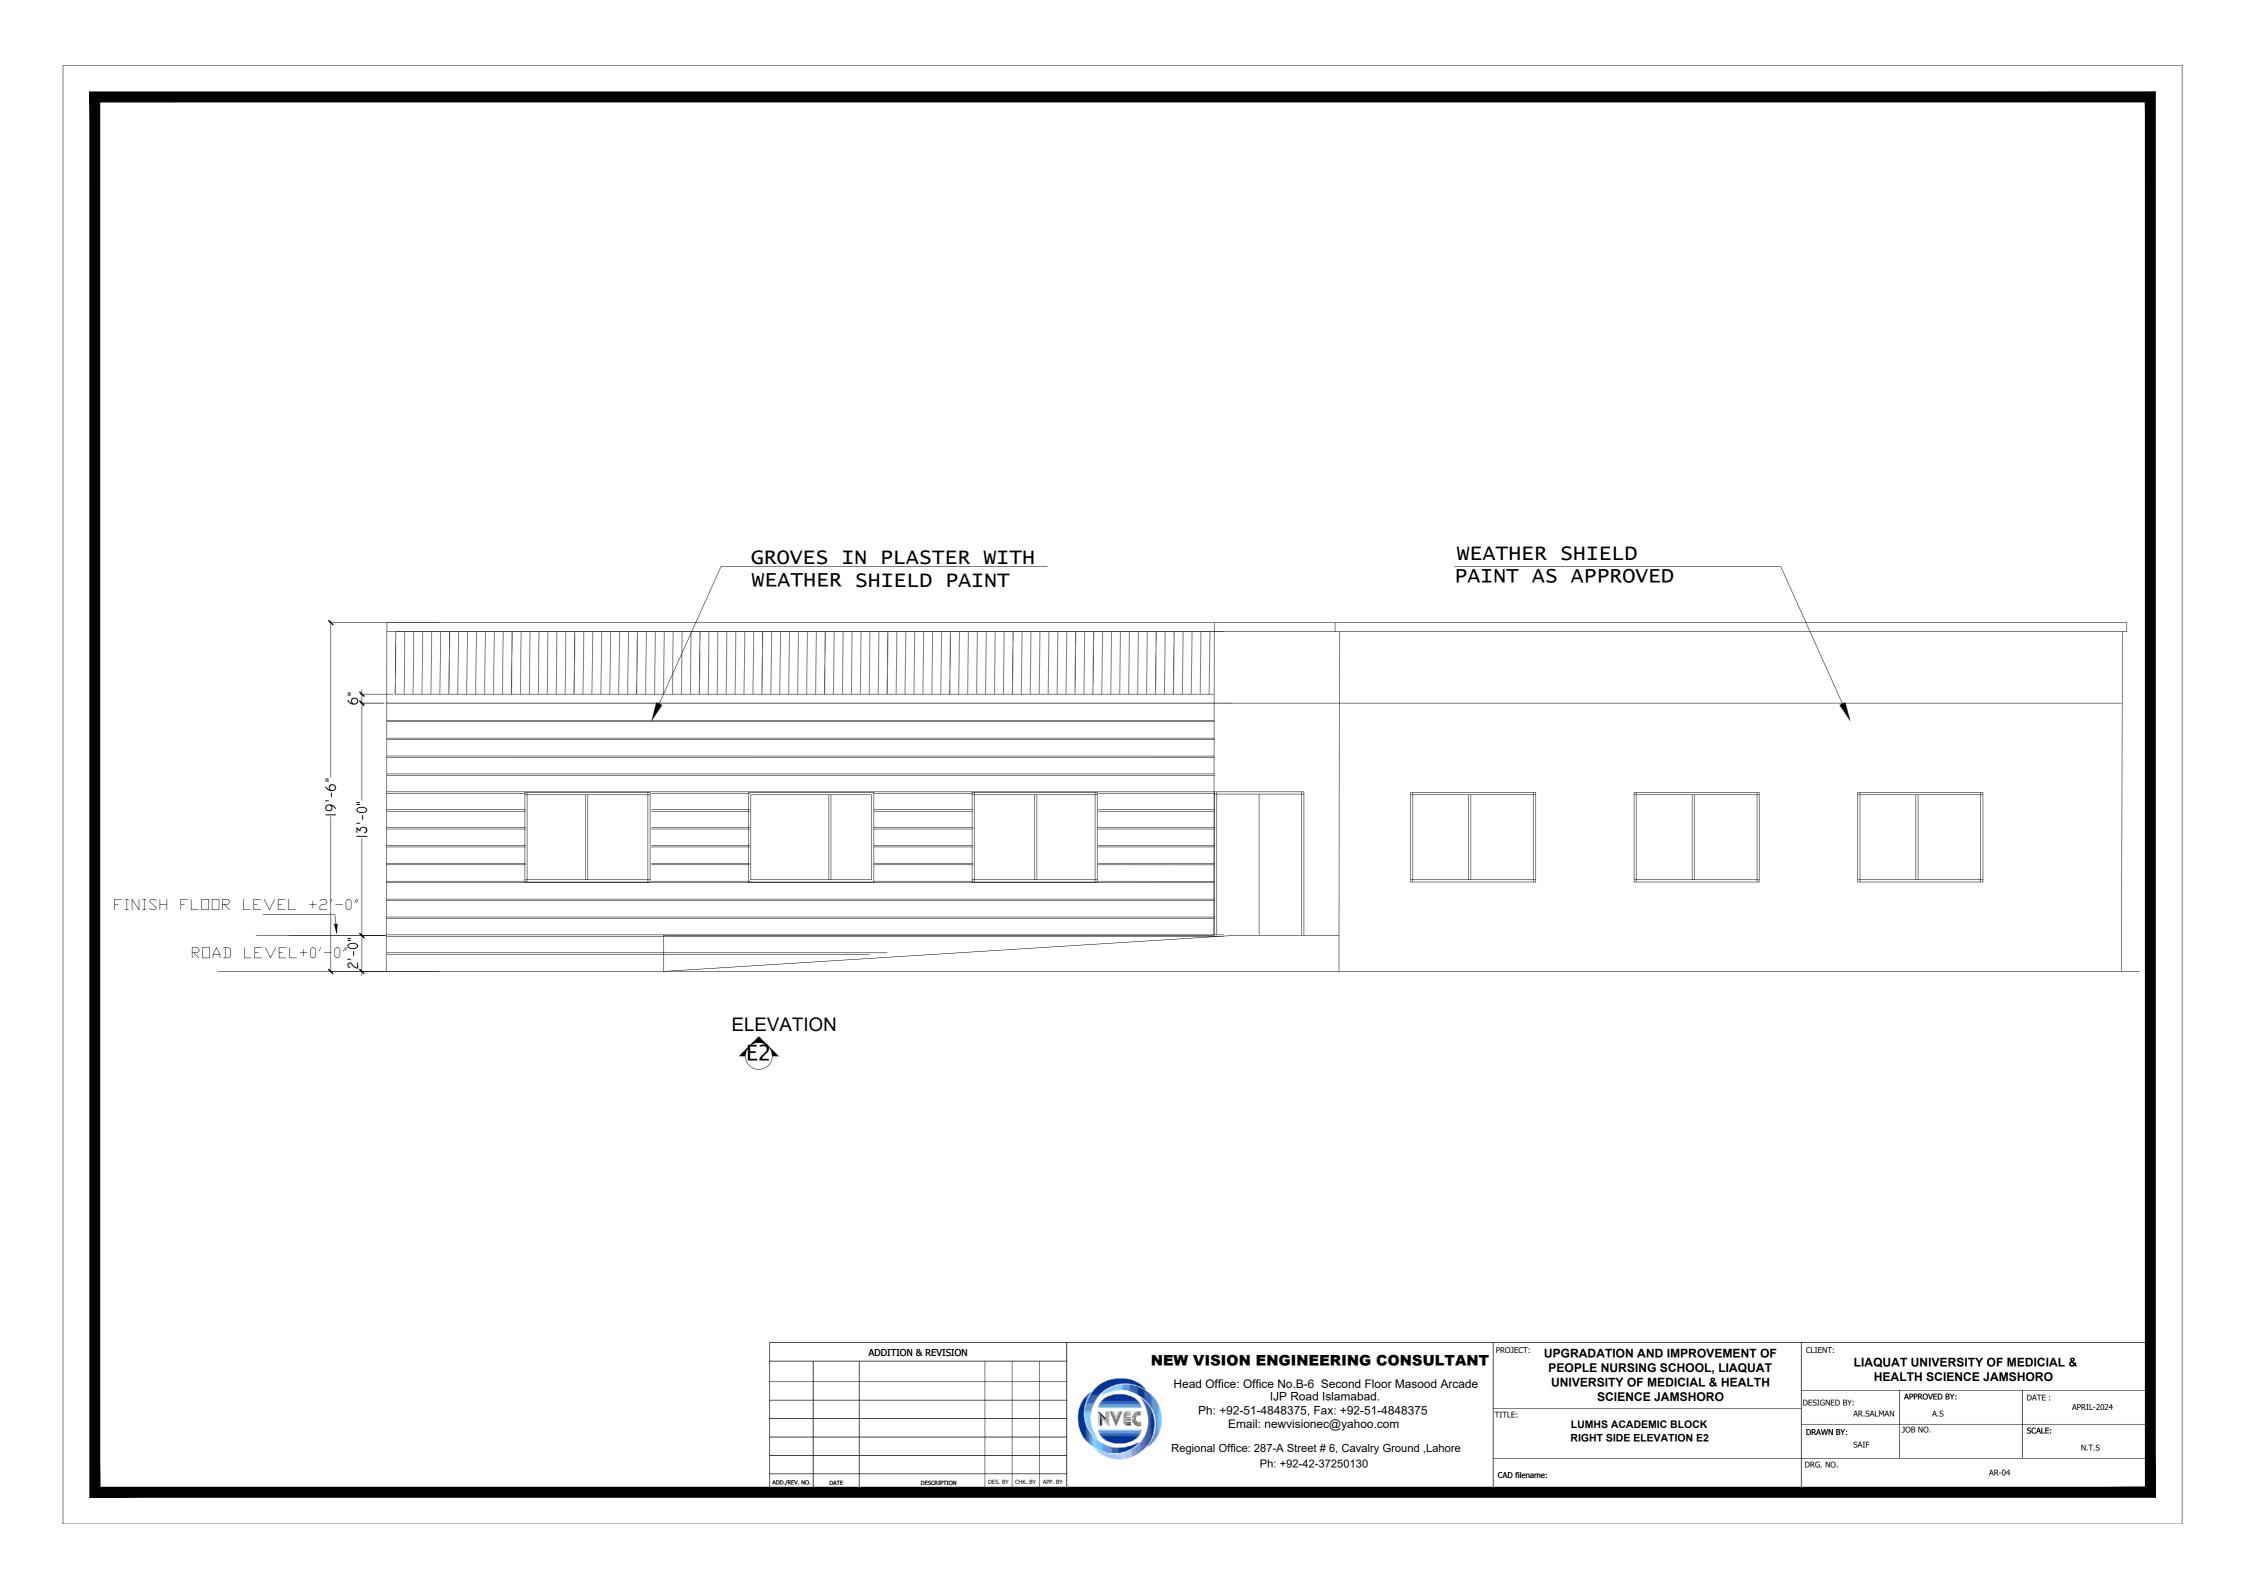
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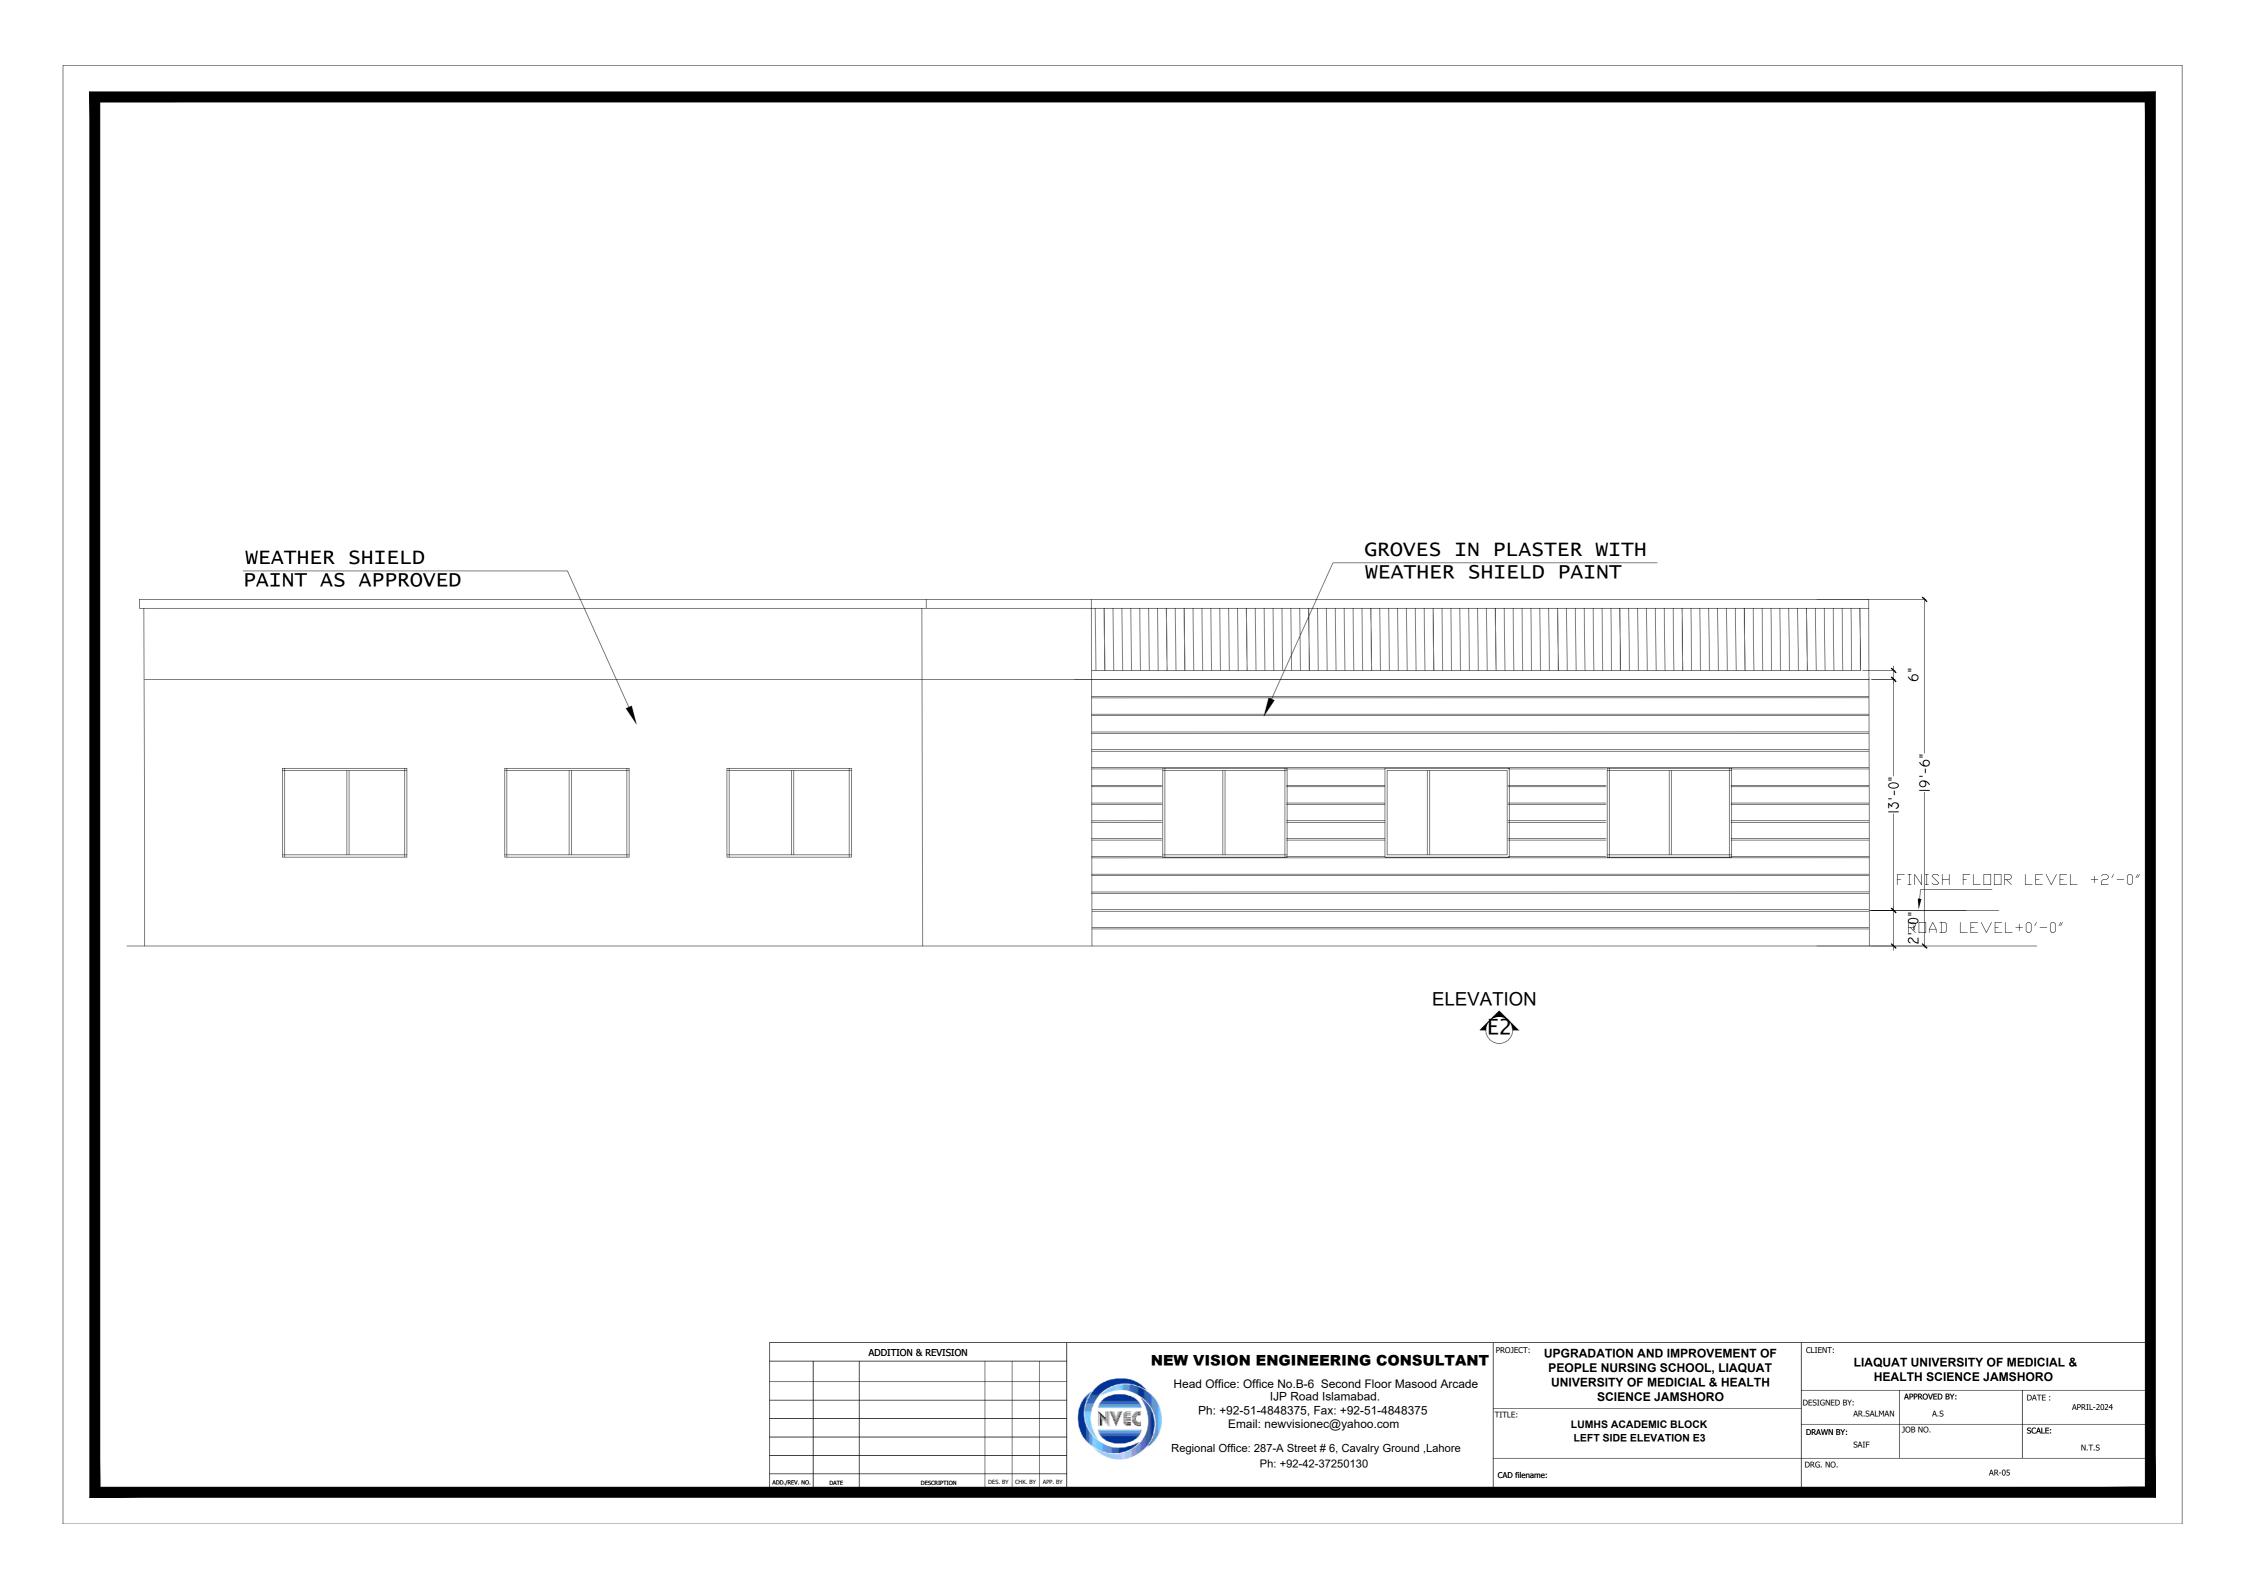
ARCHITECTURE DRAWINGS









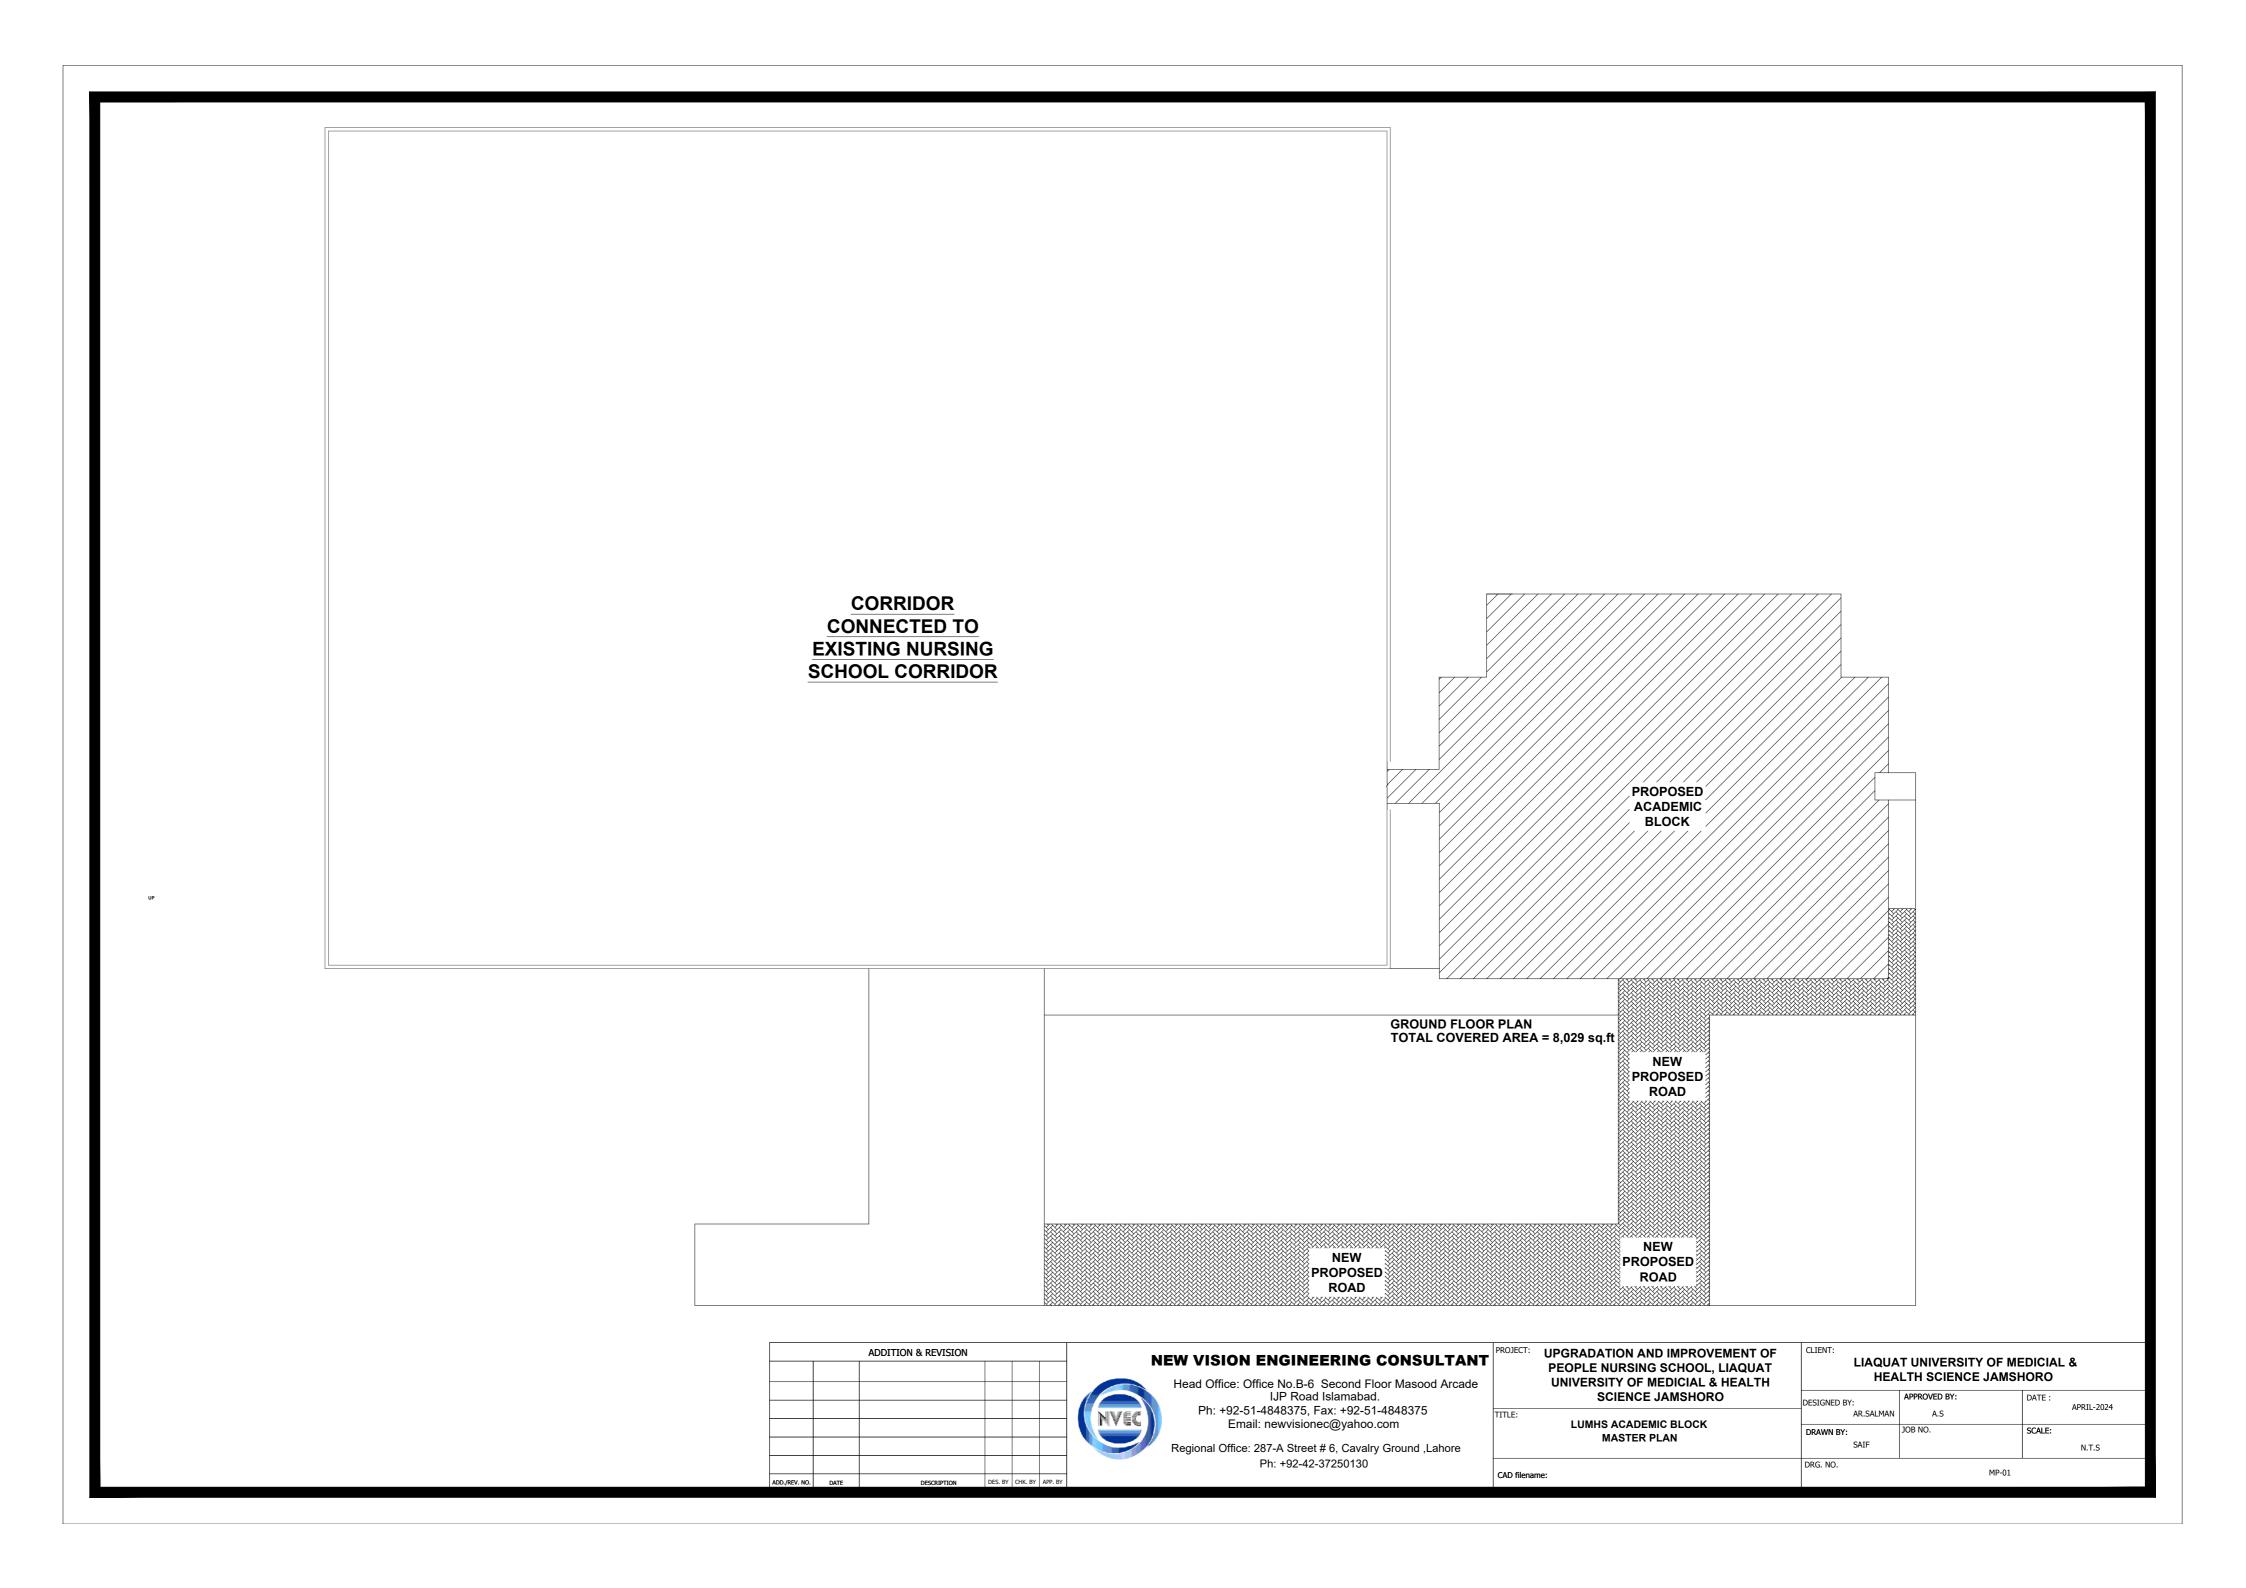



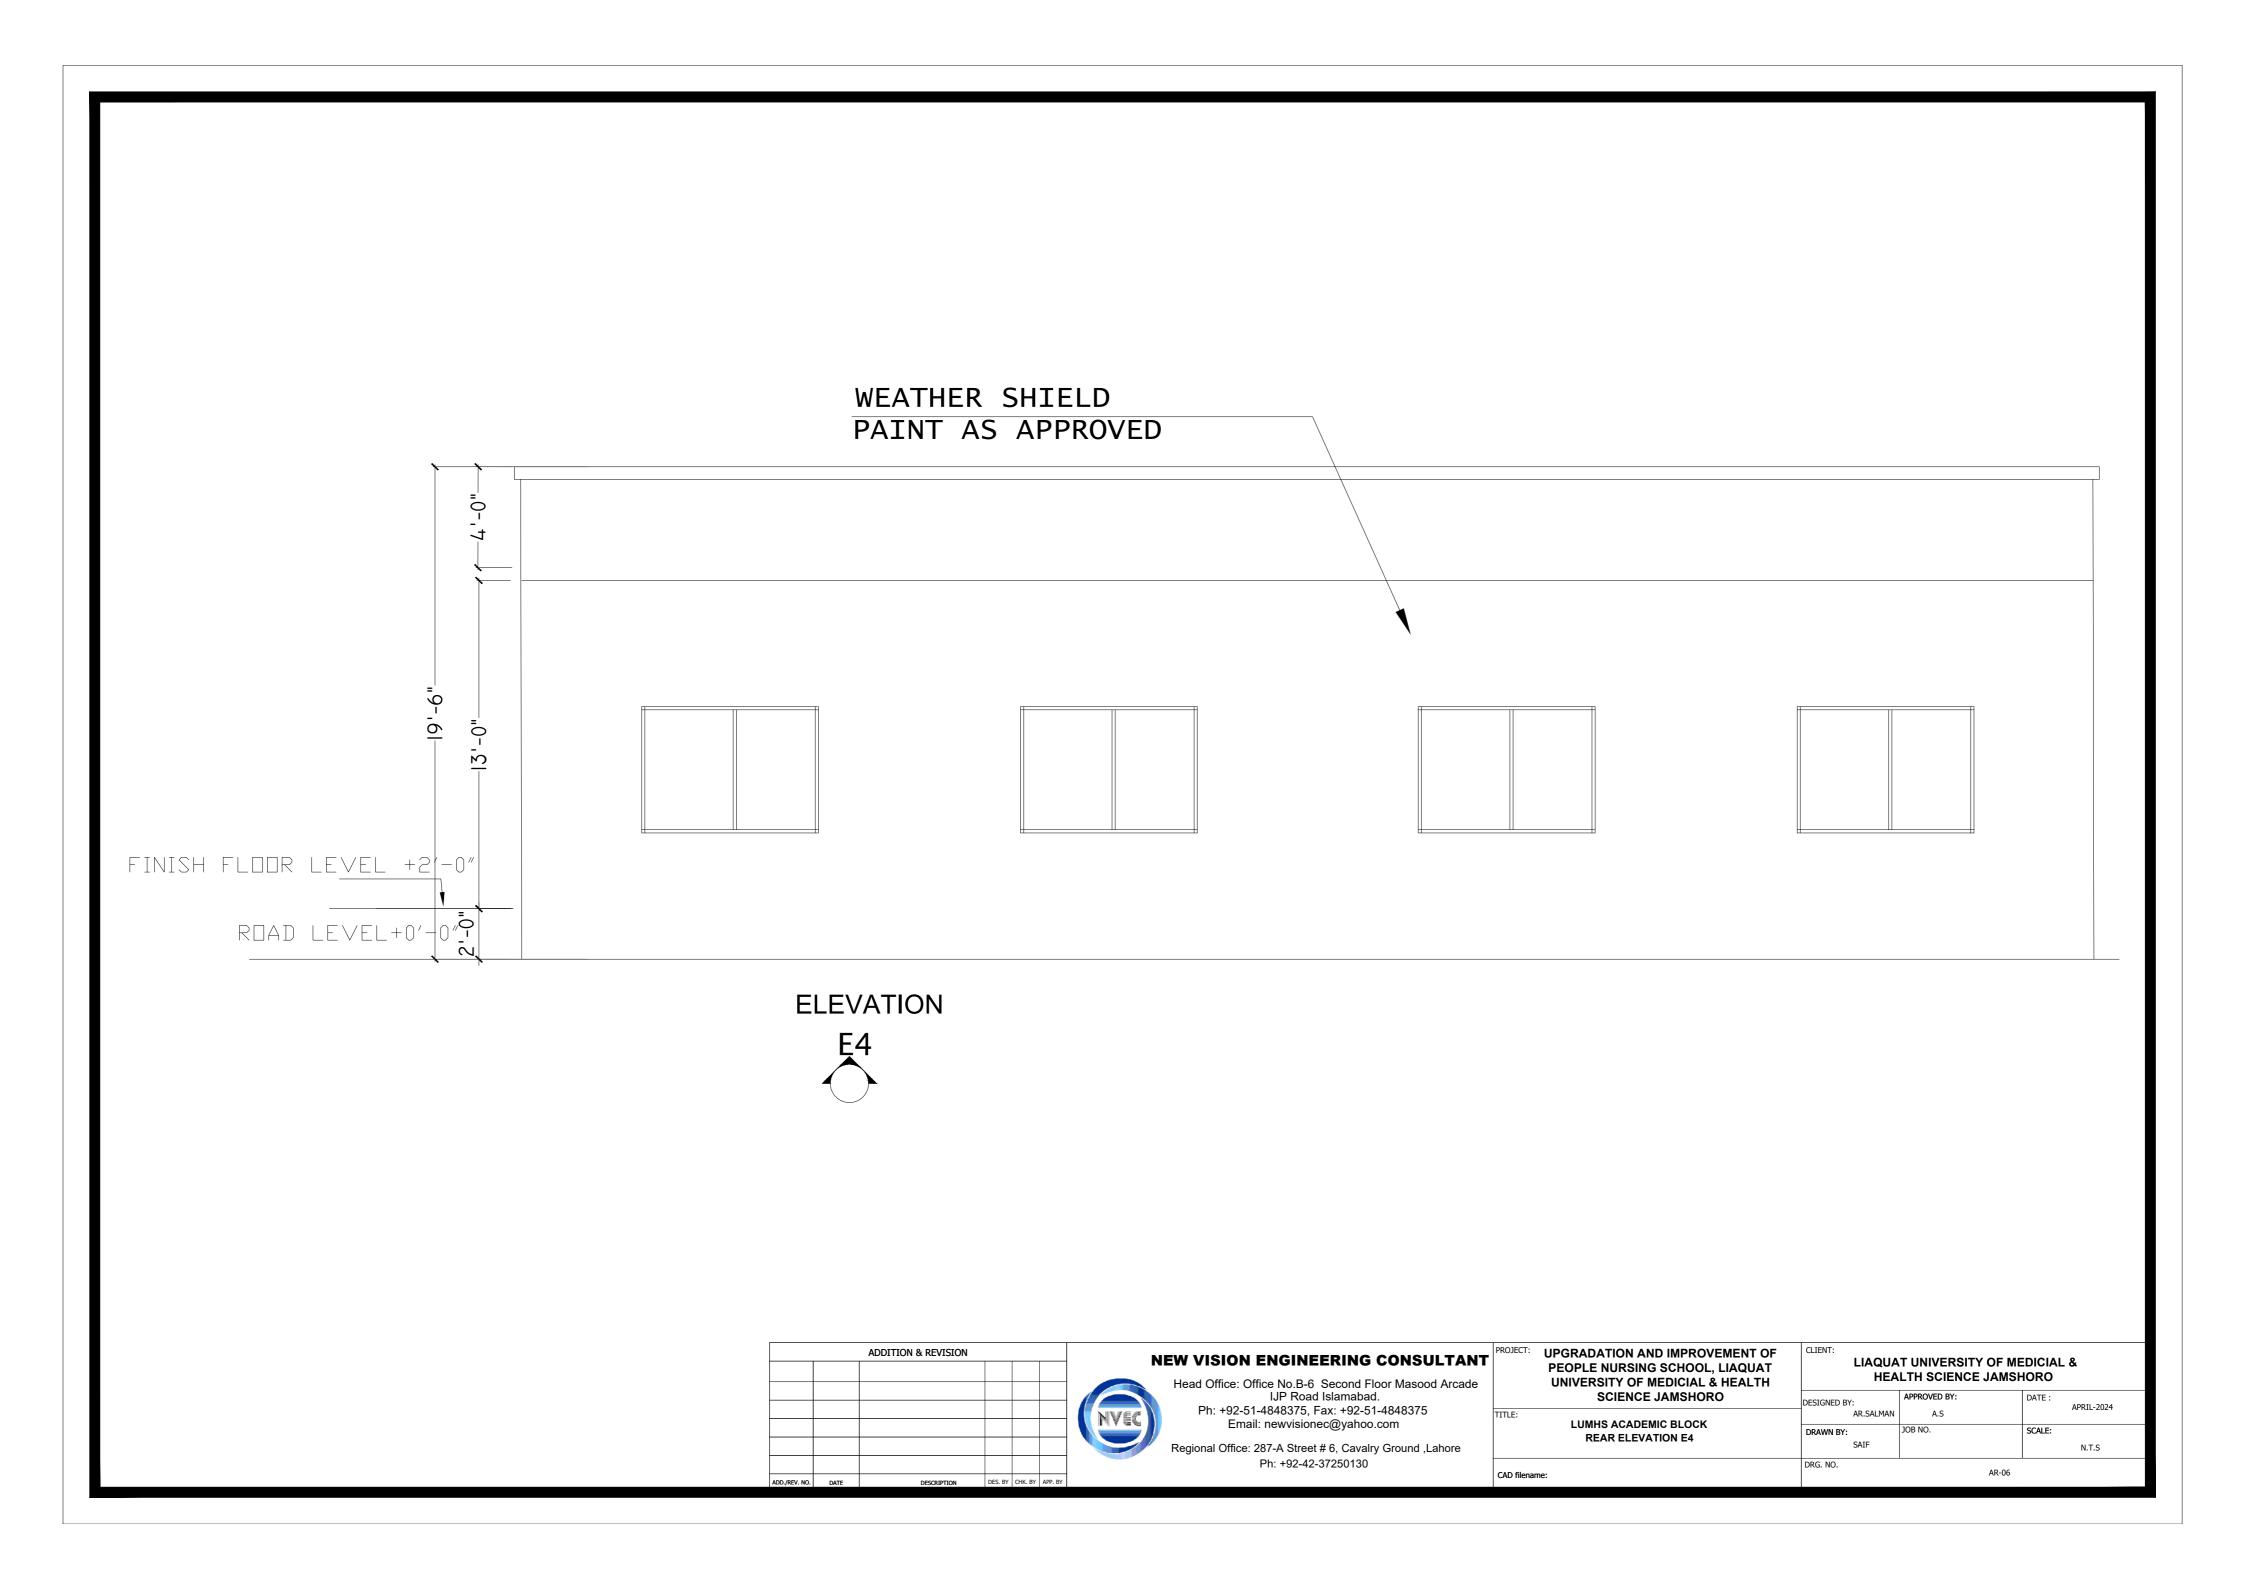

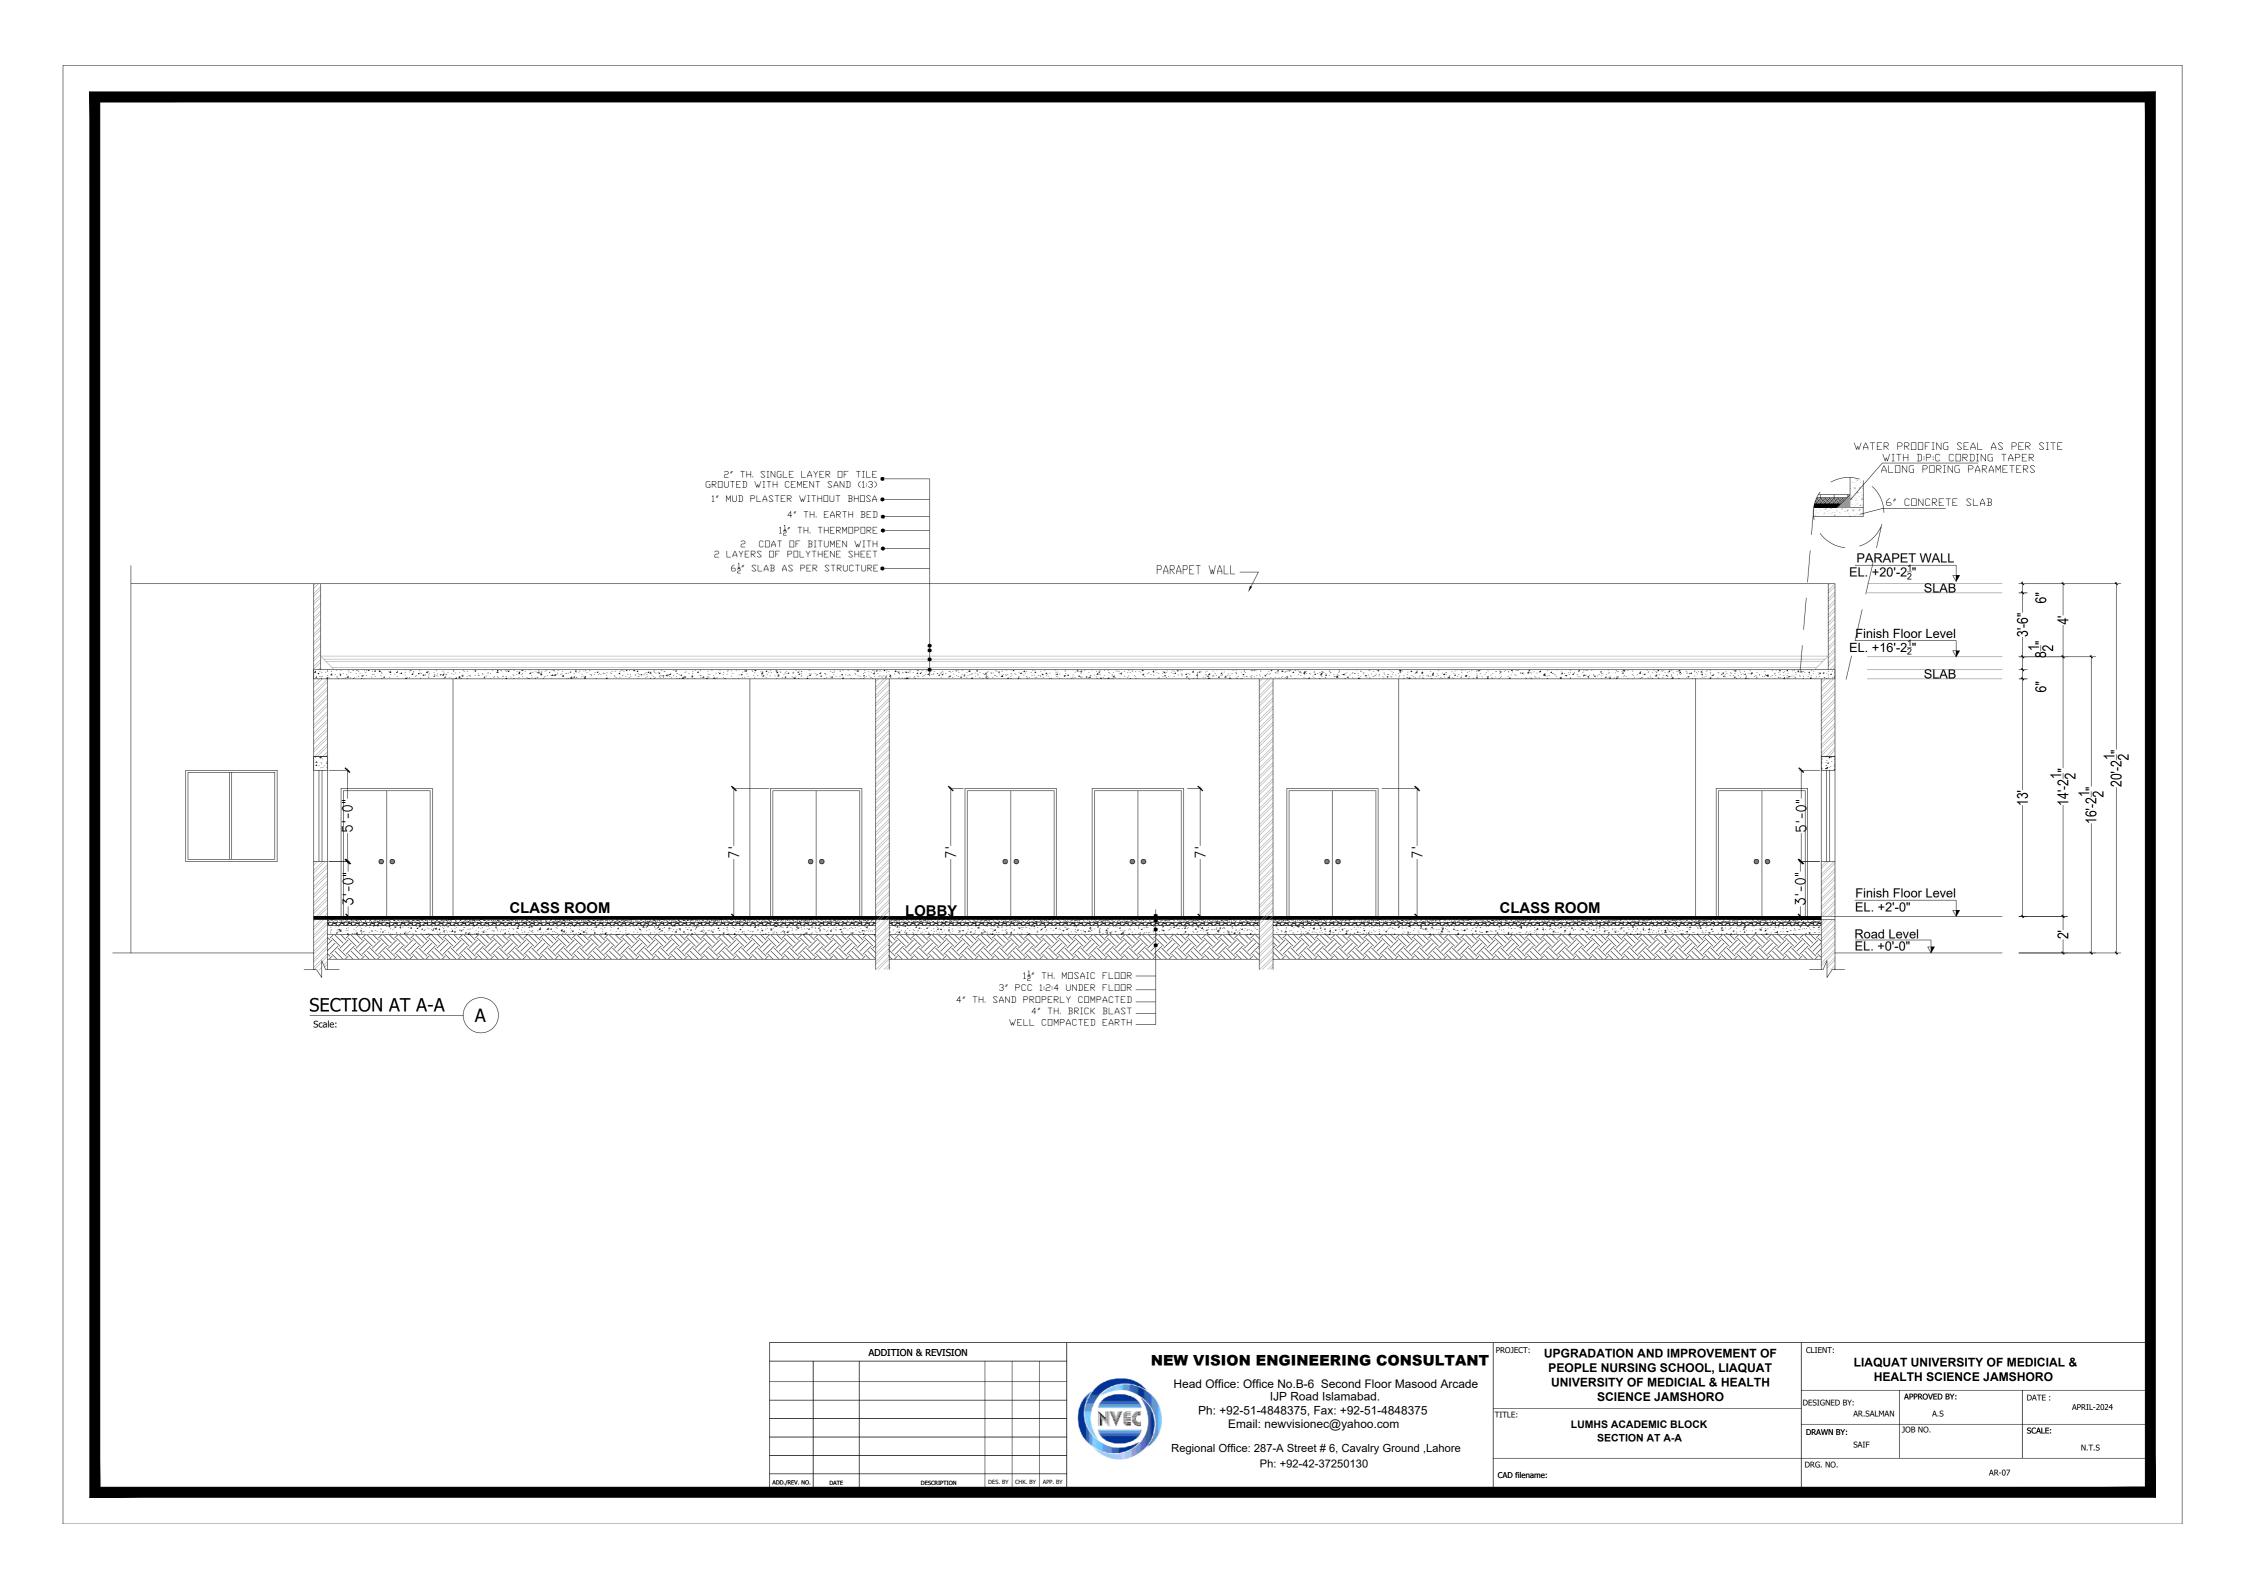

SCHEDULE OF OPENINGS

DOOR SCHEDULE

S.NO.	OPENINGS	DIMENSIONS	SILL LEVEL	DESCRIPTION
1	D1	5'-0"x8'-0"	0'-0"	SOLID DOOR
2	D2	5'-0"X8'-0"	0'-0"	FIRE RATED EMGERGENCY EXIT DOOR
3	D3	5'-0"X7'-0"	0'-0"	SOLID FLUSH DOOR

WINDOW SCHEDULE

12	W1	7'-0"X5'-0"	+3'-0"	ALUMINUM WINDOW
13	W2	5'-0"X5'-0"	+3'-0"	ALUMINUM WINDOW


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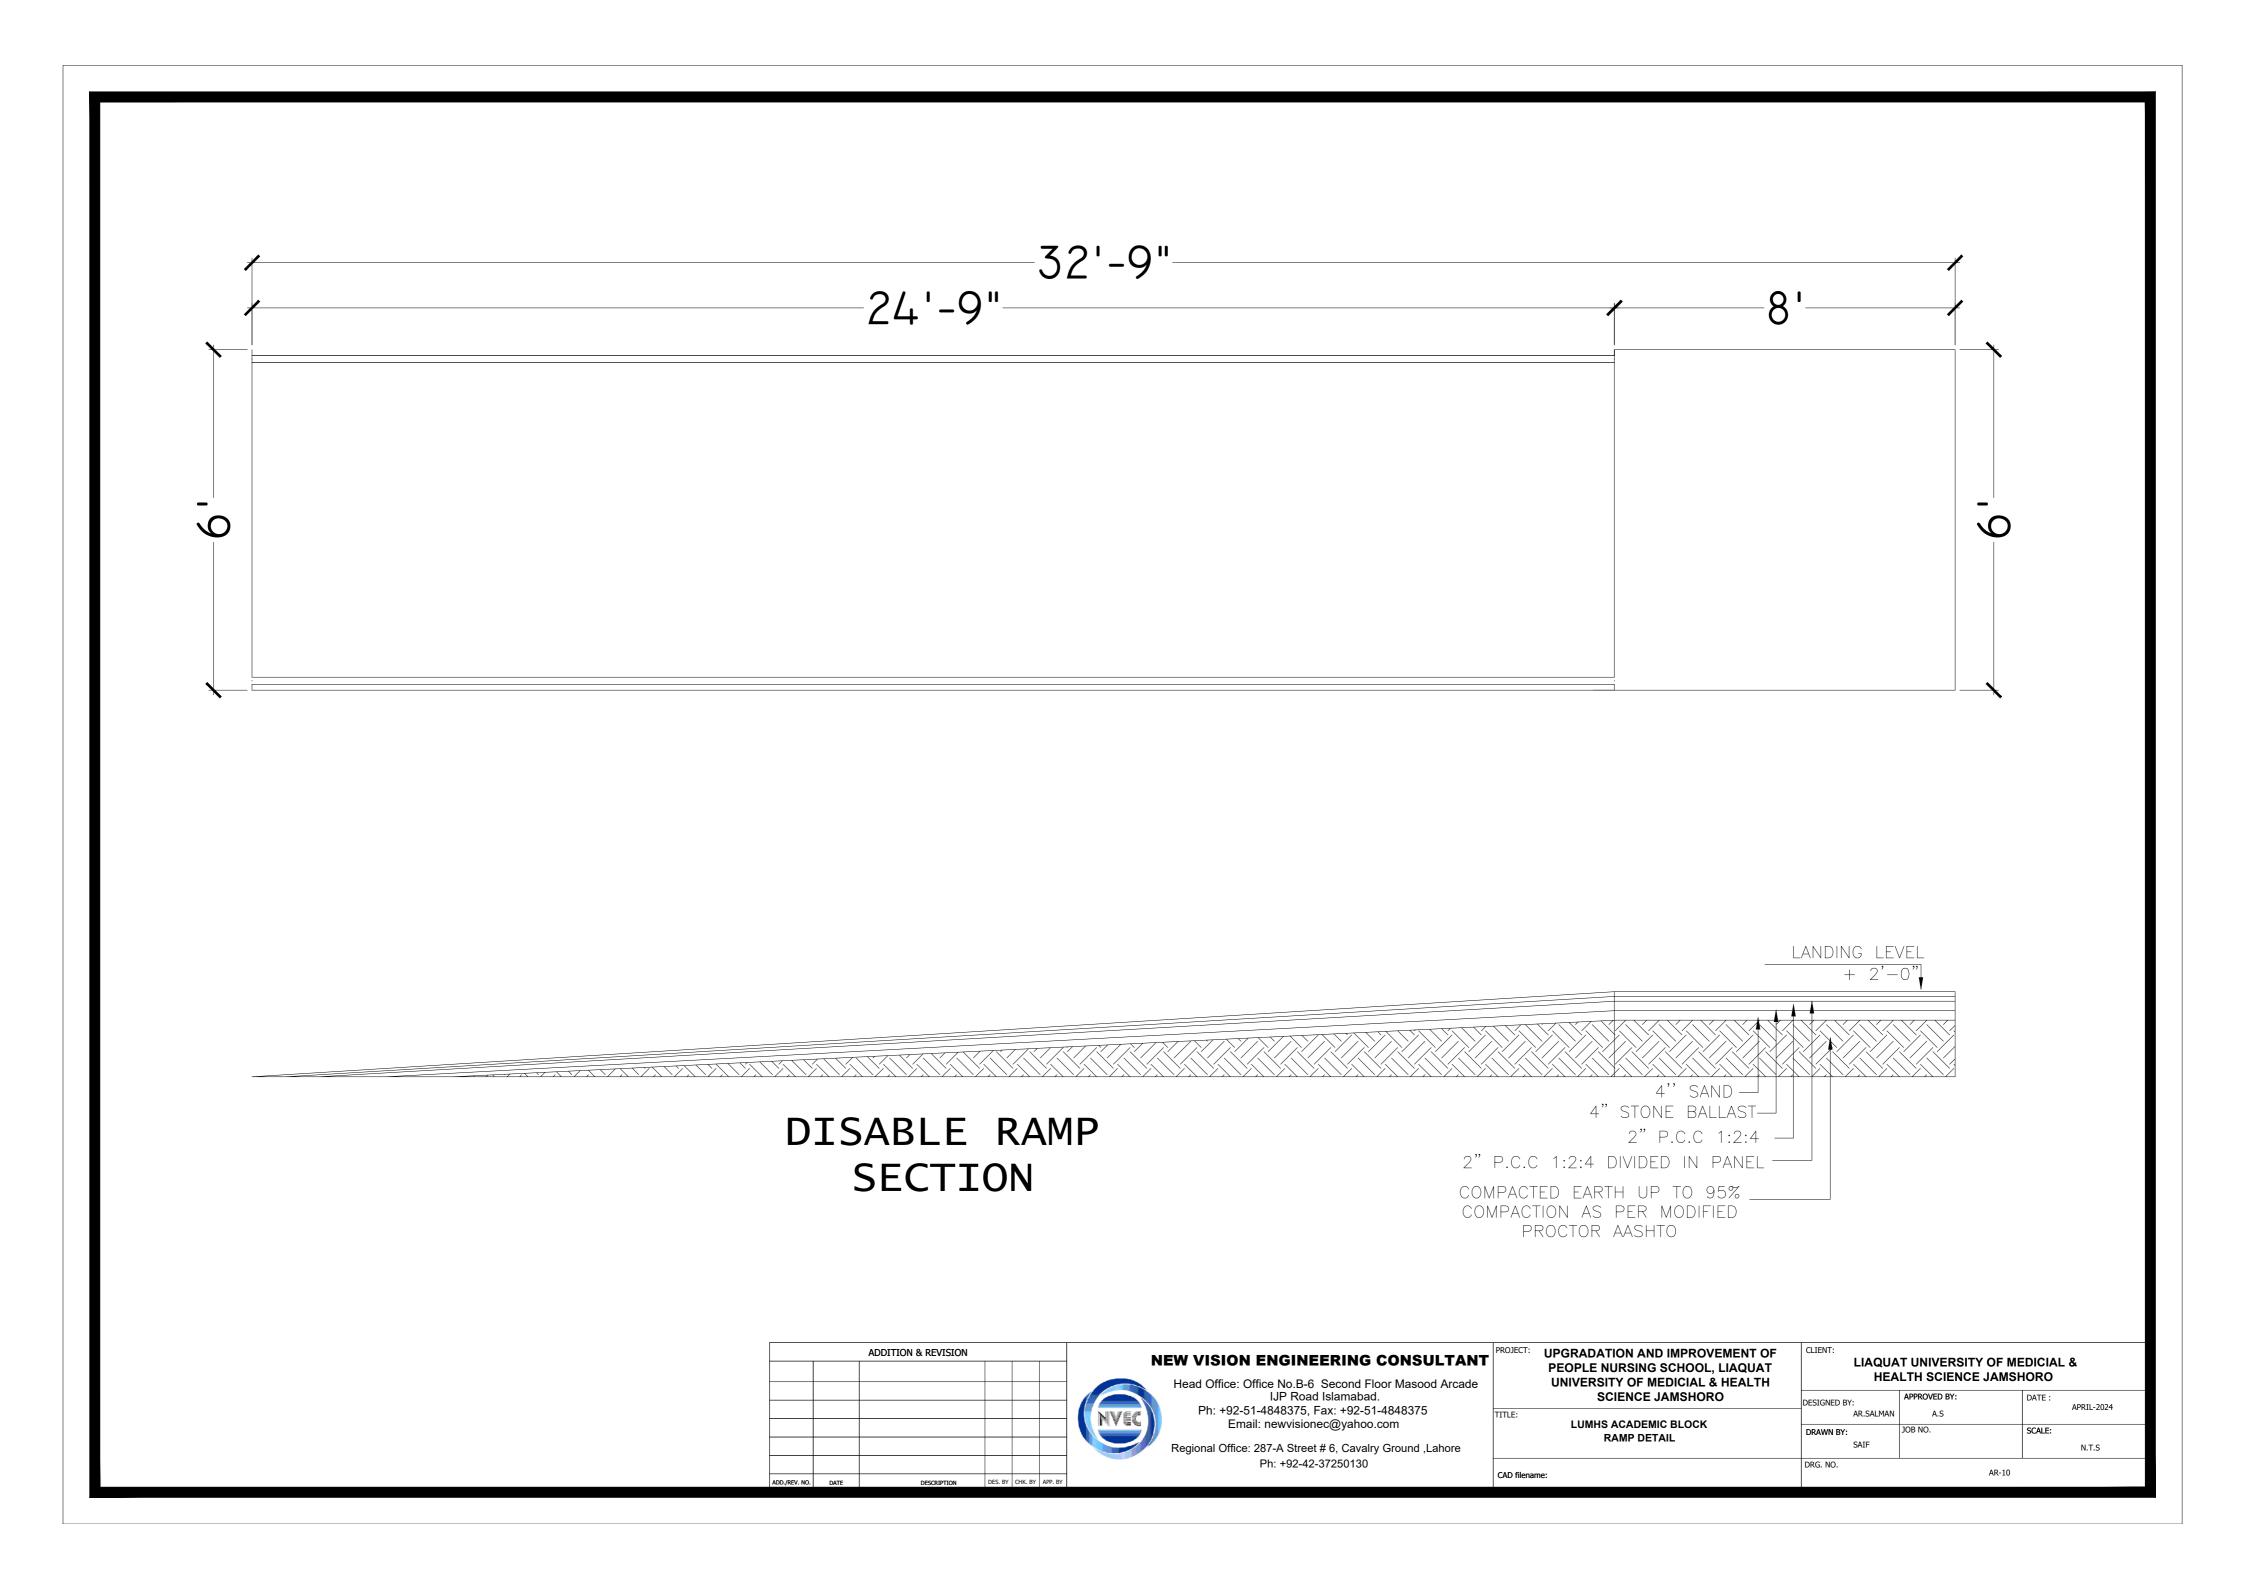
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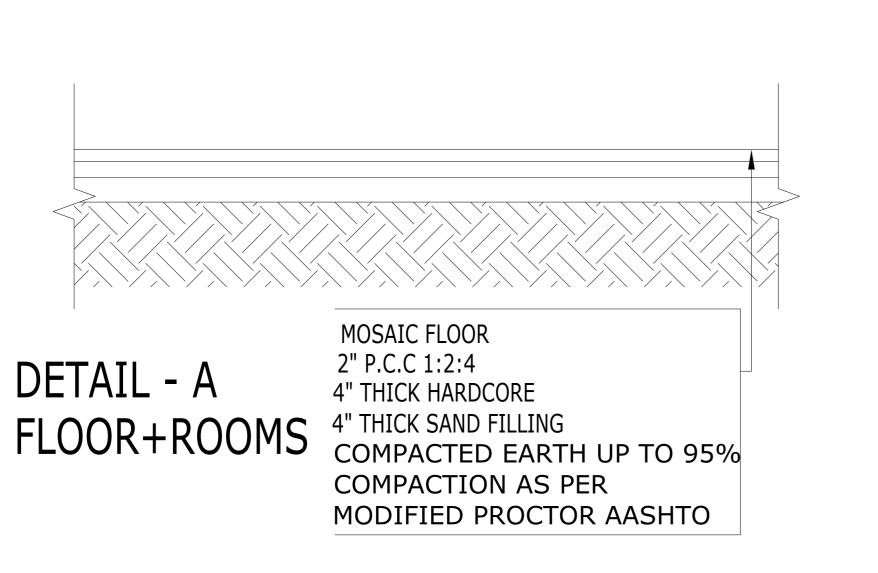
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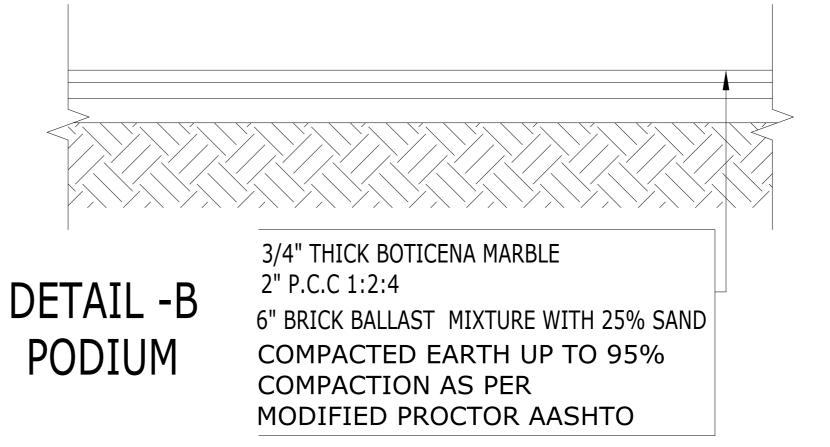
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Ph: +92-42-37250130	

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	SCIENCE JAMSHORO	DESIGNED BY: AR.SALMAN	APPROVED BY: A.S	DATE : APRIL-2024			
	LUMHS ACADEMIC BLOCK SCHEDULE OF OPENINGS	DRAWN BY: SAIF	JOB NO.	SCALE: N.T.S			
	CAD filename:	DRG. NO.	AR-08				







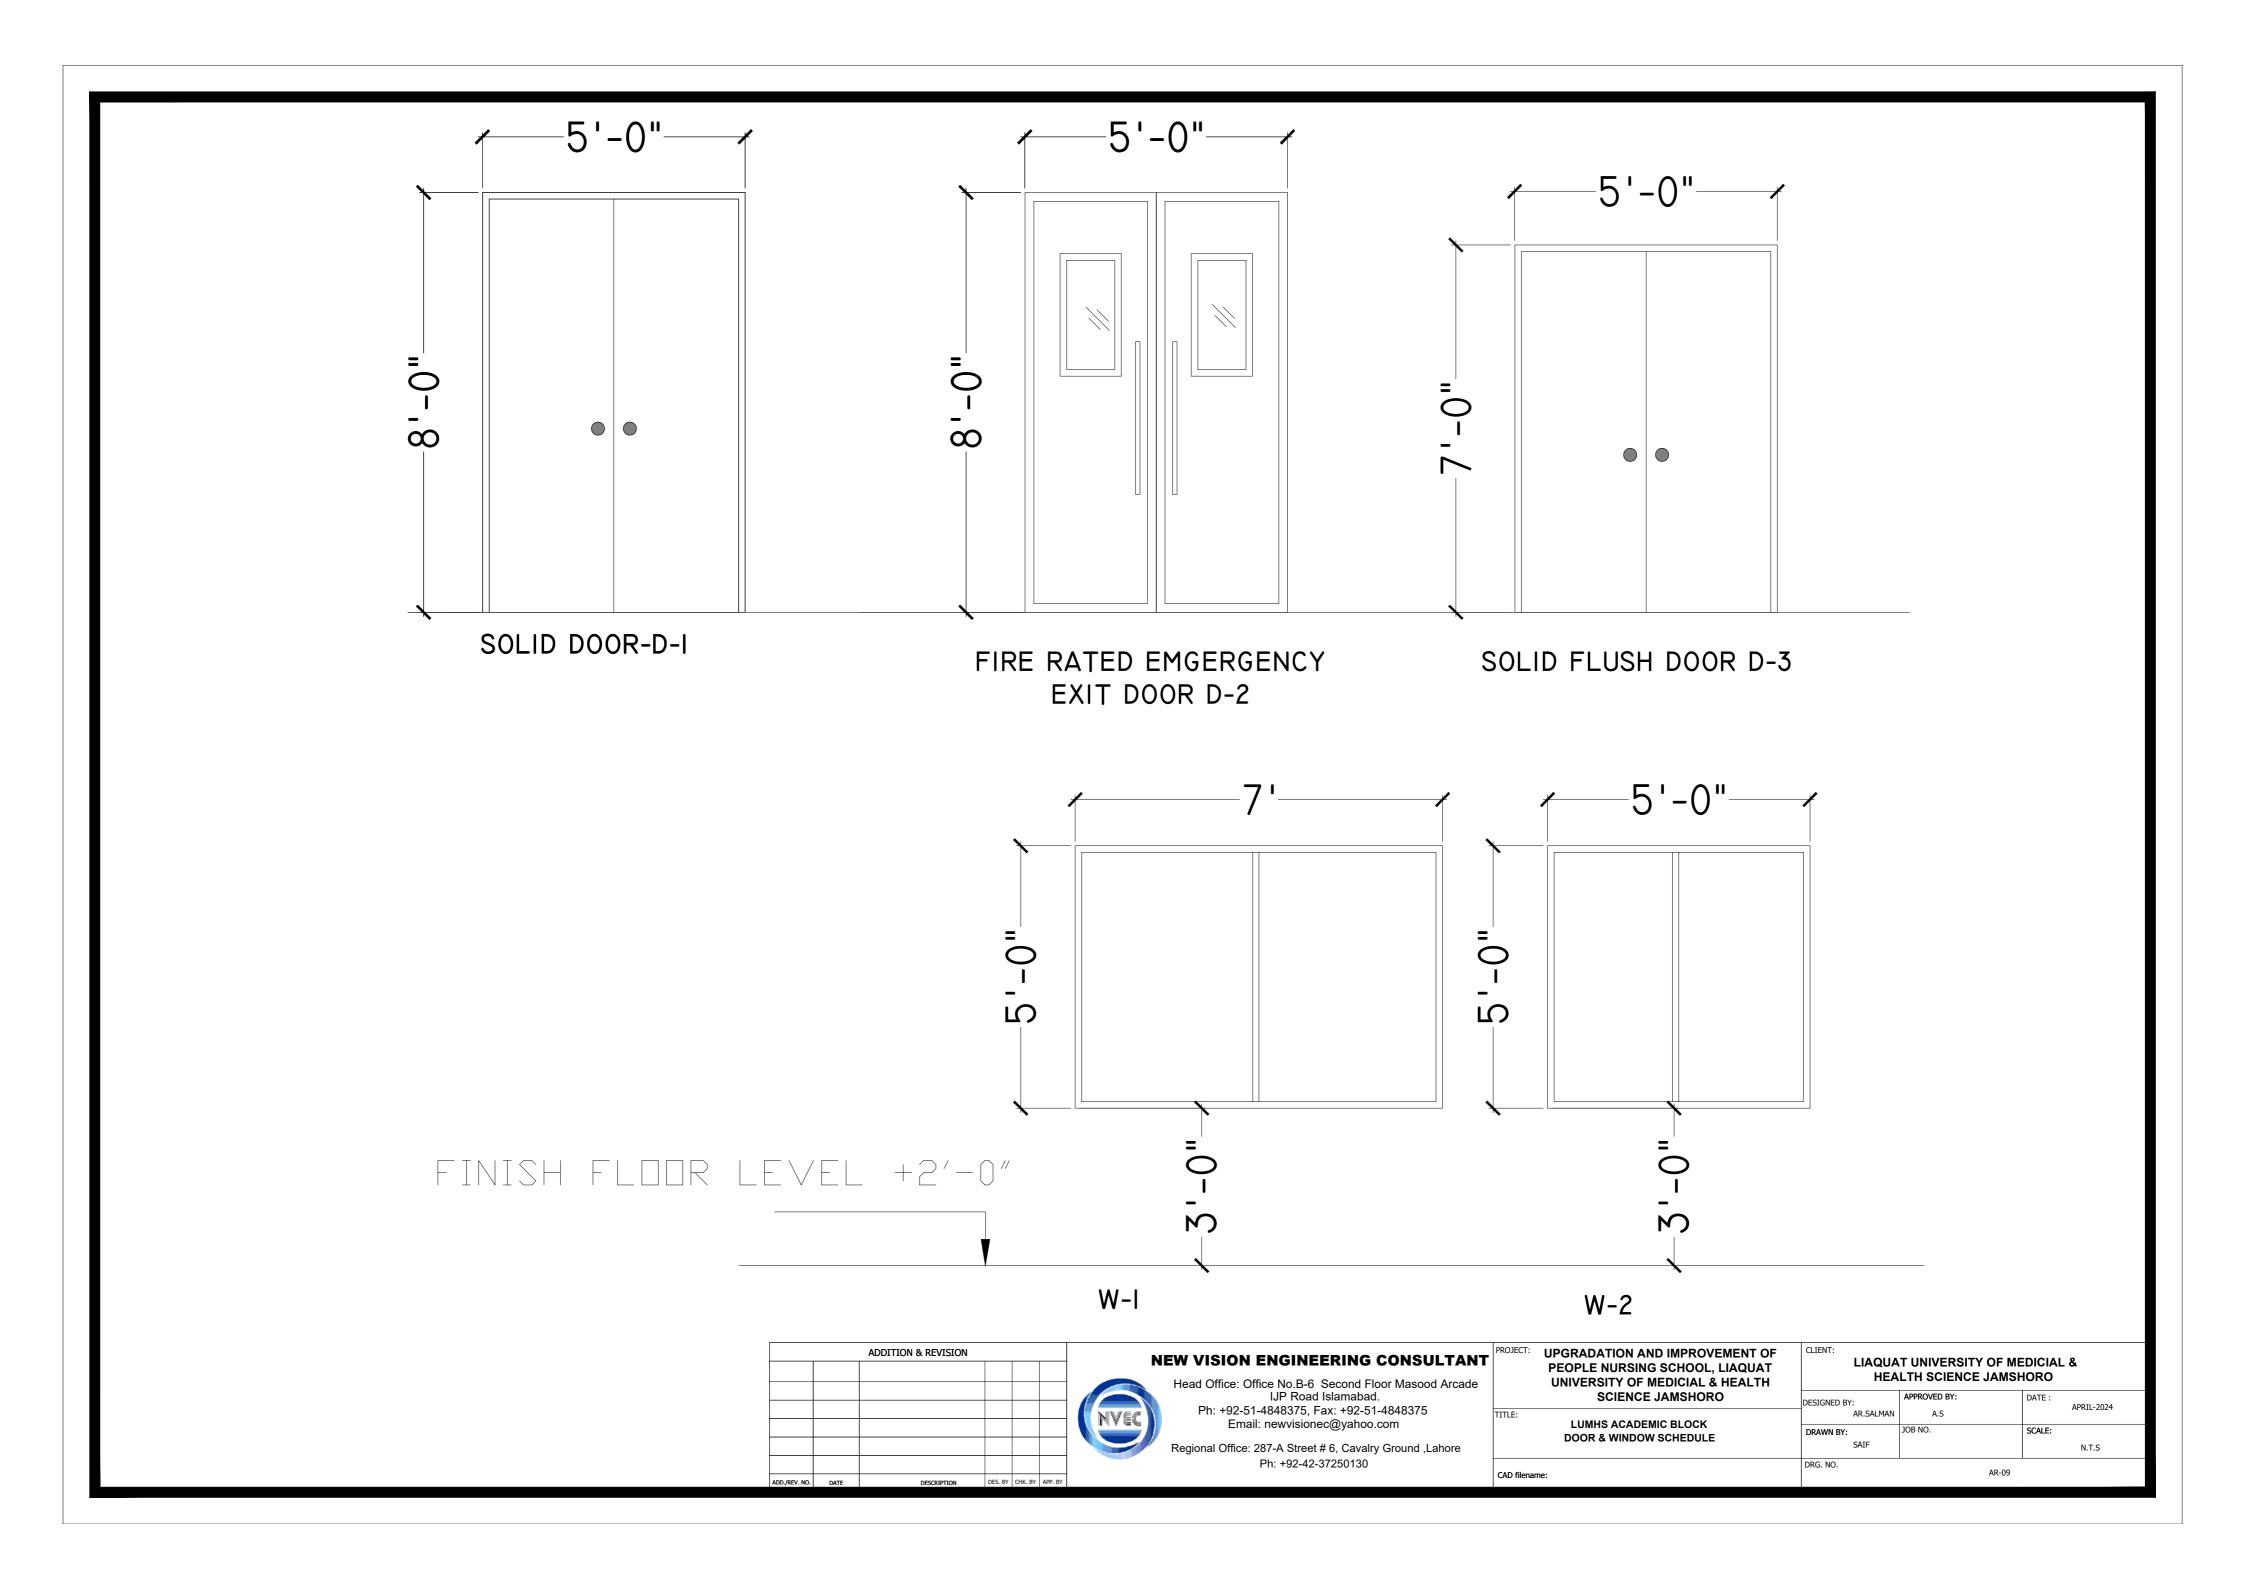

DETAIL - C ROOF

9"x4½"x1½" THICK TILE FLOORING 4" EARTH FILLING PUDLED 11/2" THERMOPORE SHEET TOW LAYER OF POLYTHENE SHEET 500 SWG BITUMEN LAYER R.C.C SLAB

APRIL-2024

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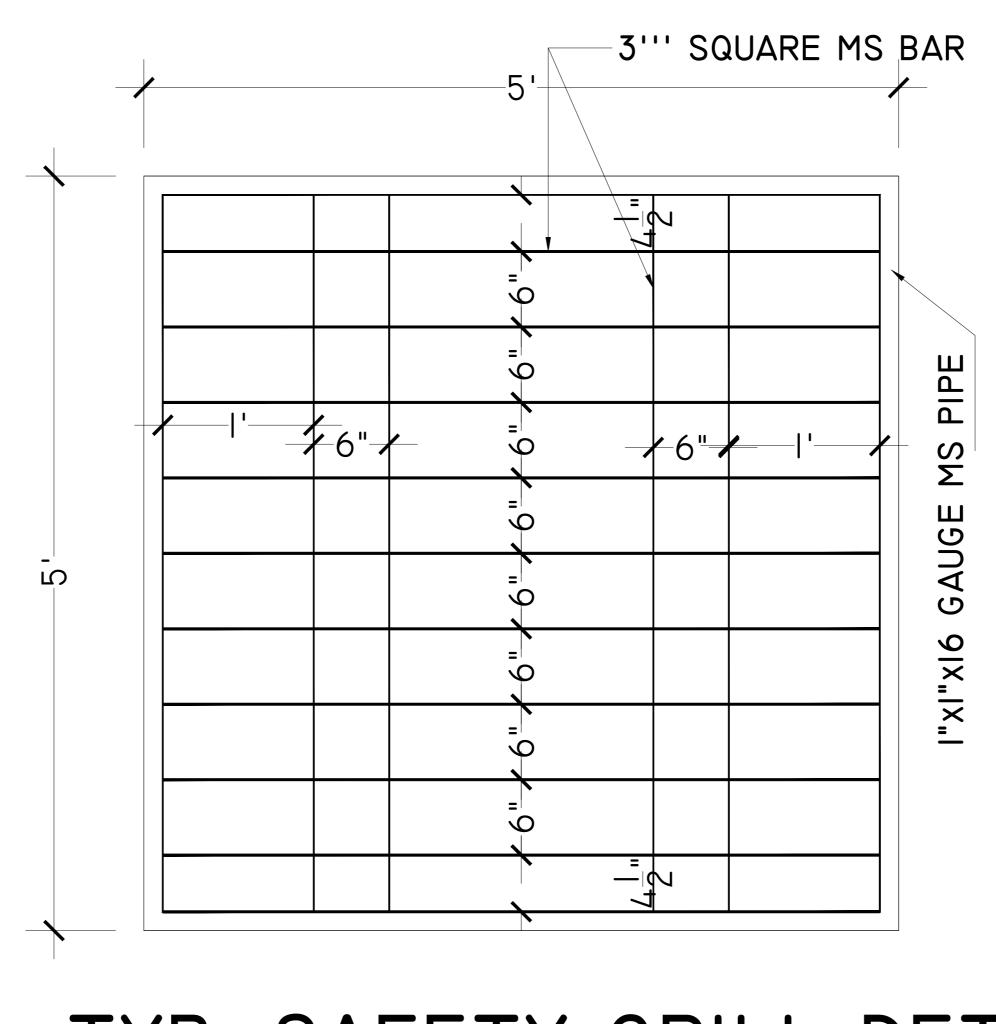
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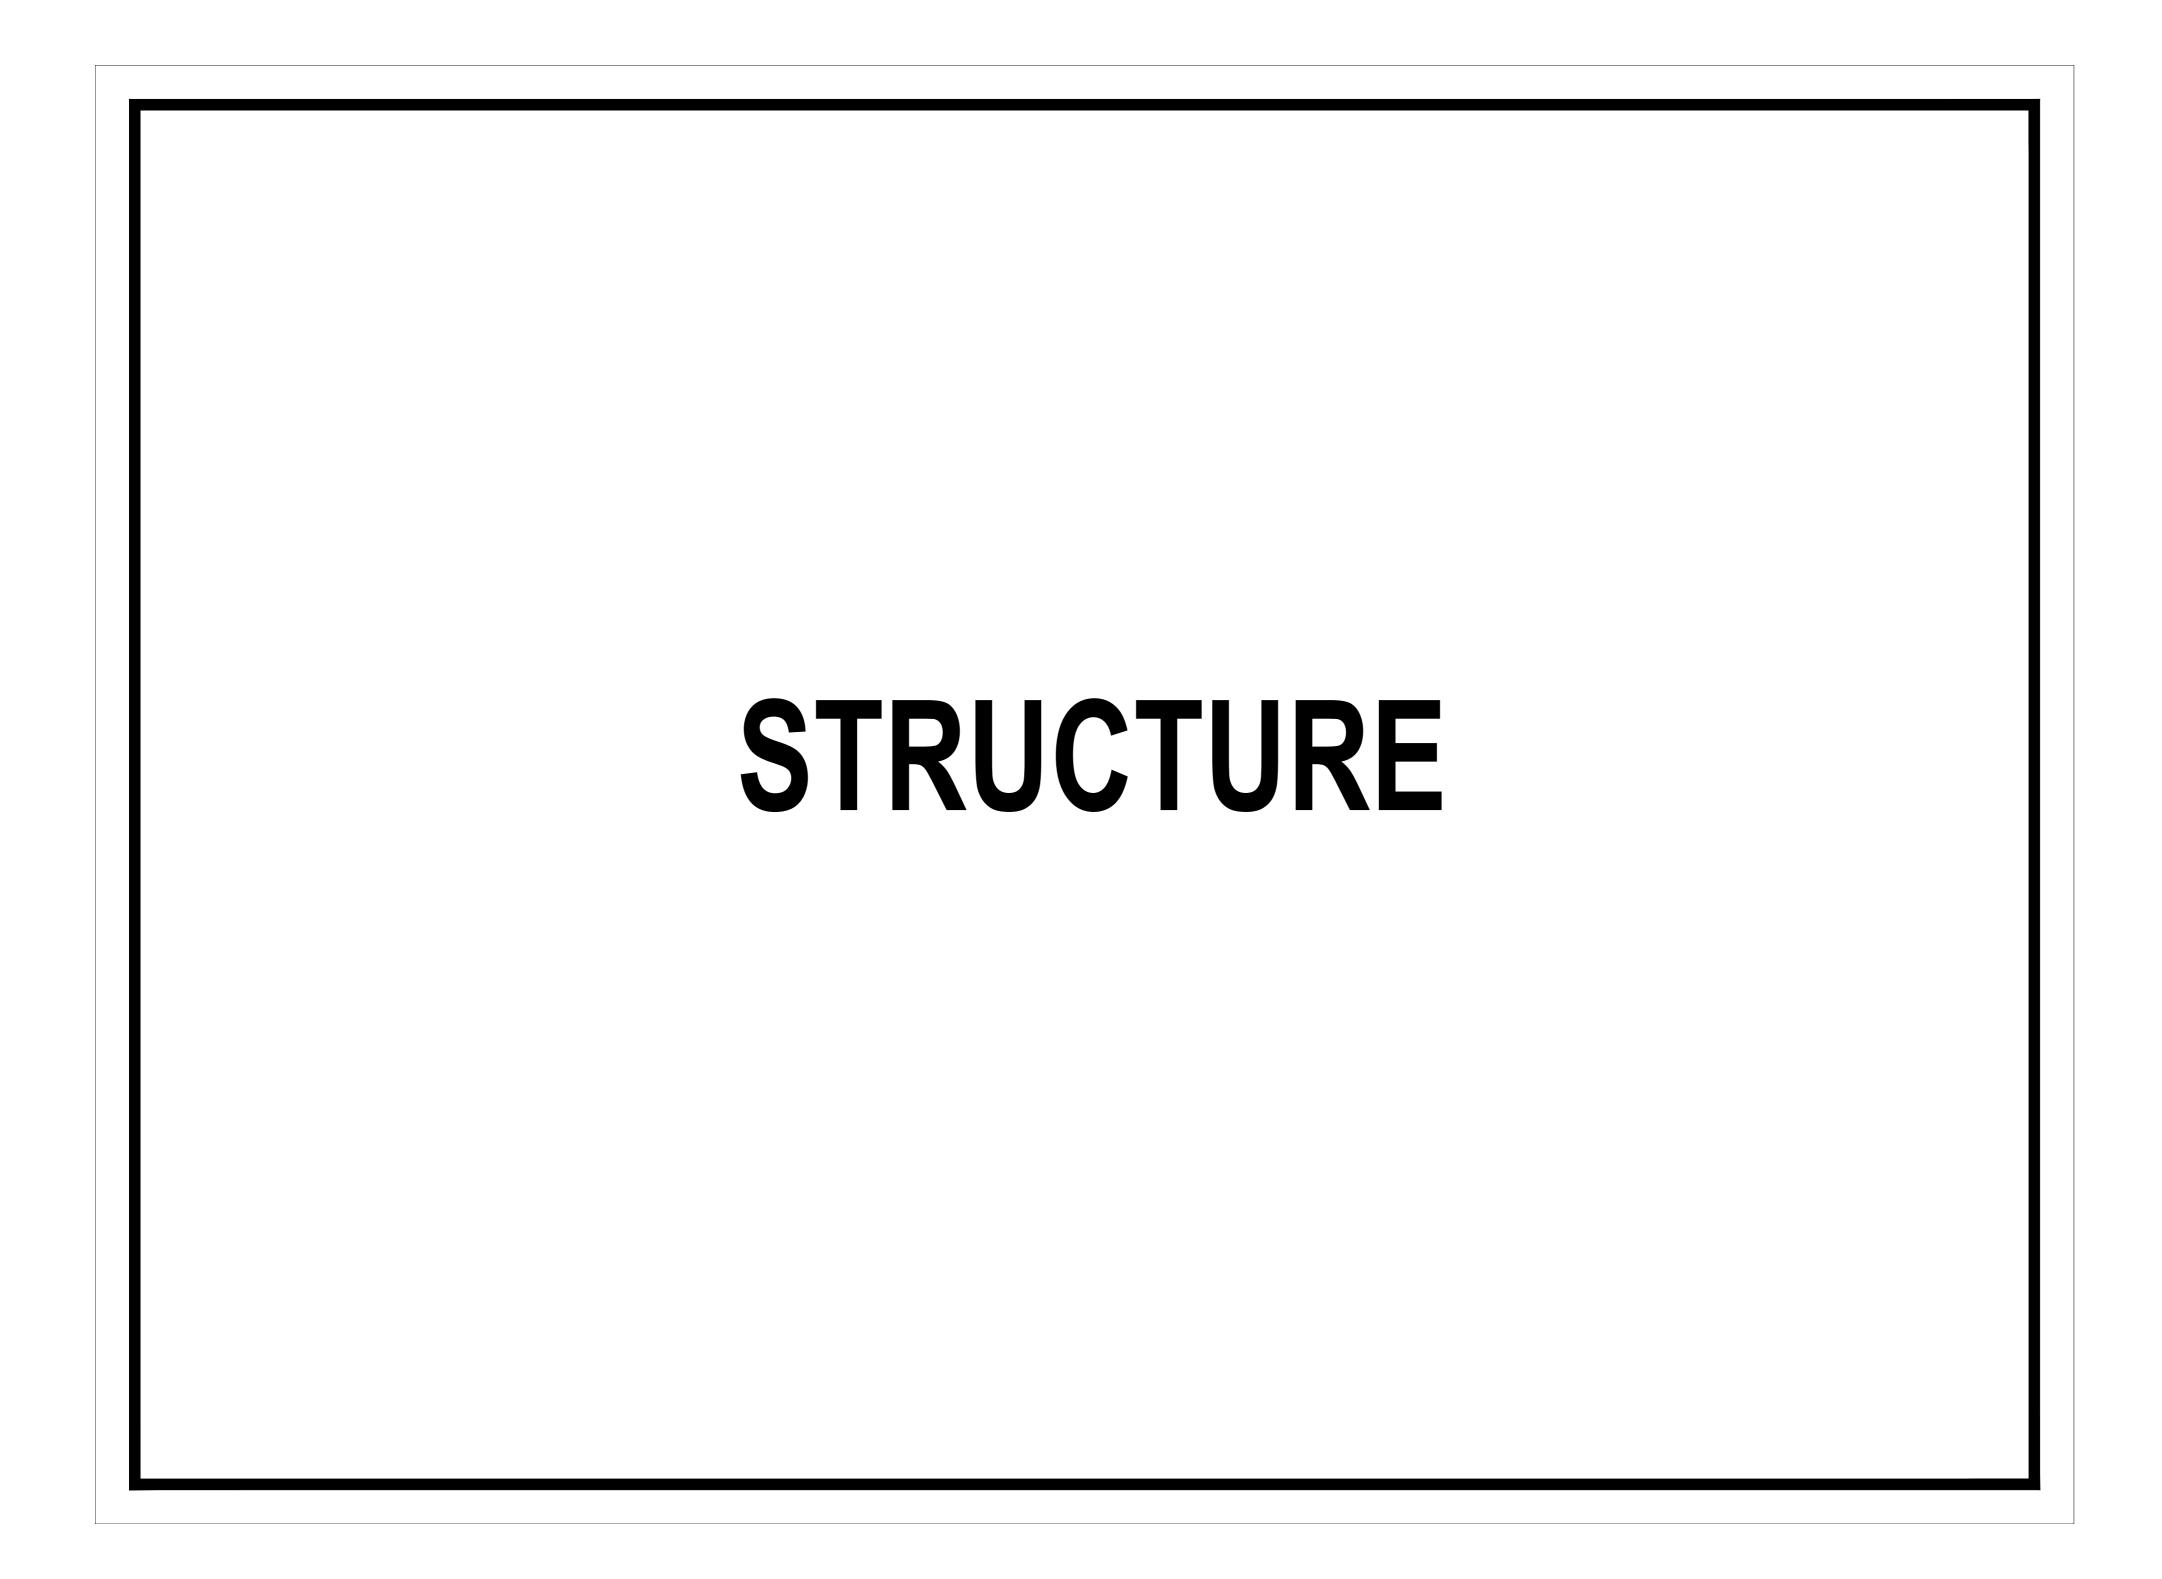
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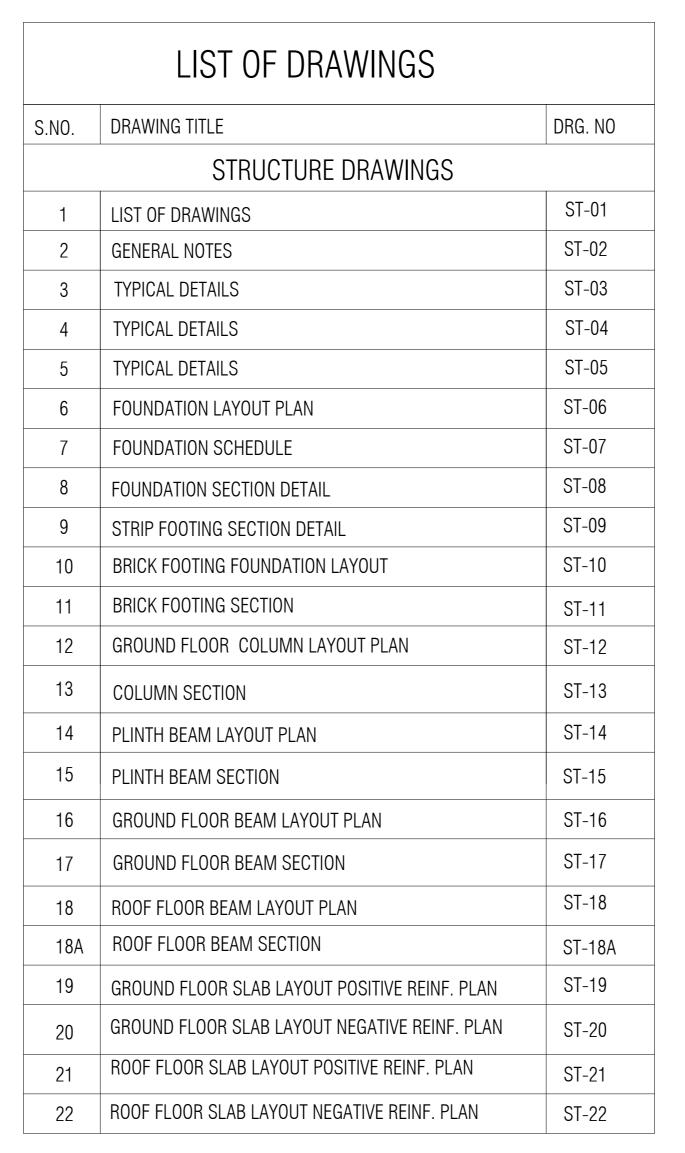
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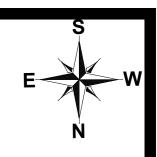


TYP. SAFETY GRILL DETAIL

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						NVEC	IJP Road Islamabad. Ph: +92-51-4848375, Fax: +92-51-4848375 Email: newvisionec@yahoo.com	TITLE:	SCIENCE JAMSHORO LUMHS ACADEMIC BLOCK	DESIGNED BY: AR.SALMAN DRAWN BY:	APPROVED BY: A.S JOB NO.	DATE : APRIL-2024 SCALE:
							Regional Office: 287-A Street # 6, Cavalry Ground ,Lahore		TYPICAL SAFETY GRILL DETAILS	SAIF		N.T.S
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THE STRUCTURE IS DESIGNED AS COMPOSITE IN NATURE I.E.,

9" AND 13.5" WALLS ARE LOAD BEARING.THE CONSTRUCTION SHOULD BE CARRIED OUT PARALLEL FOR FRAME AND WALLS SO LOAD SHOULD BE DISTRIBUTED ON WALLS.

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LUMHS ACADEMIC BLOCK LIST OF DRAWING

CLIENT:	
	LIAQUAT UNIVERSITY OF MEDICIAL &
	HEALTH SCIENCE JAMSHORO
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DESIGNED BY: ENG.ALI HAIDER	APPROVED BY:	DATE :	APRIL,2024
DRAWN BY: MATHEW SIMON	JOB NO.	SCALE:	N.T.S
DRG. NO.	ST-01		

GENERAL TECHNICAL NOTES

- Figured dimensions are to be followed.
- 2. Class "A" kiln burnt brick with minimum crushing strength of 2000 PSI should be used & joint at end should be sloppy, Vertical toothed joint at corners are prohibited.
- 3. A steel G-60 deformed steel should be used in beams footing slabs and water retaining structures, in columns, for all diameters.
- All steel should be checked for its quality and placement DETAIL as shown in drawings.
- Extra care is required for proper placement of top reinforcement at support sections and cantilevers.
- Dotted bars designate top reinforcement.
- Provide L- shaped end hooks for all bars at discontinuous ends in footings, walls, beams and slabs as shown in drawings.
- Lap length should be followed As except specified:-
 - (a) $1'' \emptyset = 60''$
 - (b) 3/4" Ø = 45"
 - (c) 5/8" Ø = 36"
 - (d) 1/2" Ø = 30"

 - (e) 3/8" Ø = 23"
- Provide 3/8" dia at 12" c/c as distribution steel if not shown in drawings.
- Minimum concrete cover.
 - a) Footing = 2"
- e) Water tank and retaining wall
- b) Slabs = 3/4"
- i- Water/earth face or c) Beams = 11/2" exposed to weather = 2"
- d) Columns = $1\frac{1}{2}$ "
- ii- Other faces = 1"
- 11. All footing should be taken below the original Ground Level to achieve the minimum depth as shown in drawings. Footing should not be placed on uncompacted fill area.
- All drawings should be read in conjunction with Architectural Drawings.
- Contractor will co-ordinate all drawings such as architectural, structural, electrical, mechanical, water supply, drainage etc. before execution of work.
- Standard ACI 318, Astm C 33 and Astm A-615 use for structural concrete
- Fine modulus of fine aggregate varies from 2-3.5mm For concrete use 2.9-3.2mm For plaster use 2.2-3.6mm

QUALITY OF CONCRETE

FOOTINGS & RETAINING WALLS.

Minimum concrete compressive strength for 6"x12" cylinder to be 3000 psi at 28 days age. Concrete Nominal Mix 1:2:4 or more rich to provide specified strength (Equivalent 6"x6"x6" cube strength 3750 psi)

COLUMNS.


Minimum concrete compressive strength for 6"x12" cylinder to be 4000 psi at 28 days age. Concrete Nominal Mix to be 1:11/2:3 or more rich to provide specified strength

Admixture must be provided to ensure the specified structural strength as mentioned earlier.

- BEAMS, RIBS & SLABS.
 - Minimum concrete compressive strength for 6"x12" cylinder to be 3000 psi at 28 days age.Concrete Nominal Mix to be 1:2:4 or more rich to provide specified strength (Equivalent 6"x6"x6" cube strength 3750 psi) Admixture must be provided to ensure the specified structural strength as mentioned earlier.
- 4. Use of plasticizers recommended to reduce the water cement ratio and increase workability of concrete.
- 5. All concrete mixes to be used, should be got designed & approved before execution of work.
- 6. Quality, size and gradation of aggregates (fine & course) as used during the mix design, should be strictly adhered with.
- 7. The Design is in accordance with Seismic Zone 2A.

NOTES

- 1. ALL LAYOUT DIMENSIONS AND F.FLOOR LEVELS TO BE AS PER ARCH DRAWING.
- 2. PROVIDE PLINTH BEAM PB AT PLINTH LEVEL, WALL BEAMS AT SLAB LEVEL.
- 3. PROVIDE #2 DOUBLE-LEG TIE BARS AT 12" CENTRES AT COMMON JOINT BETWEEN WALLS AND COLUMNS. THESE BARS SHOULD PASS INTO WALLS ON EACH SIDE OF COLUMNS.

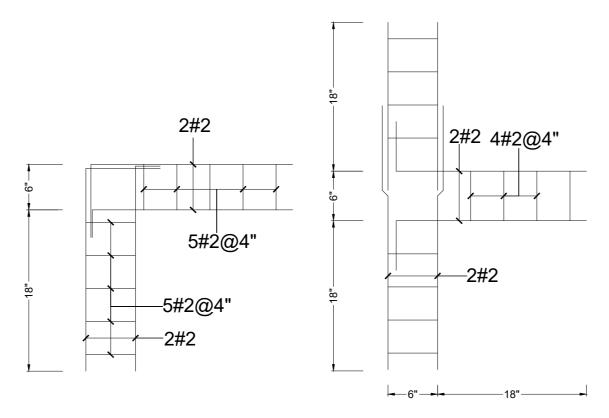



PLAN OF BRICK WALL TIE FOR T-JOINT


REINFORCING STEEL

#3 0.375

#5 0.625

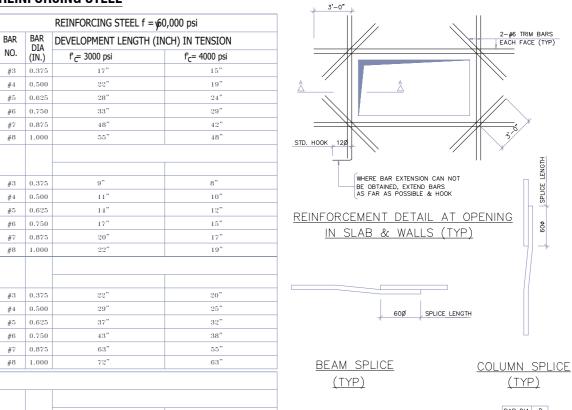

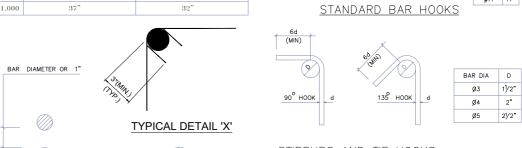

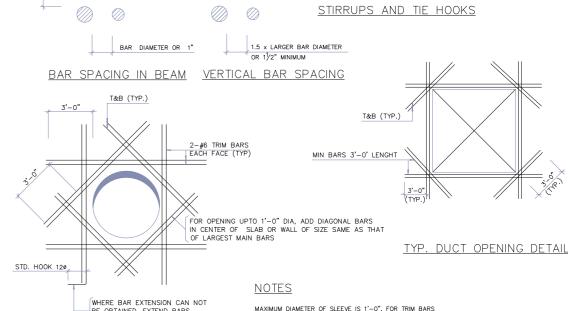

REINFORCEMENT AROUND SLEEVE IN SLAB & WALLS (TYP)

PLAN OF BRICK WALL TIE FOR CORNER JOINT

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LUMHS ACADEMIC BLOCK GENERAL NOTES

LIAQUAT UNIVERSITY OF MEDICIAL & **HEALTH SCIENCE JAMSHORO**


APRIL,2024 ENG.ALI HAIDER DRAWN BY N.T.S MATHEW SIMON ST-02


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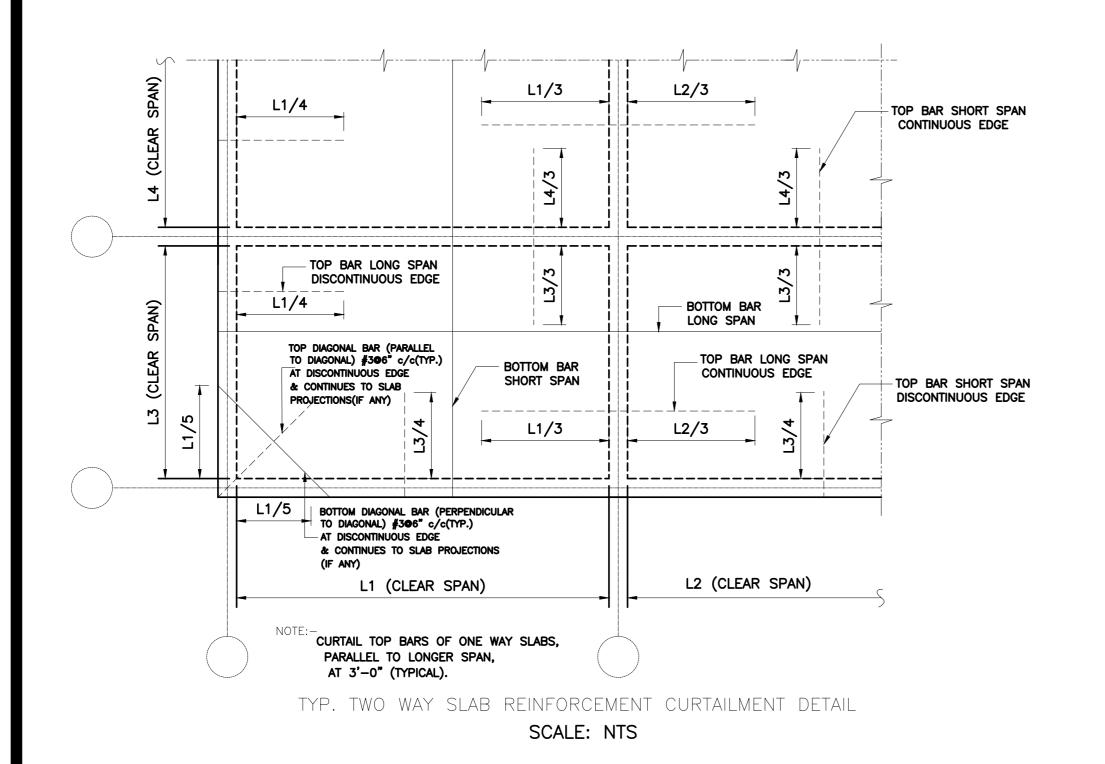
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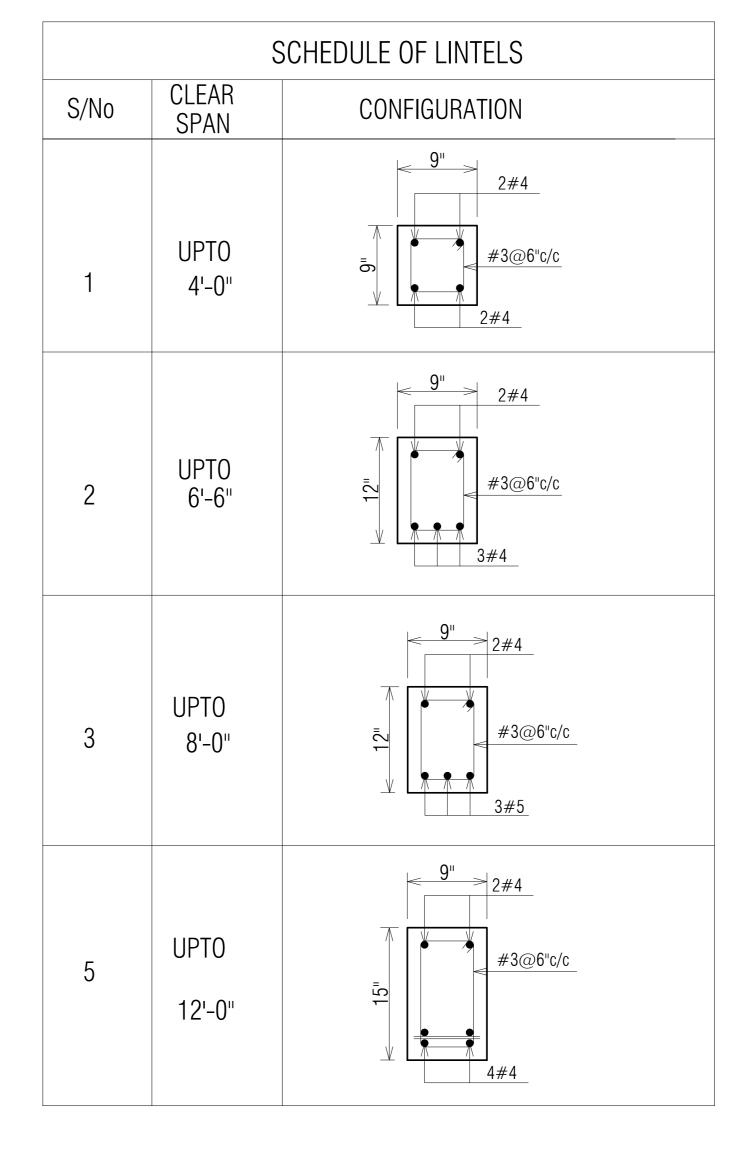
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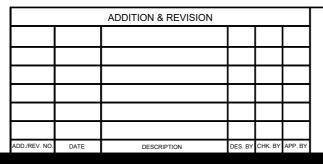
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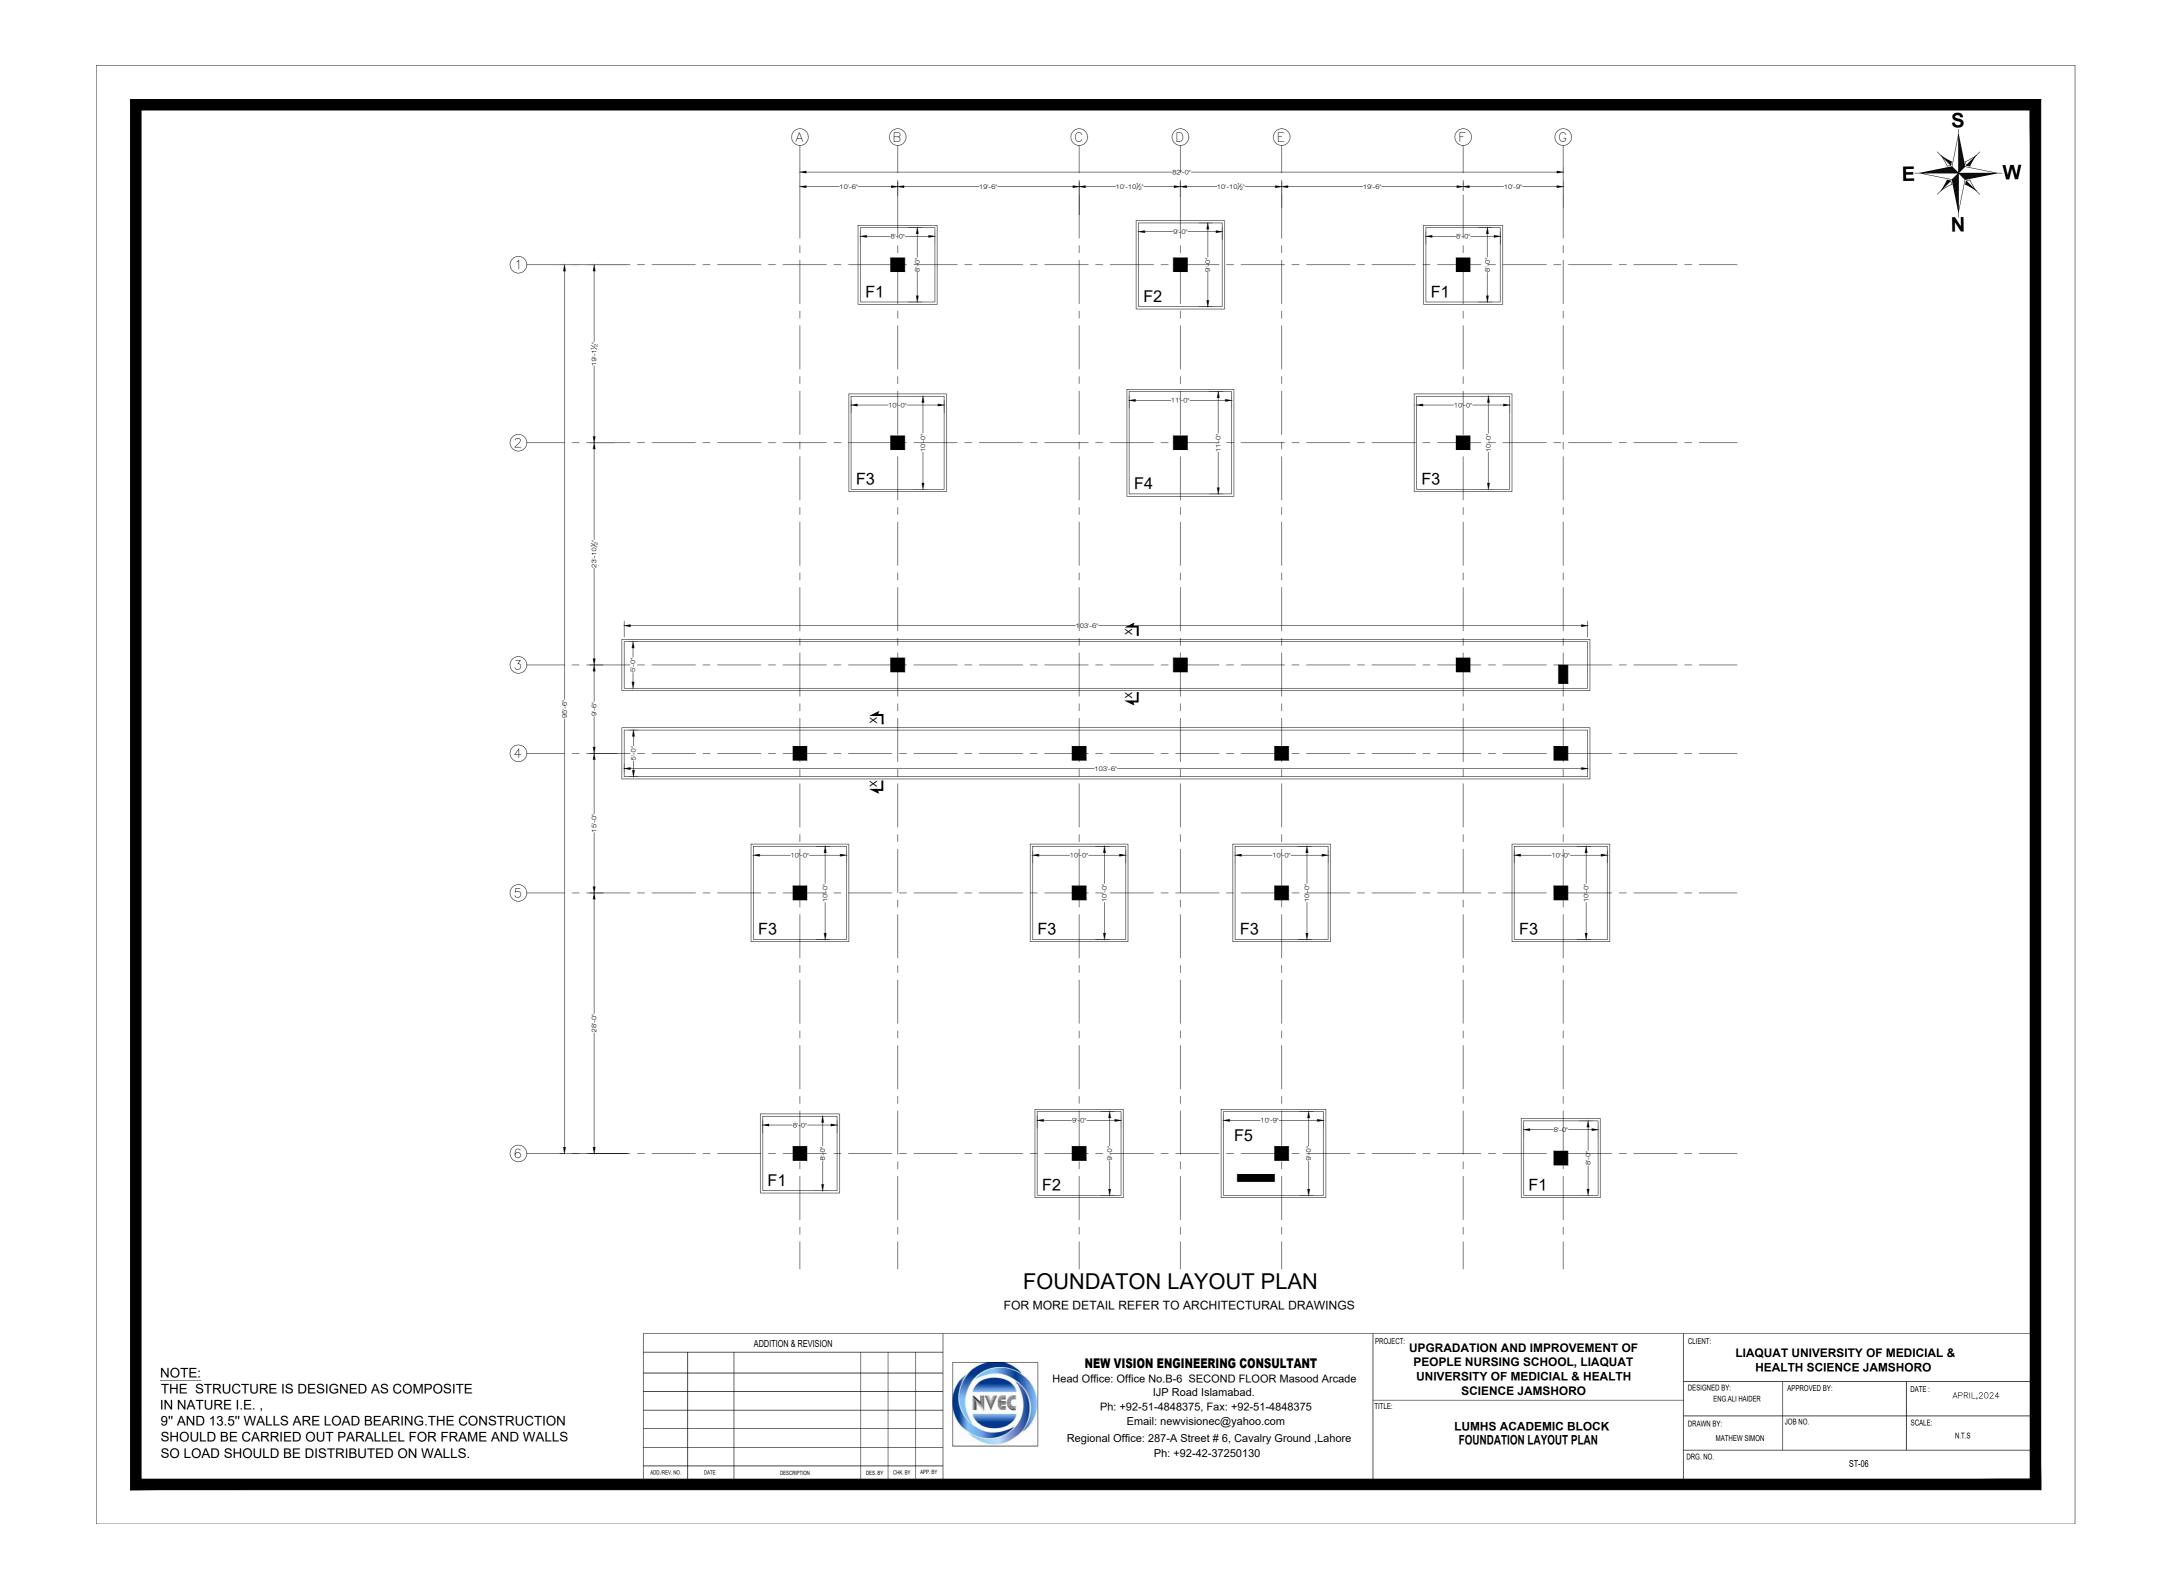
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UPGRADATION AND IMPROVEMENT OF PEOPL NURSING SCHOOL, LIAQUAT UNIVERSITY OF MEDICIAL & HEALTH SCIENCE JAMSHORO

TYPICAL DETAIL

LE F	LIAQUAT U	NIVERSITY OF MED SCIENCE JAMSHO		& HEALTH
)	DESIGNED BY: ENG. ALI HAIDER	APPROVED BY:	DATE :	FEB, 2024
	DRAWN BY: MATHEW SIMON	JOB NO.	SCALE:	N.T.S
	DRG. NO.	2T 05		

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SCHEDULE OF FOOTINGS

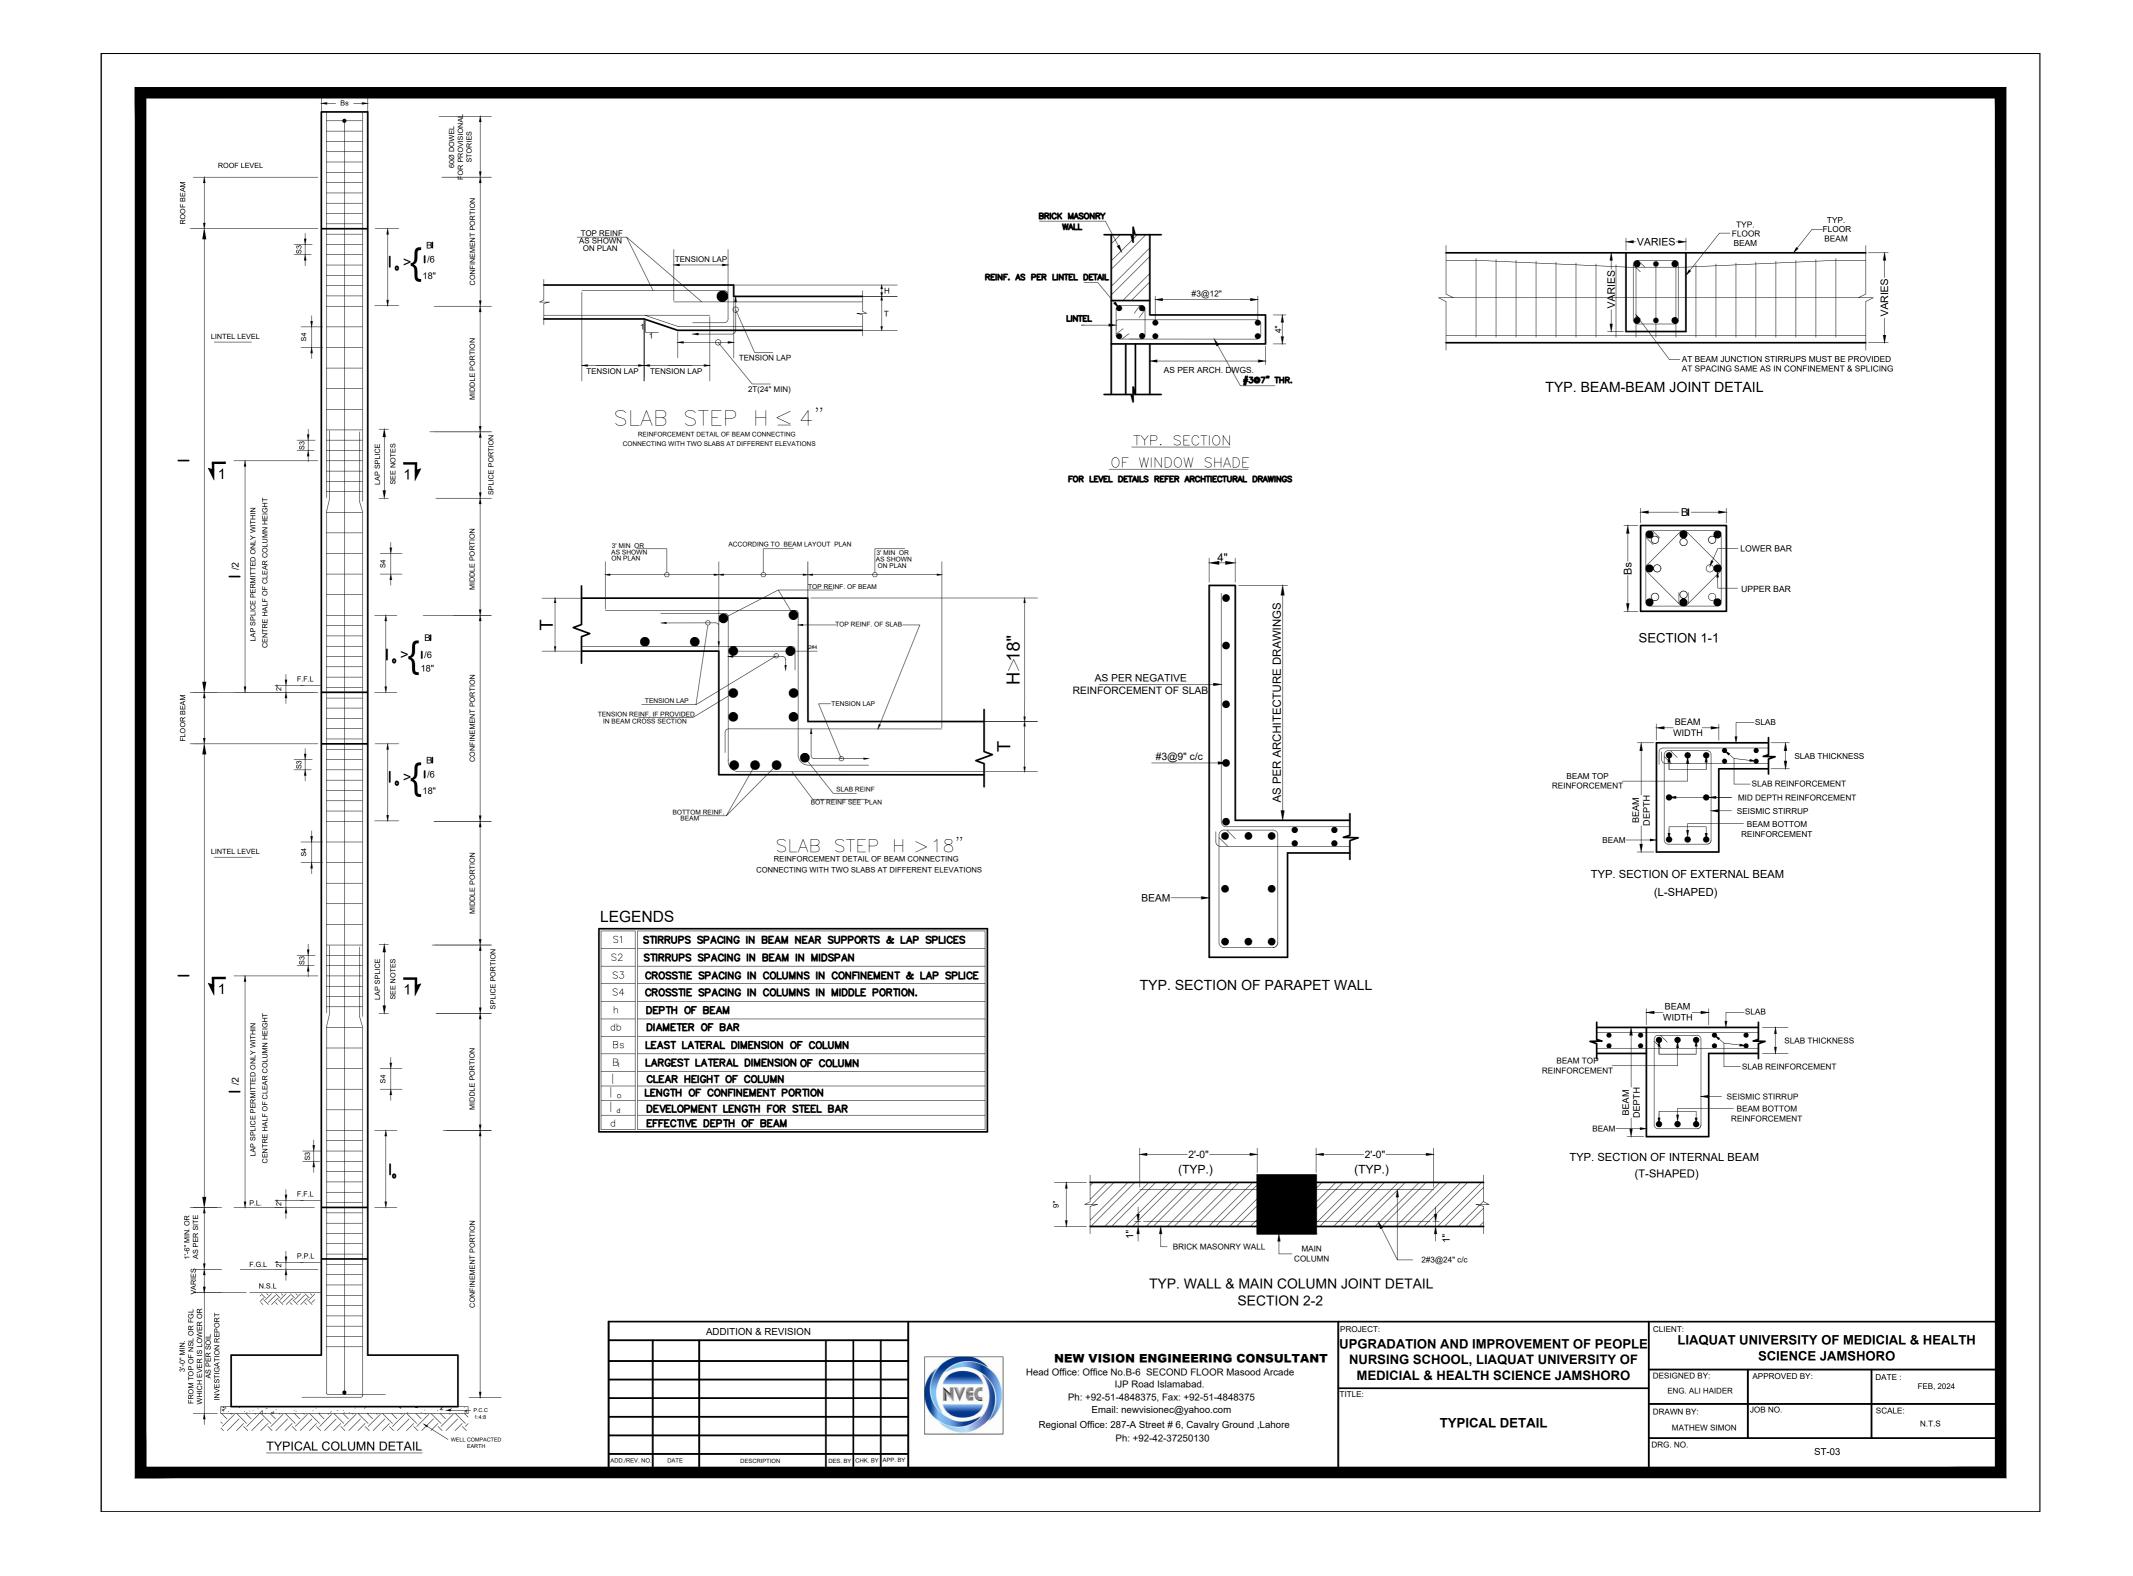		,	SIZE		F	REINFORCE	MENT DETA	IL	
MARK	ı	W		Н	ВОТТО	M BARS	TOP BARS		REMARKS
	L	VV			BS	BL	TS	TL	
F1	8'-0"	8'-0"	9"	15"	#4@6" c/c	#4@6" c/c	#3@6" c/c	#3@8" c/c	ISOLATED FOOTING
F2	9'-0"	9'-0"	9"	15"	#4@6" c/c	#4@6" c/c	#3@6" c/c	#3@8" c/c	ISOLATED FOOTING
F3	10'-0"	10'-0"	9"	15"	#4@6" c/c	#4@6" c/c	#3@6" c/c	#3@8" c/c	ISOLATED FOOTING
F4	11'-0"	11'-0"	12"	18"	#4@6" c/c	#4@6" c/c	#3@6" c/c	#3@8" c/c	ISOLATED FOOTING
F5	10'-6"	9'-0"	12"	18"	#4@6" c/c	#4@6" c/c	#3@6" c/c	#3@8" c/c	ISOLATED FOOTING
SEC X-X	103'-6"	5'-0"	9"	15"	#4@6" c/c	#4@6" c/c	#3@6" c/c	#3@8" c/c	STRIP FOOTING
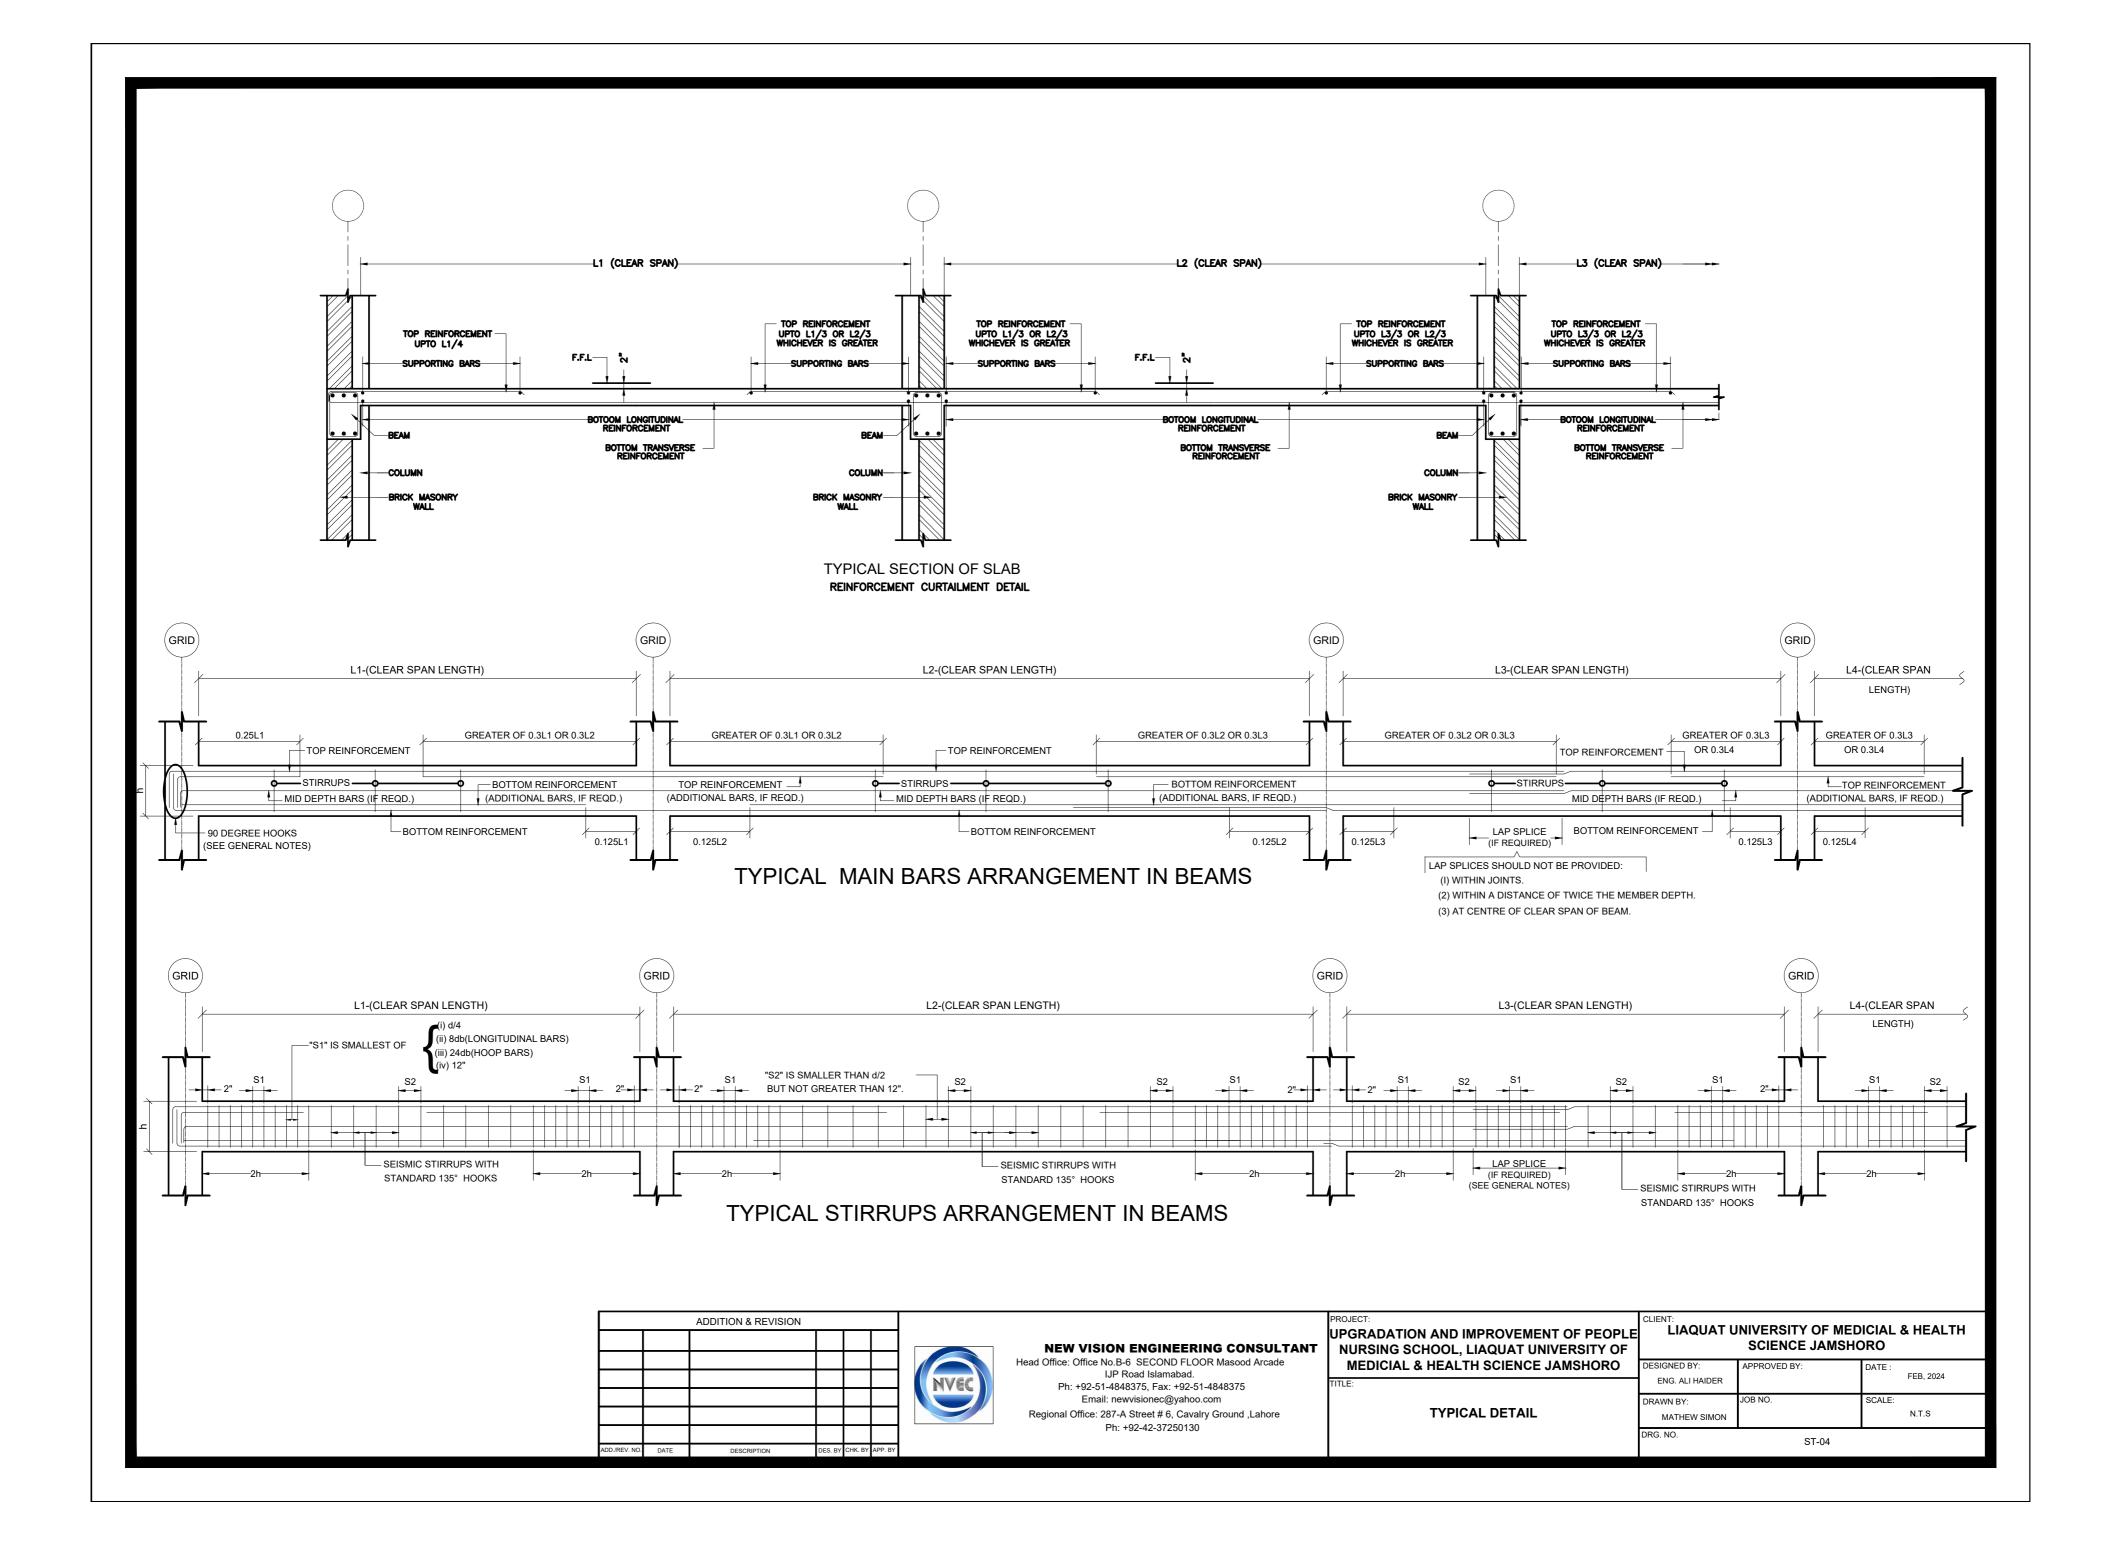
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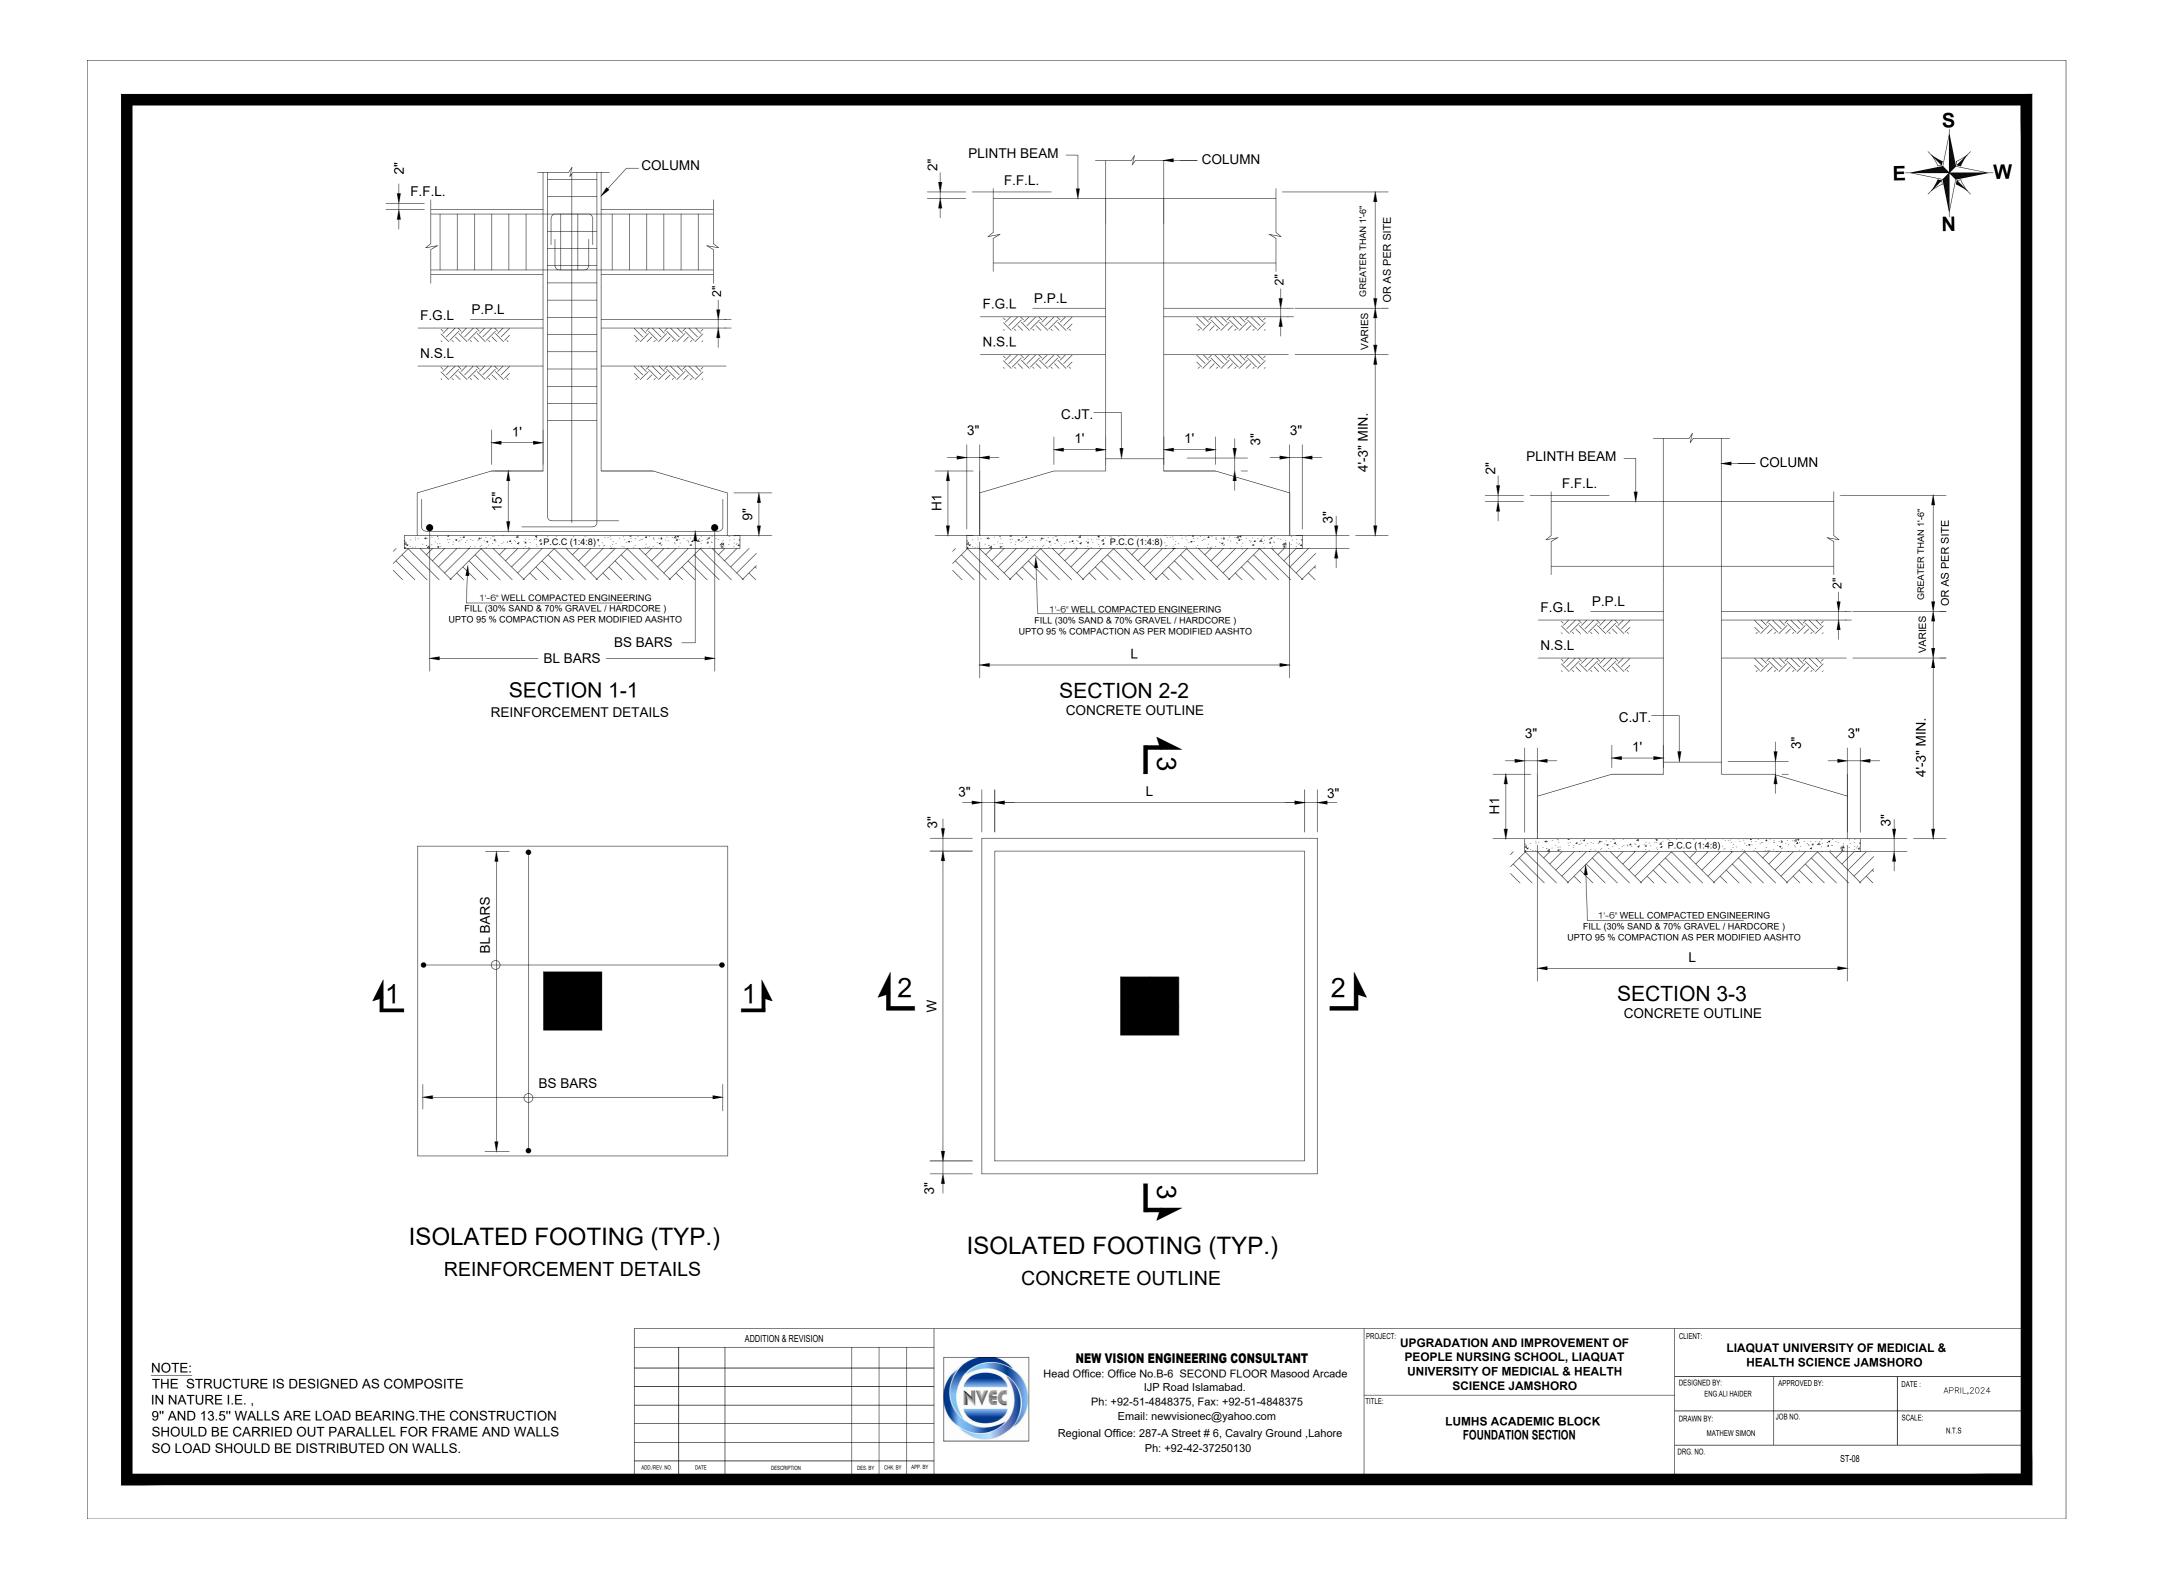
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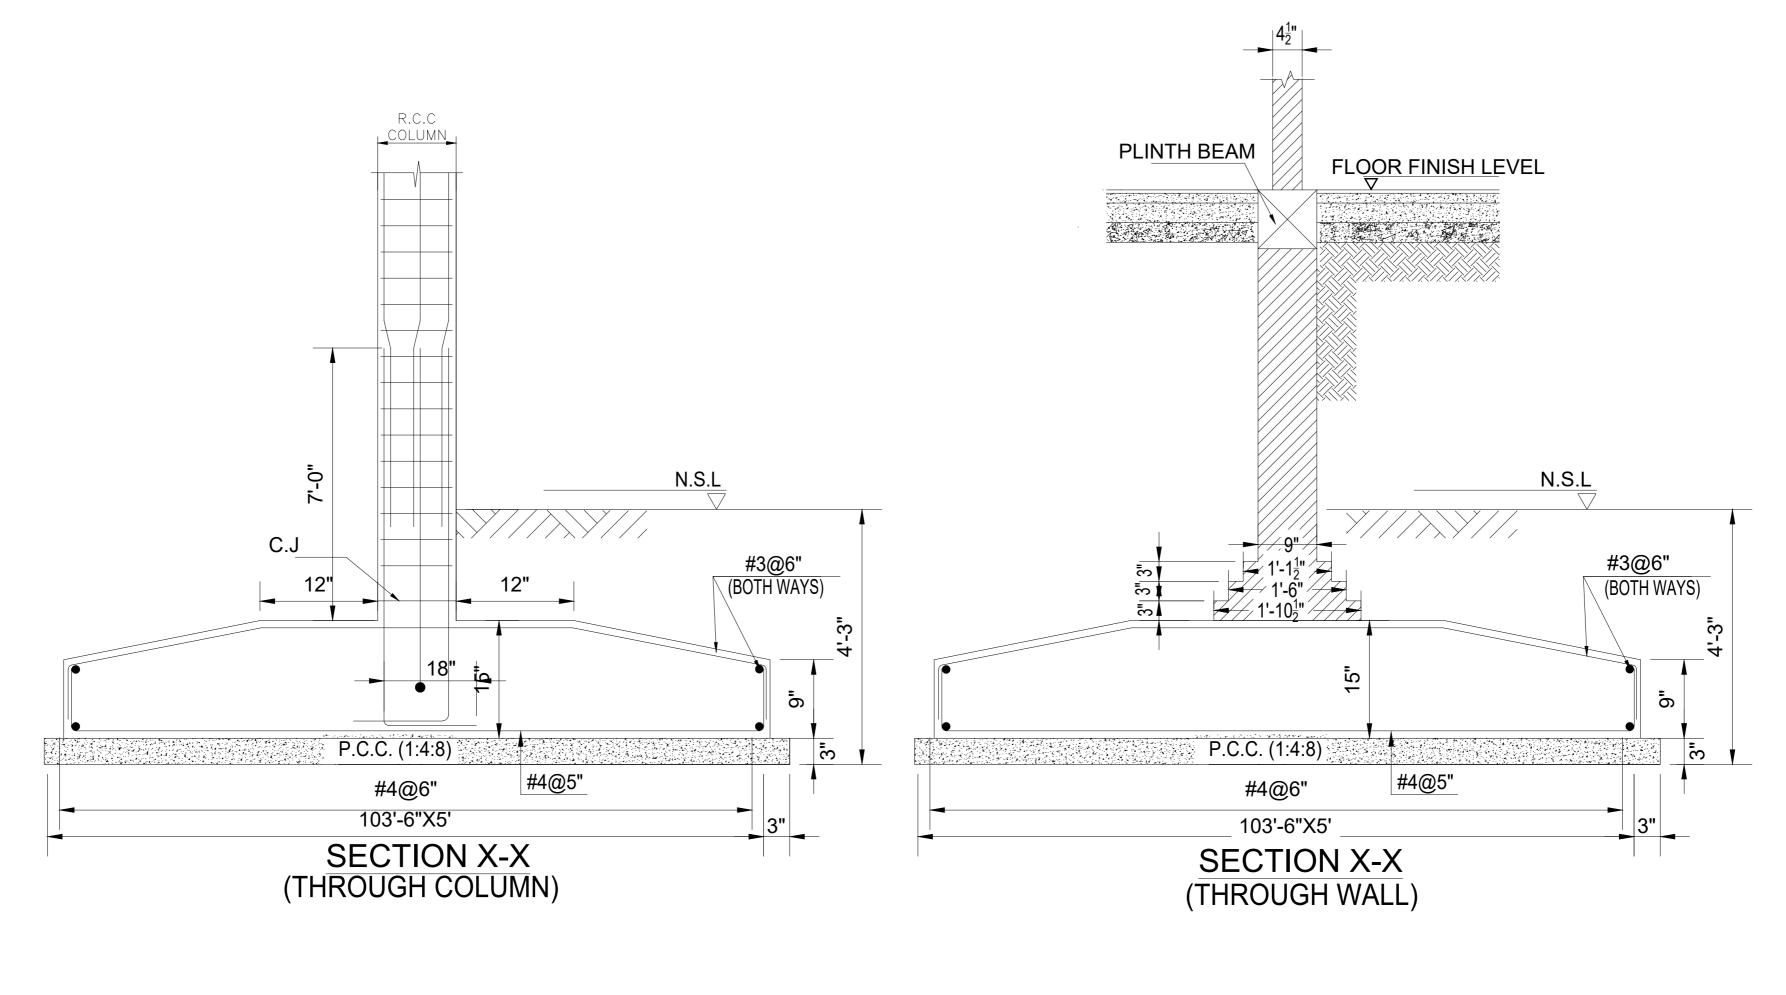
LUMHS ACADEMIC BLOCK FOUNDATION SCHEDULE

NT:	
	LIAQUAT UNIVERSITY OF MEDICIAL &
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APRIL,2024 ENG.ALI HAIDER N.T.S MATHEW SIMON ST-07







NOTE

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LUMHS ACADEMIC BLOCK STRIP FOOTING SECTION

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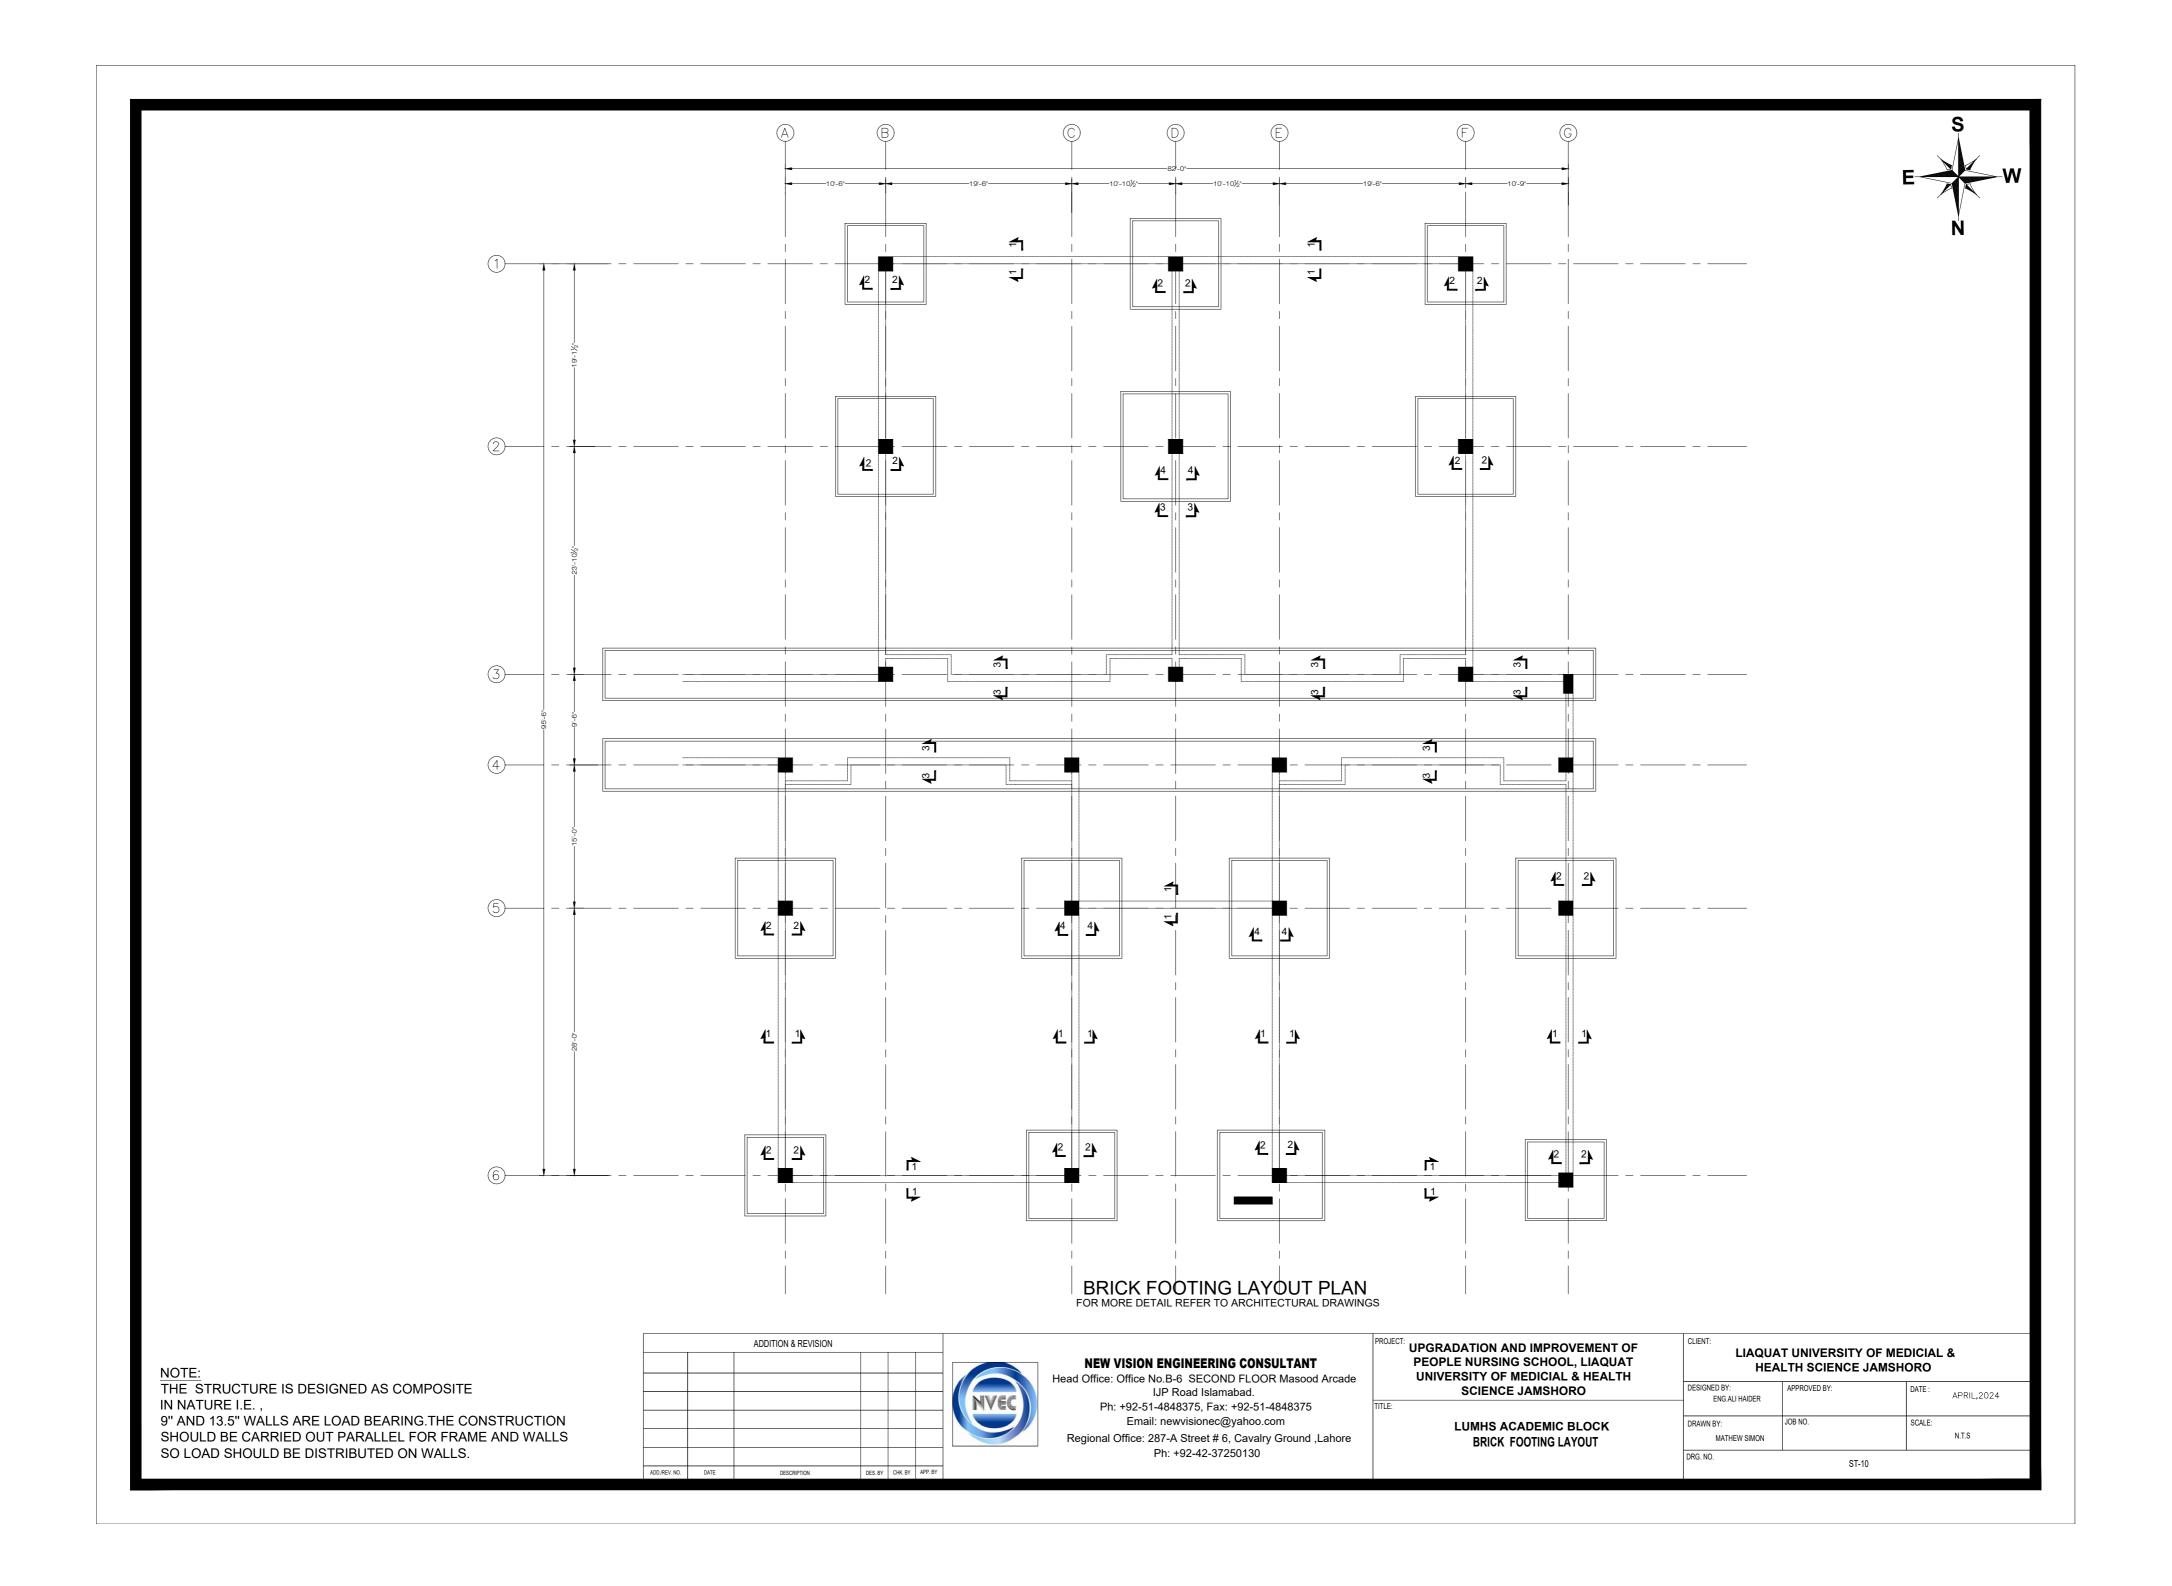
DESIGNED BY:
ENG.ALI HAIDER


APPROVED BY:
DATE:
APRIL,2024


DRAWN BY:
MATHEW SIMON


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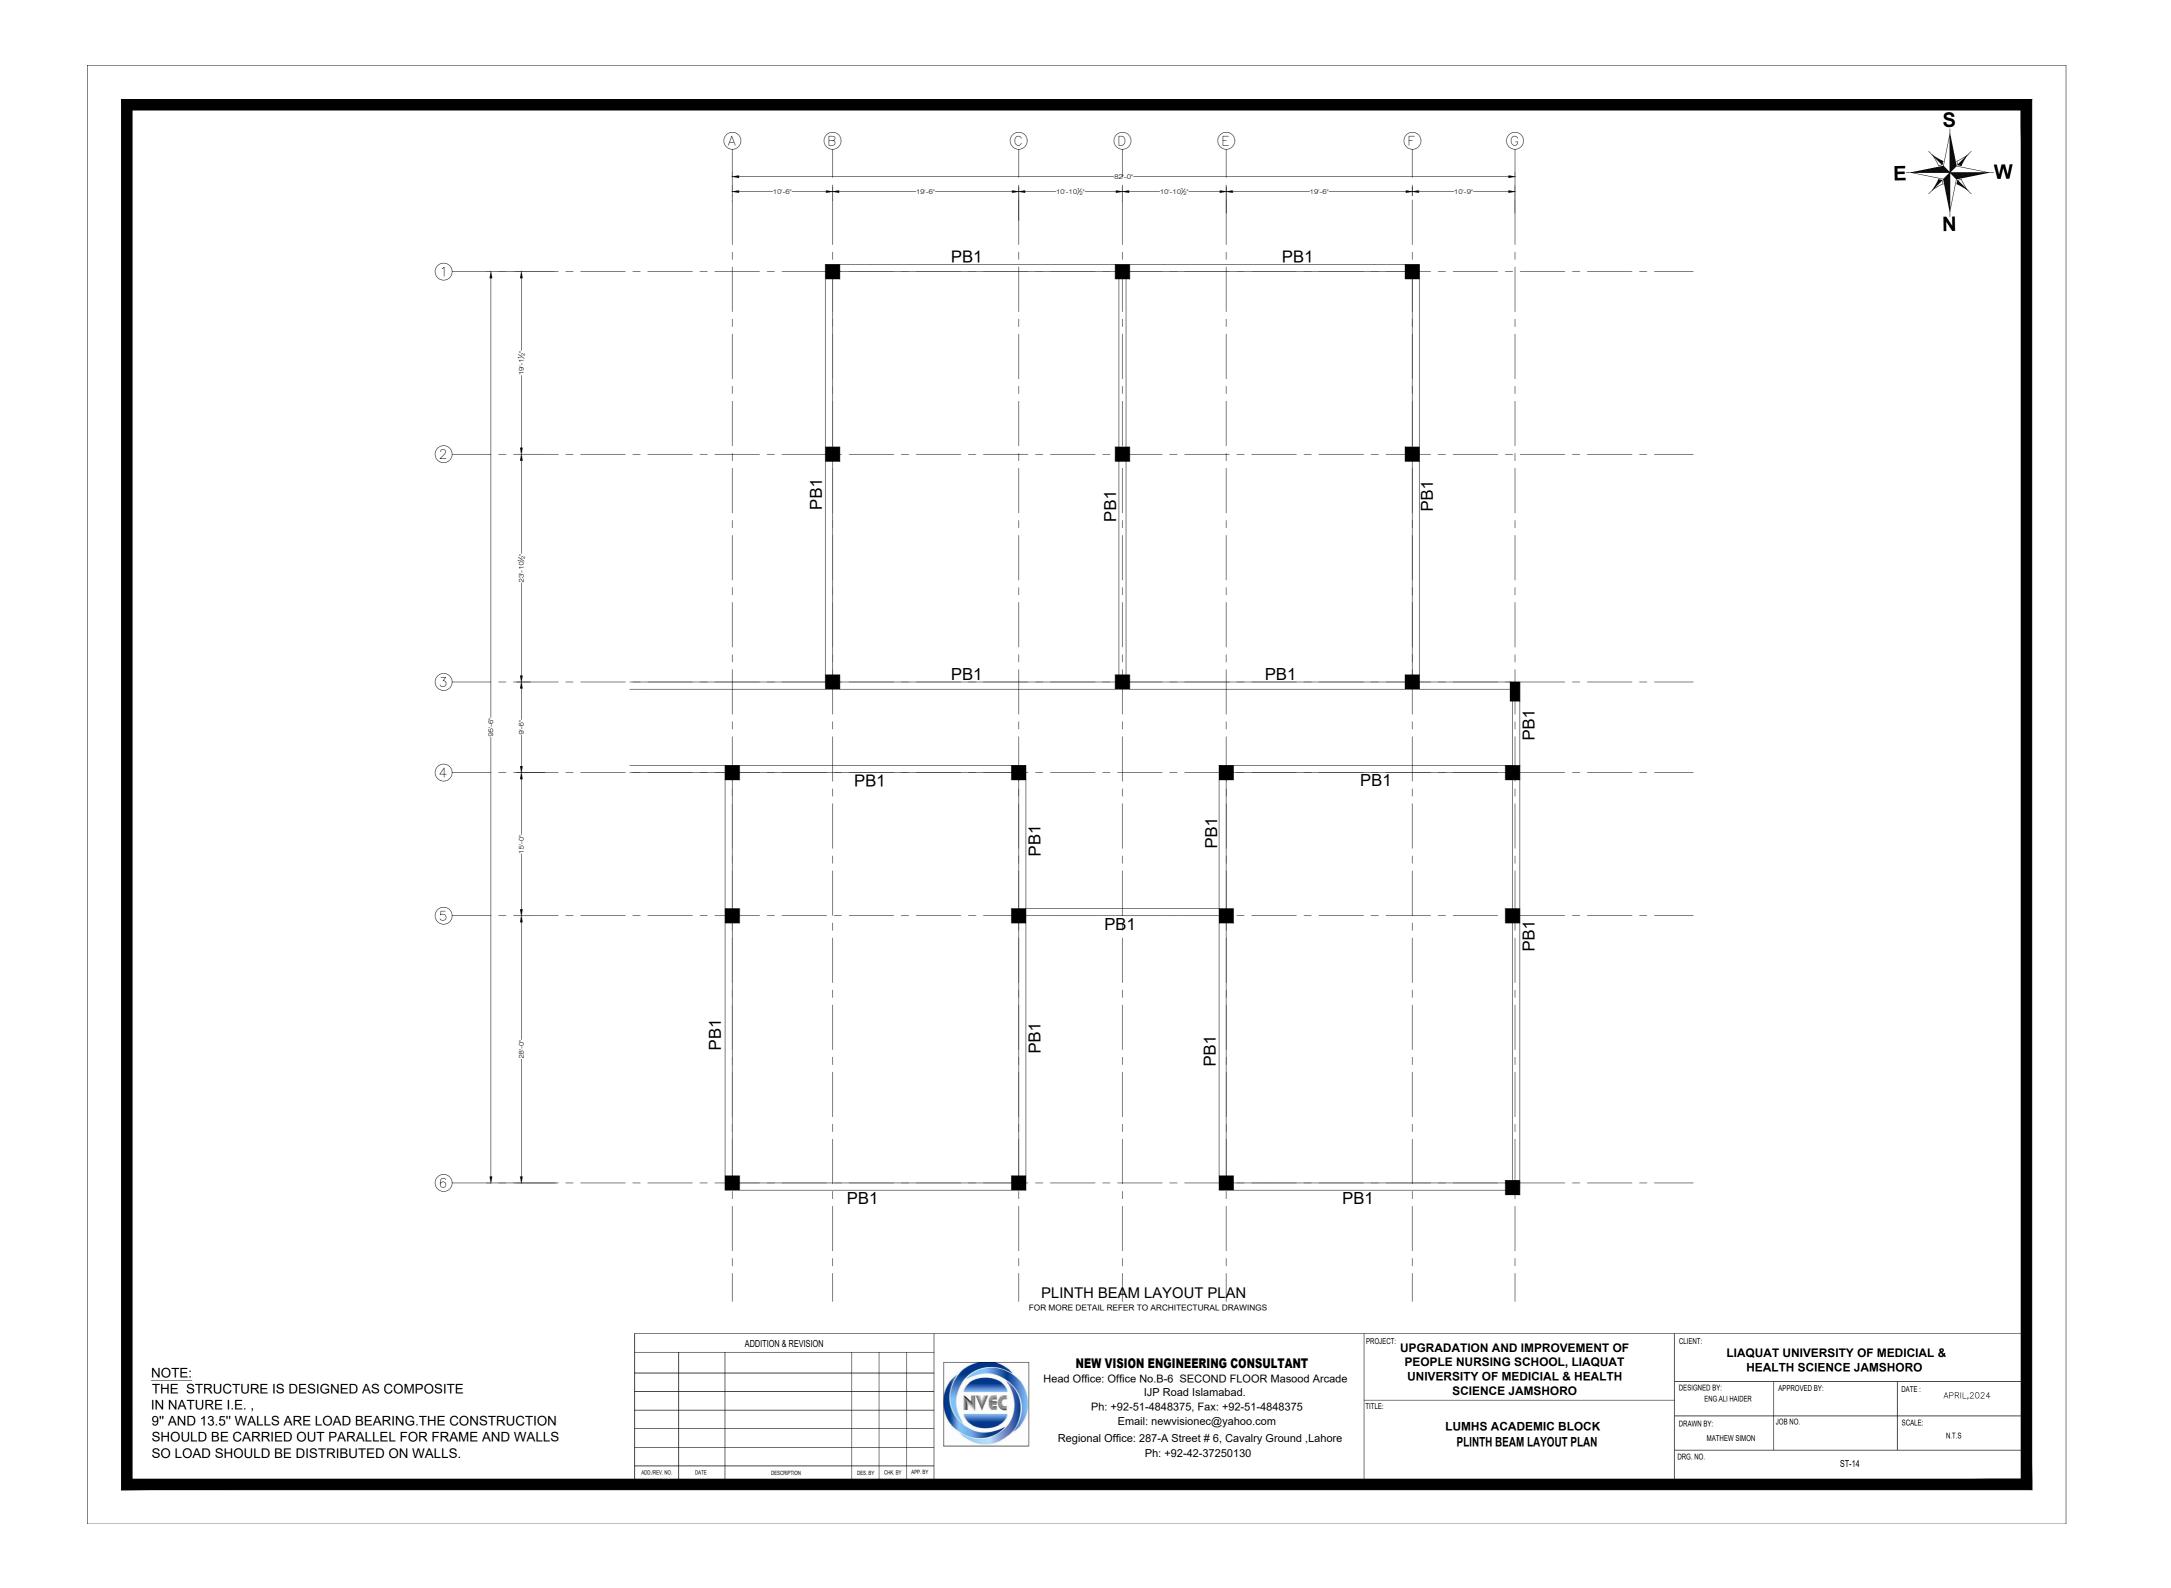
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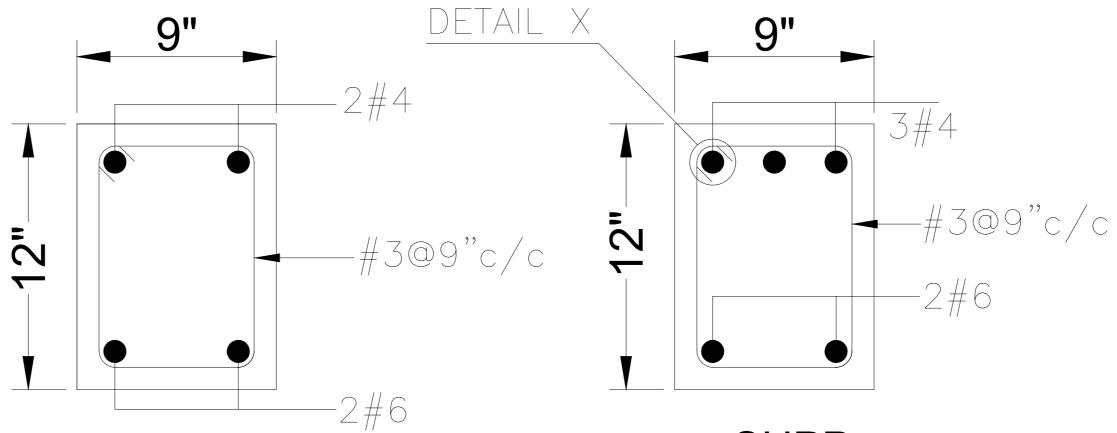







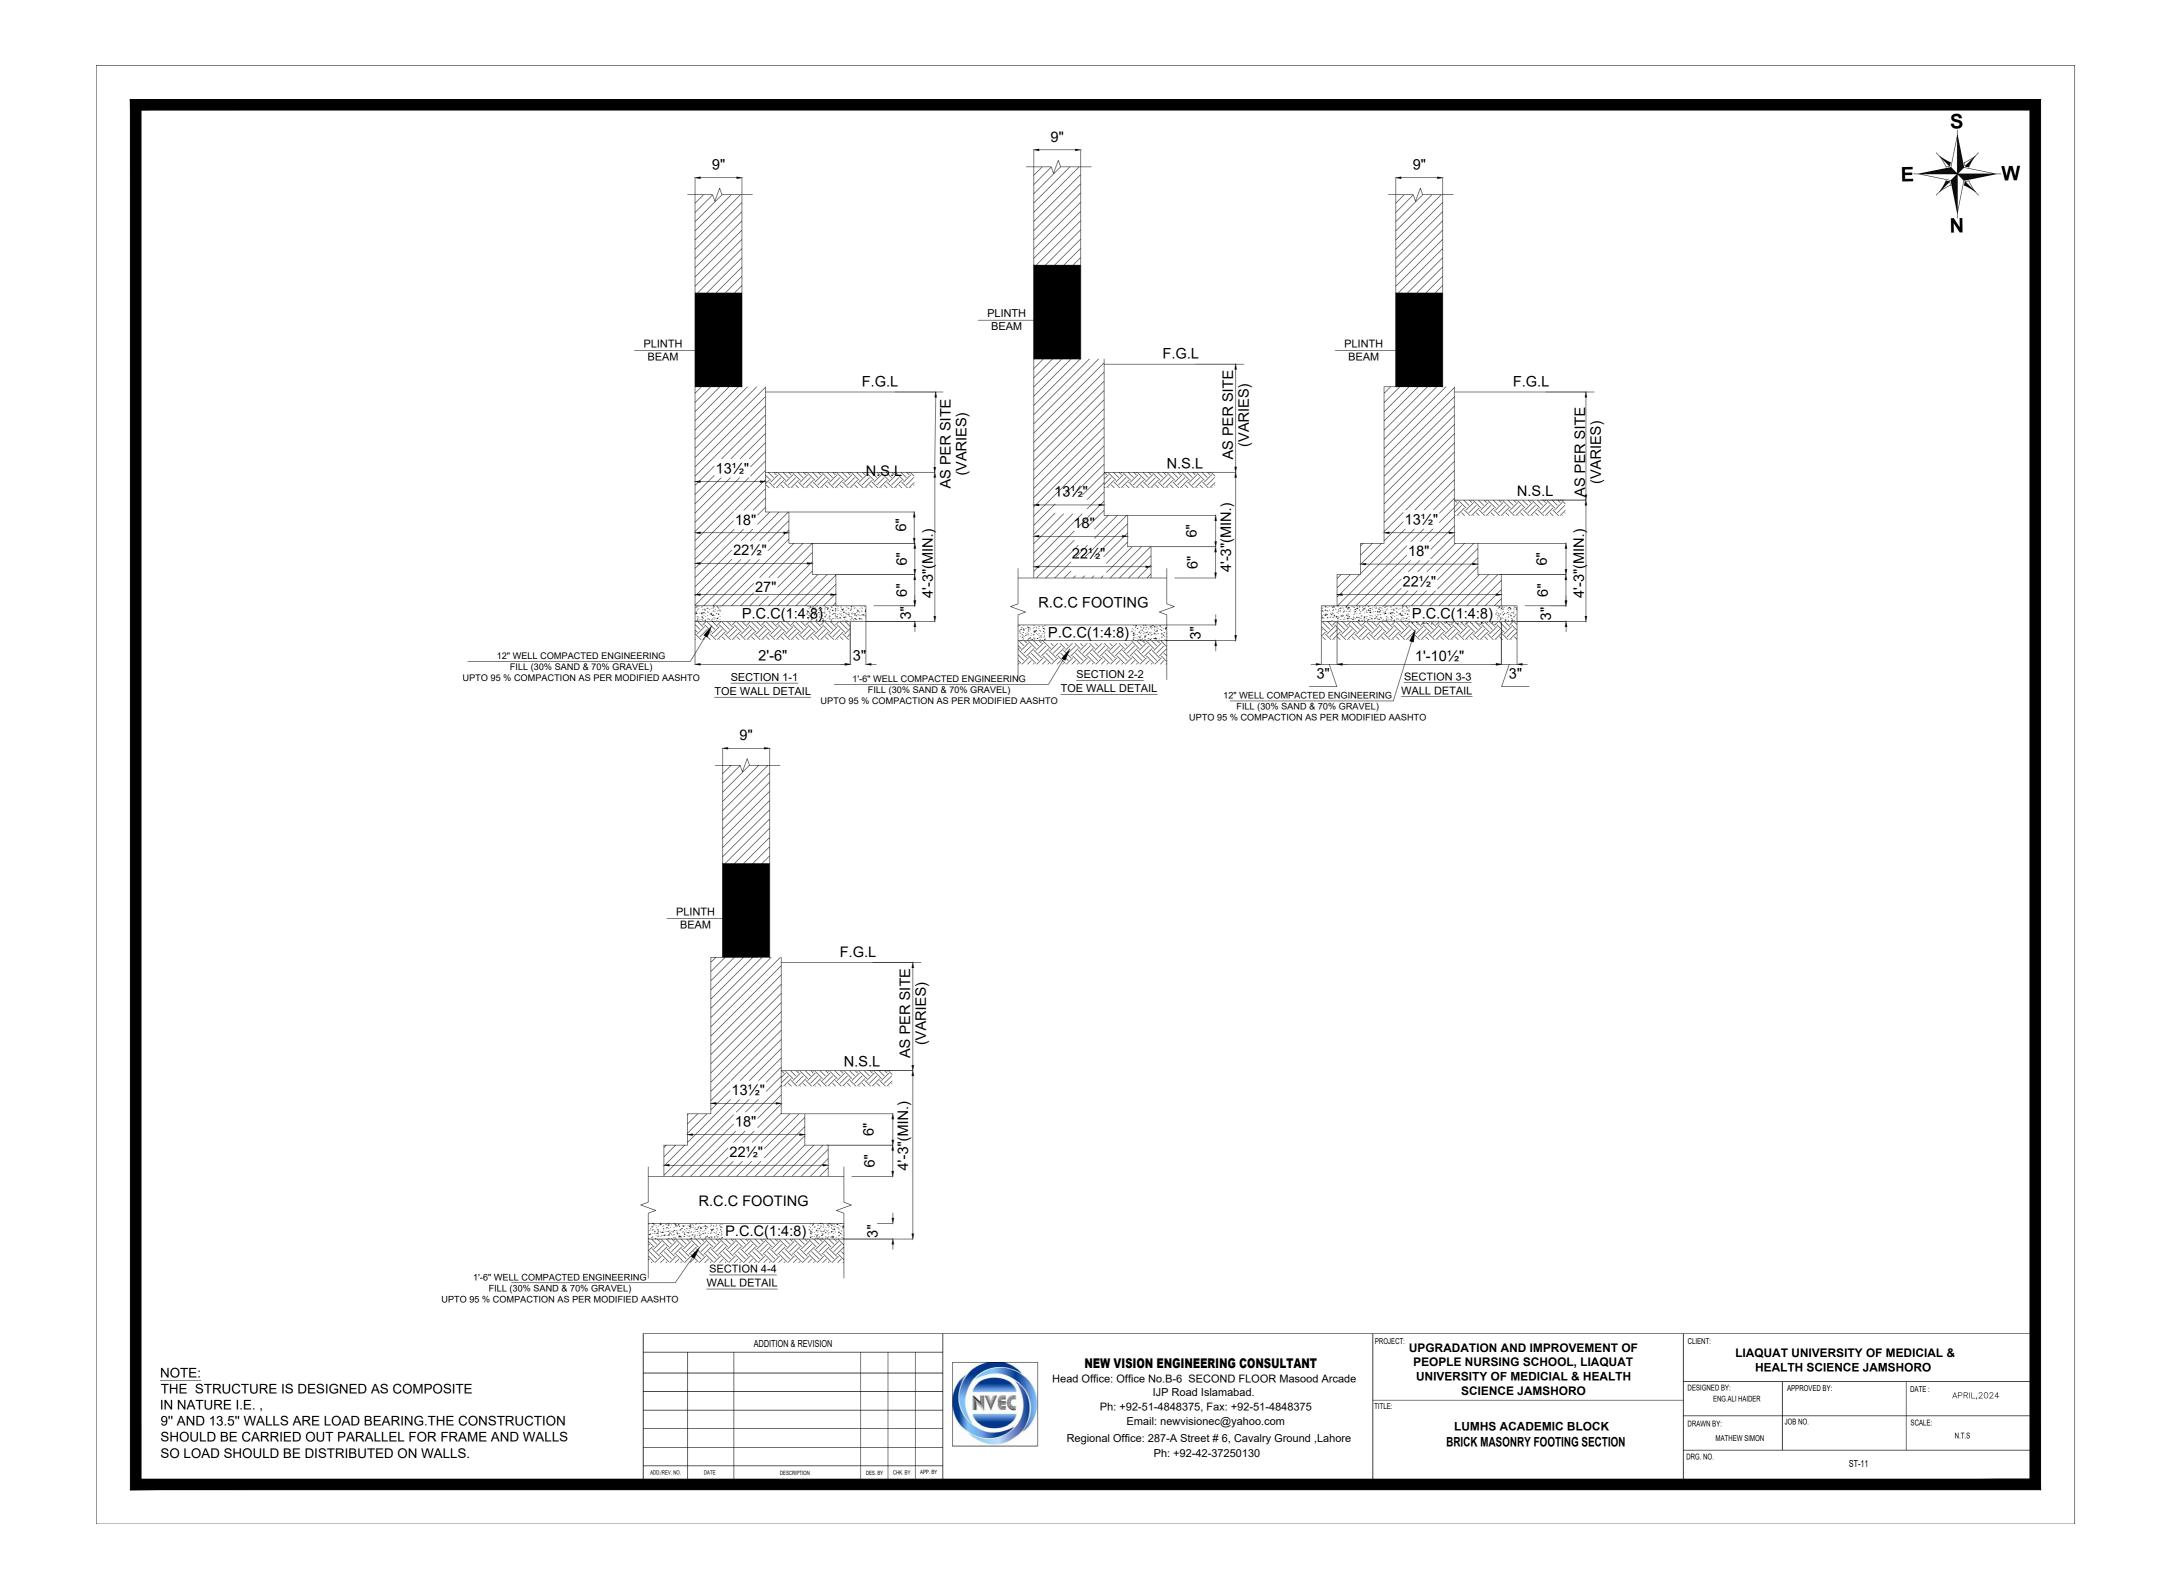

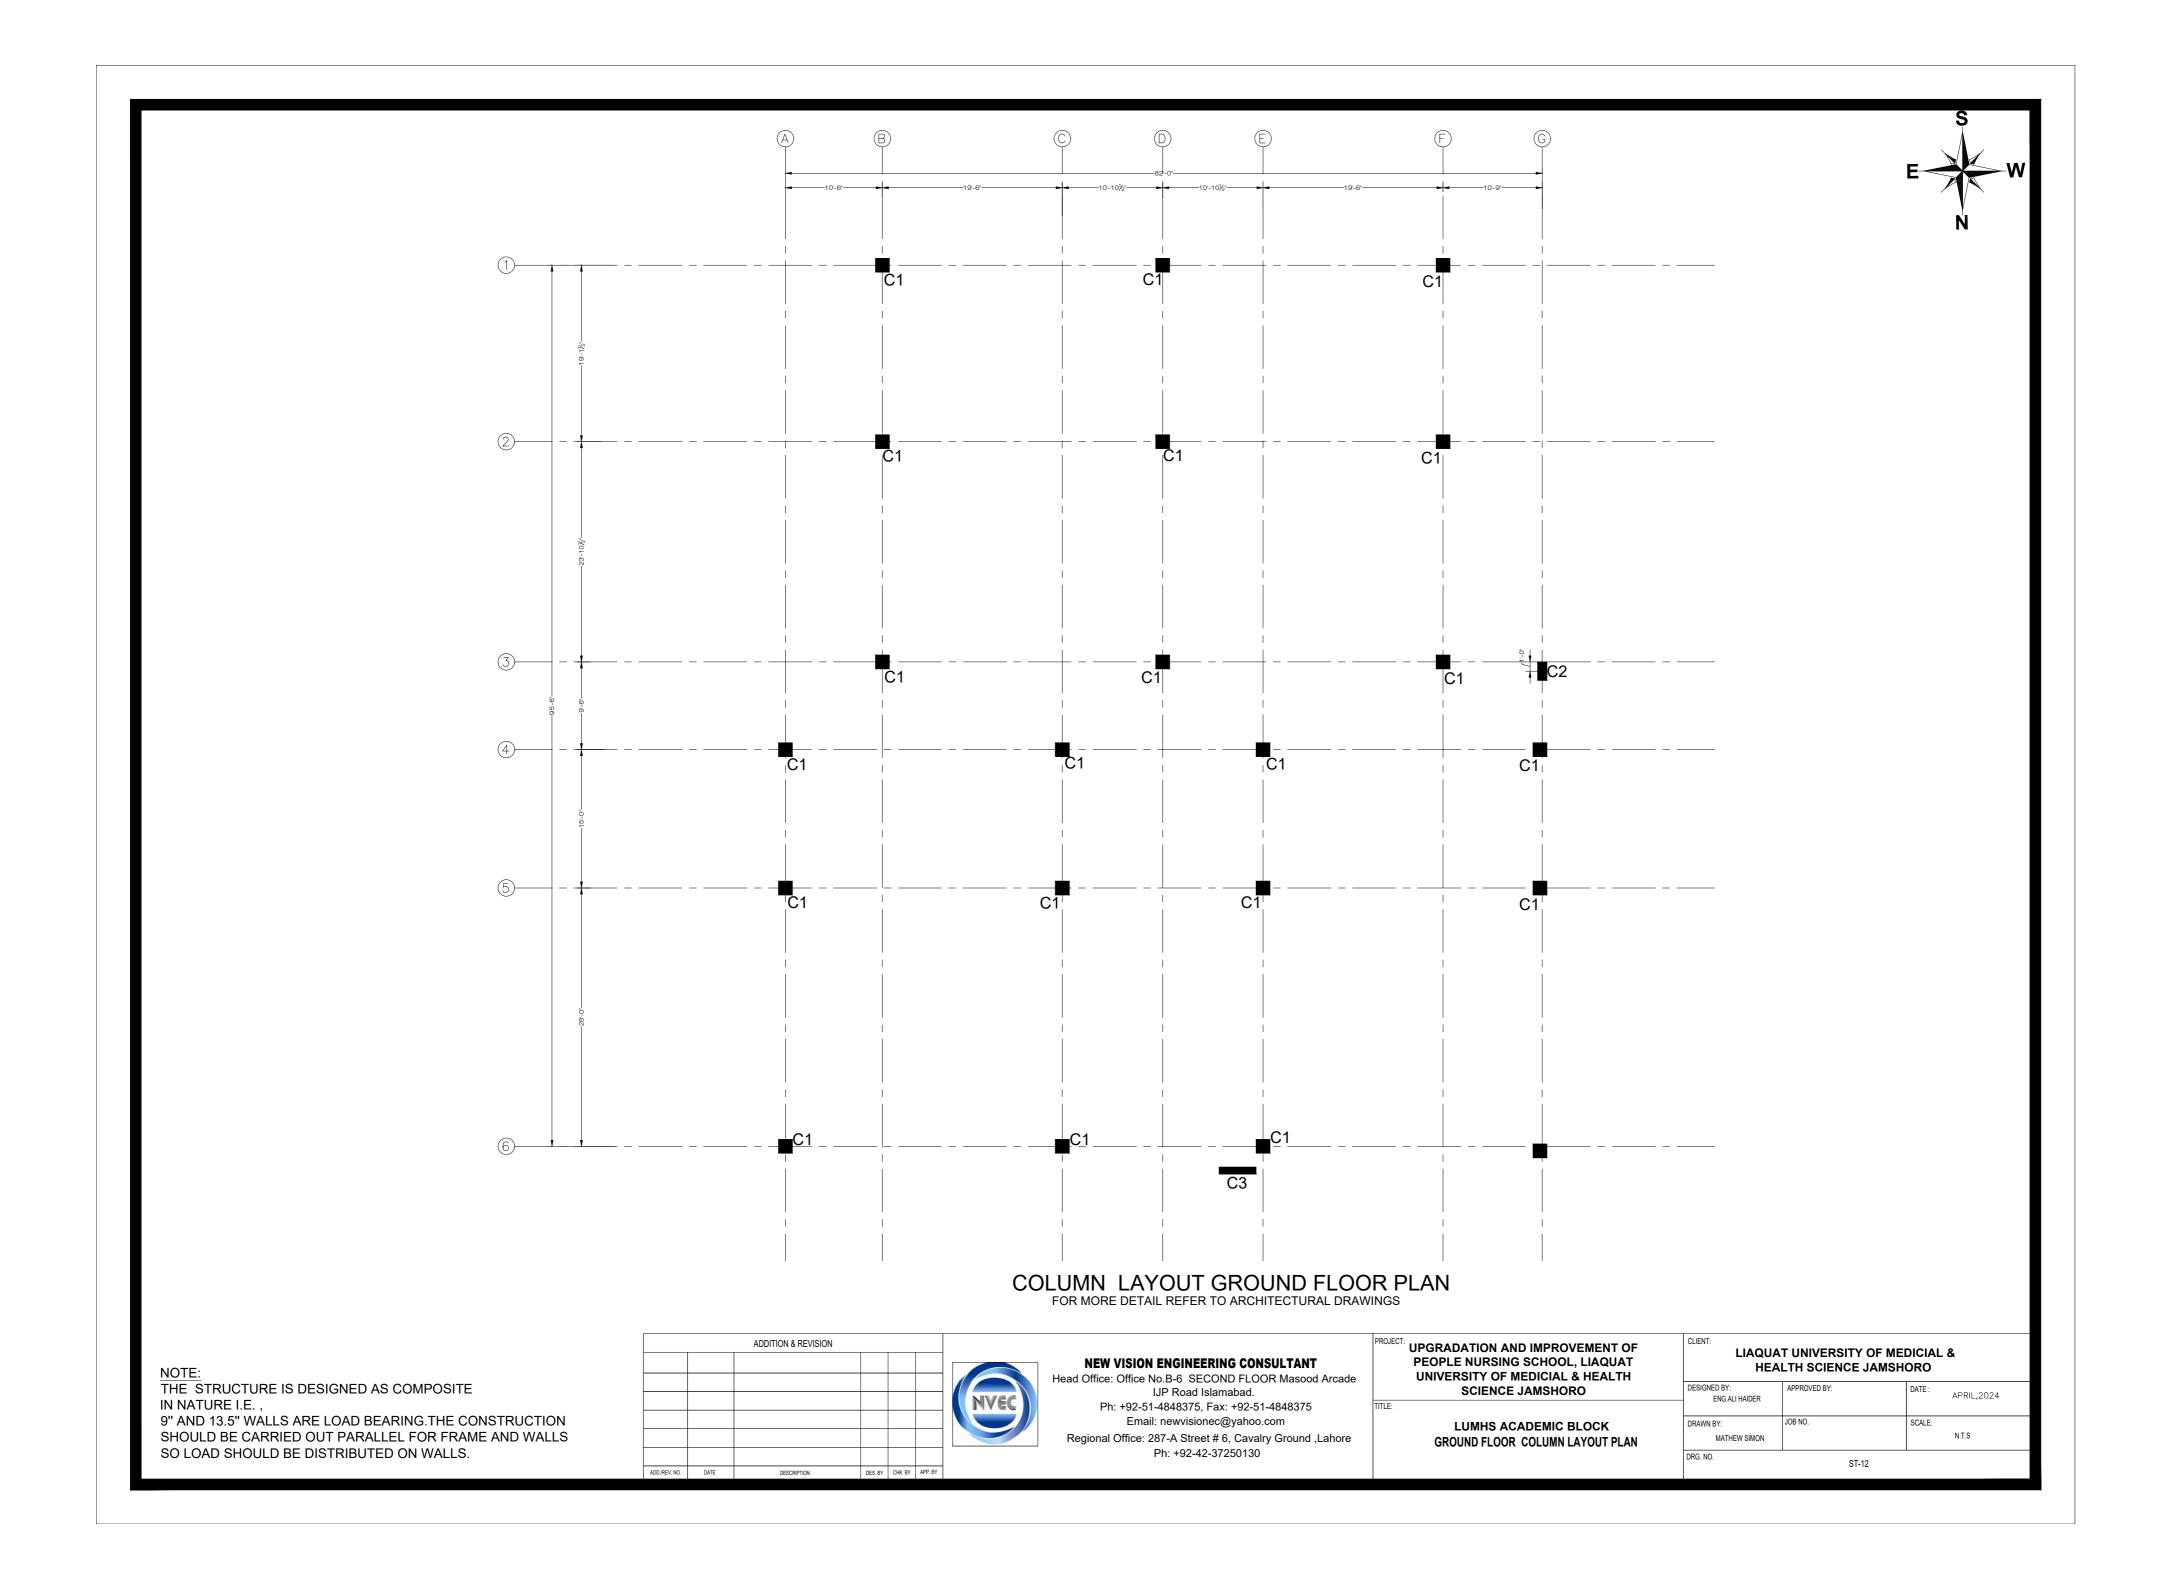

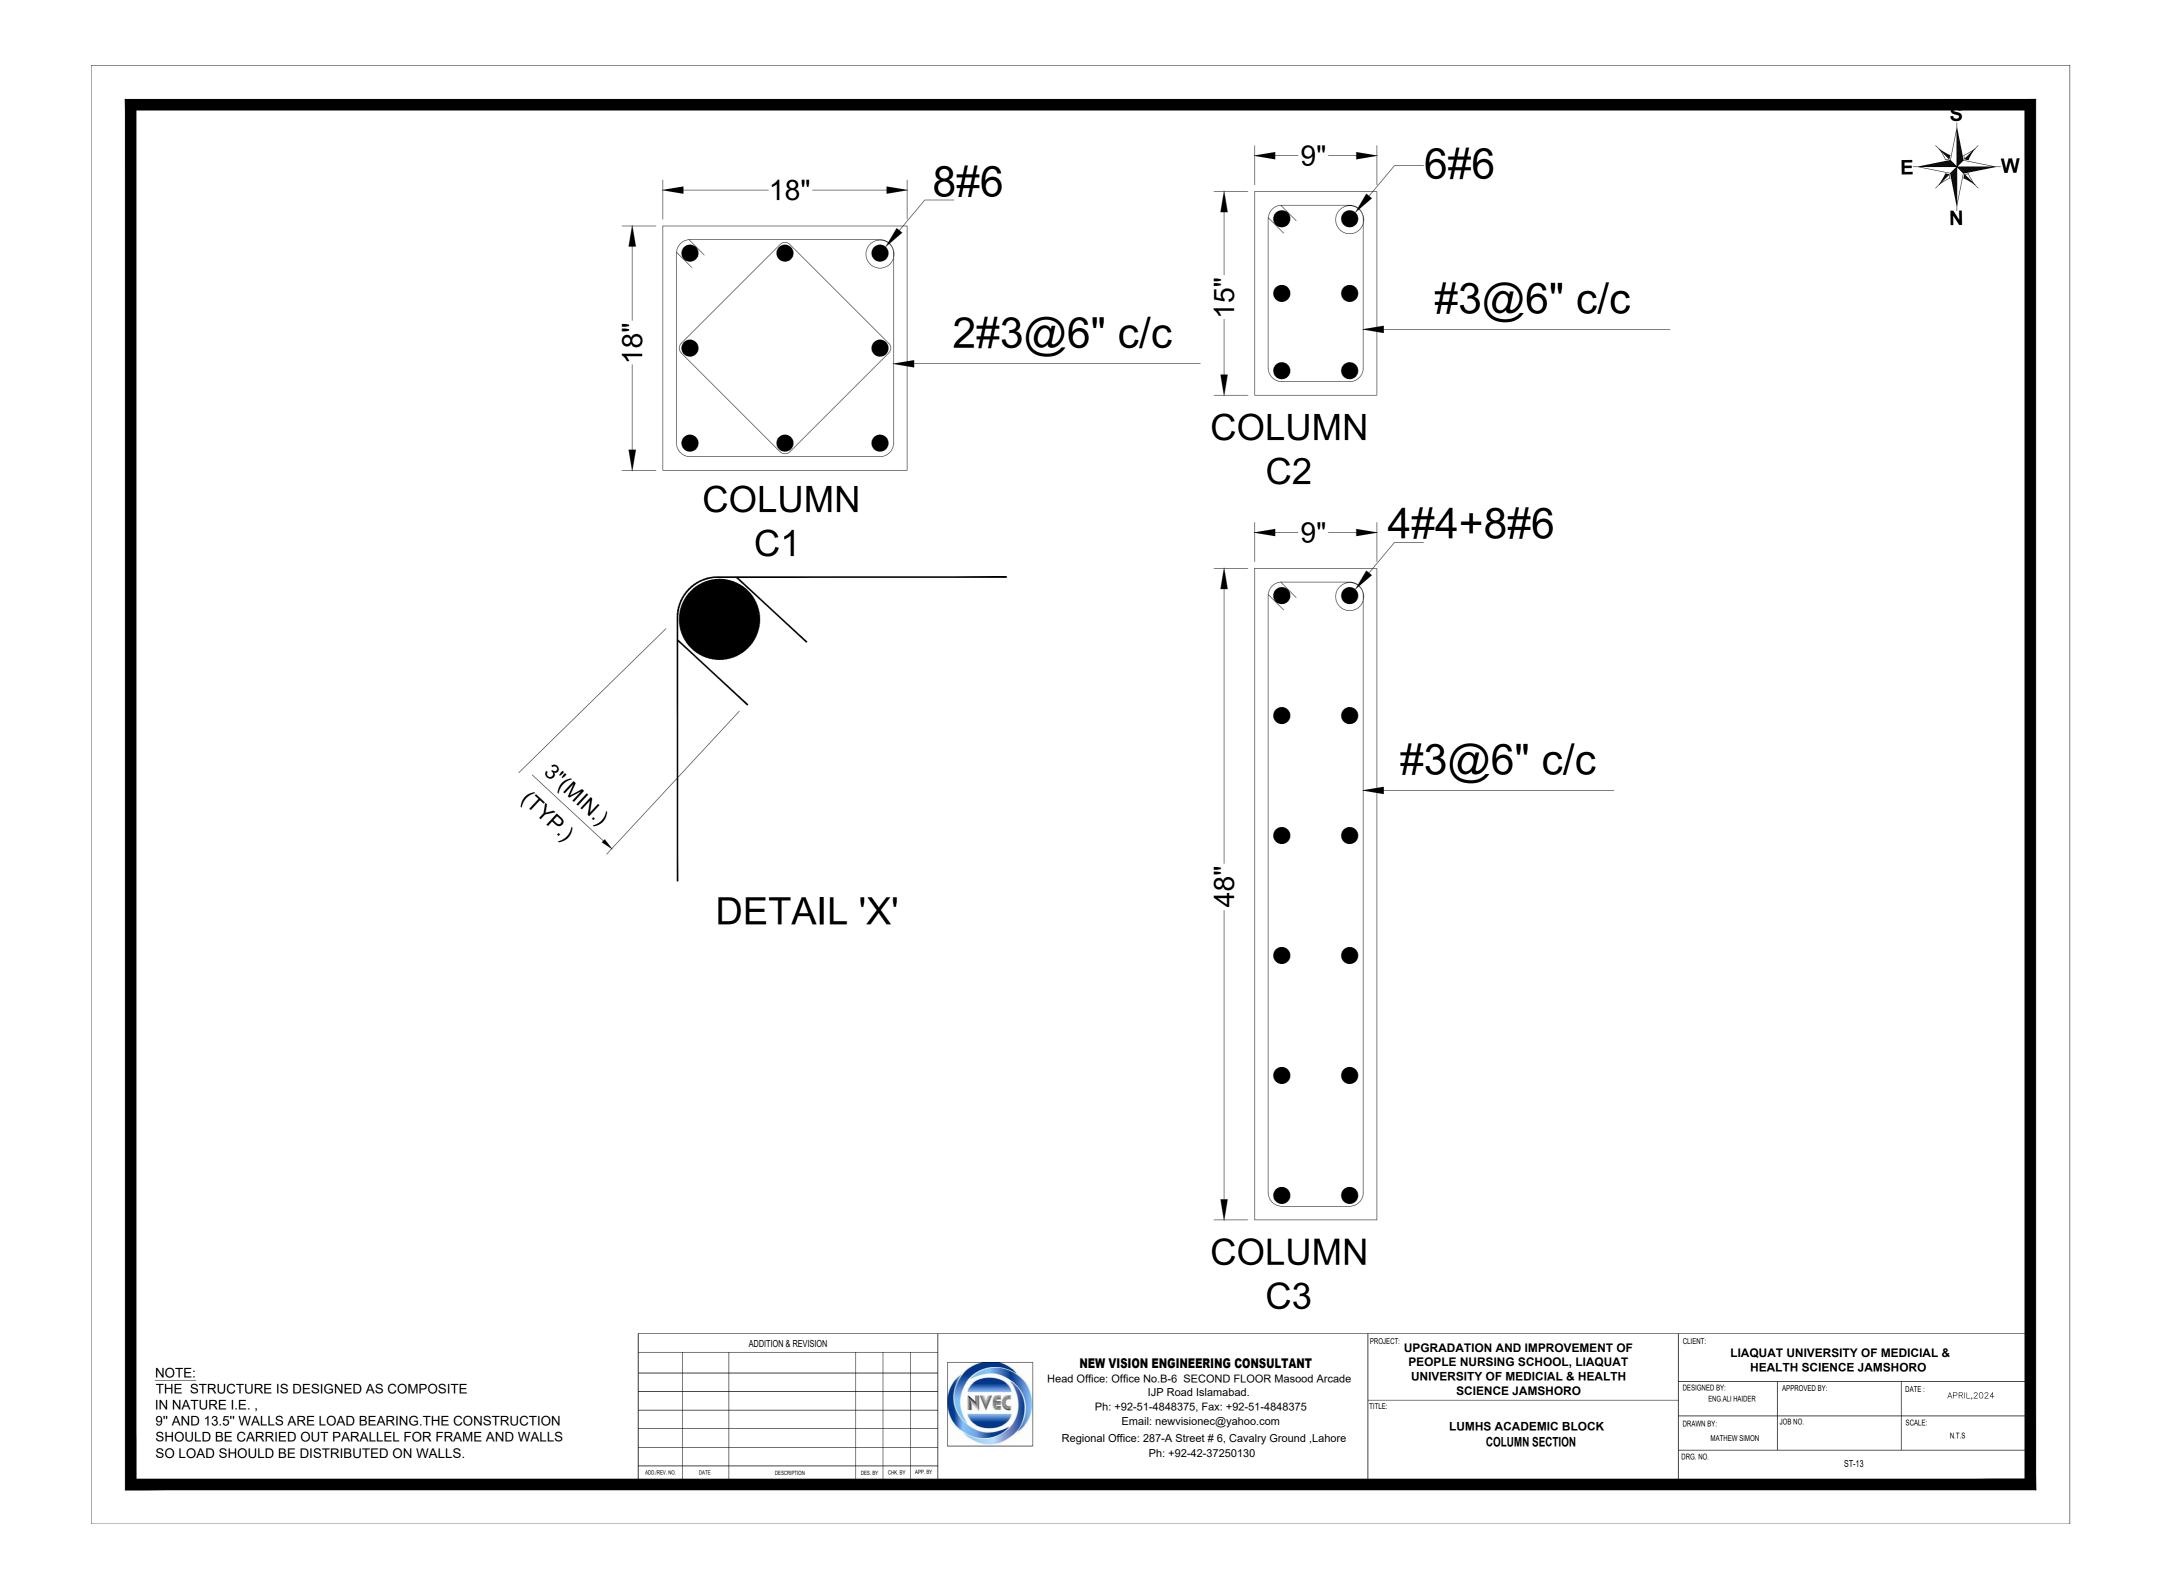

MID. SUPP. TYPICAL SEC. OF PB1

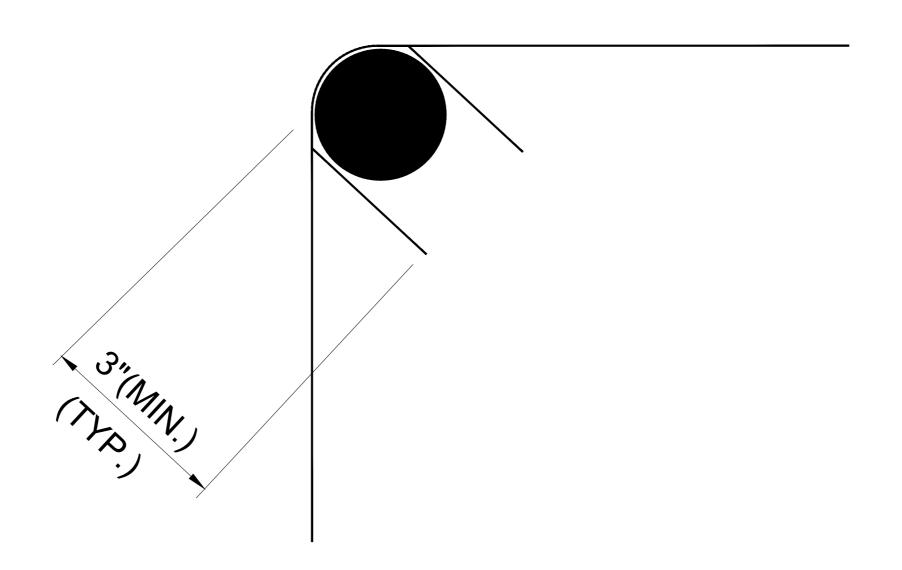

NOTE:

THE STRUCTURE IS DESIGNED AS COMPOSITE IN NATURE I.E.,

9" AND 13.5" WALLS ARE LOAD BEARING. THE CONSTRUCTION SHOULD BE CARRIED OUT PARALLEL FOR FRAME AND WALLS SO LOAD SHOULD BE DISTRIBUTED ON WALLS.

ADDITION & REVISION										
	ADD./REV. NO.	DATE	DESCRIPTION	DES. BY	CHK. BY	APP. BY				

NVEC

NEW VISION ENGINEERING CONSULTANT

Head Office: Office No.B-6 SECOND FLOOR Masood Arcade IJP Road Islamabad.
Ph: +92-51-4848375, Fax: +92-51-4848375
Email: newvisionec@yahoo.com

Regional Office: 287-A Street # 6, Cavalry Ground ,Lahore Ph: +92-42-37250130 PROJECT: UPGRADATION AND IMPROVEMENT OF PEOPLE NURSING SCHOOL, LIAQUAT UNIVERSITY OF MEDICIAL & HEALTH SCIENCE JAMSHORO

LUMHS ACADEMIC BLOCK
PLINTH BEAM SECTION

LIAQUAT UNIVERSITY OF MEDICIAL & HEALTH SCIENCE JAMSHORO


DESIGNED BY:
ENG ALI HAIDER

APPROVED BY:
DATE:
APRIL,2024


DRAWN BY:
MATHEW SIMON


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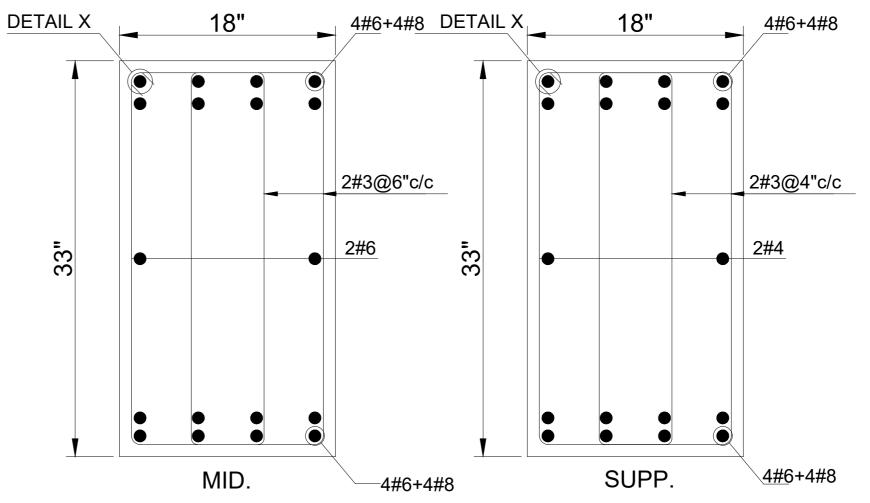
ST-15



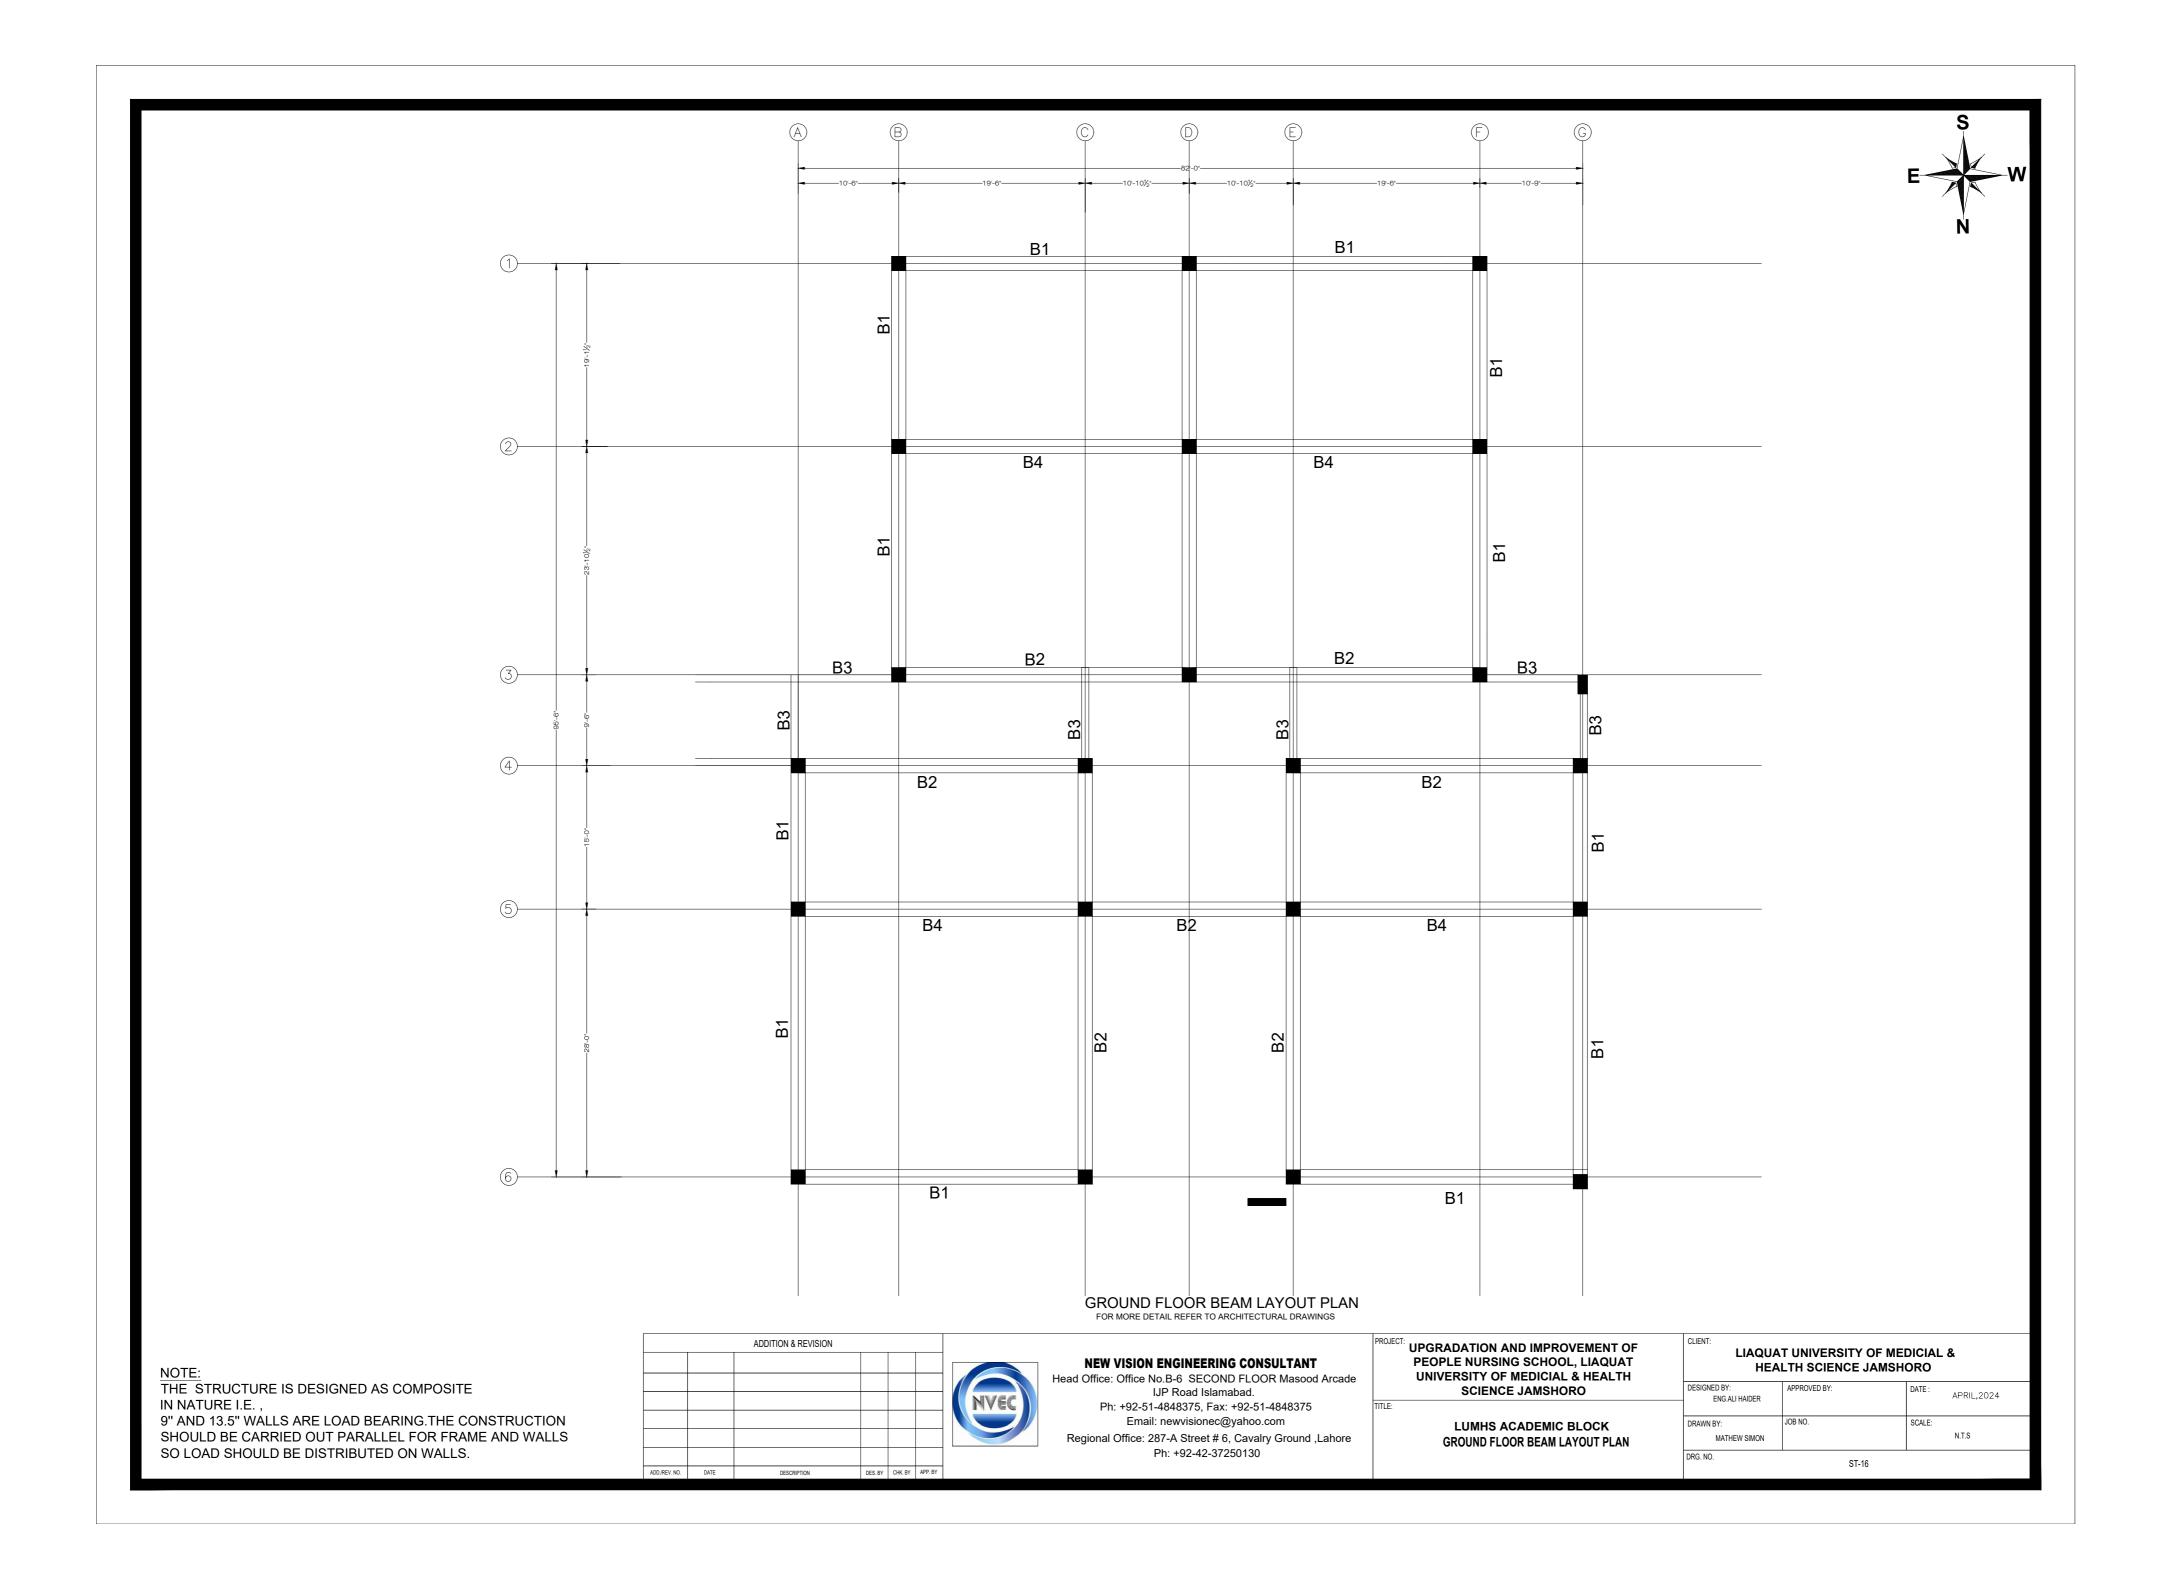



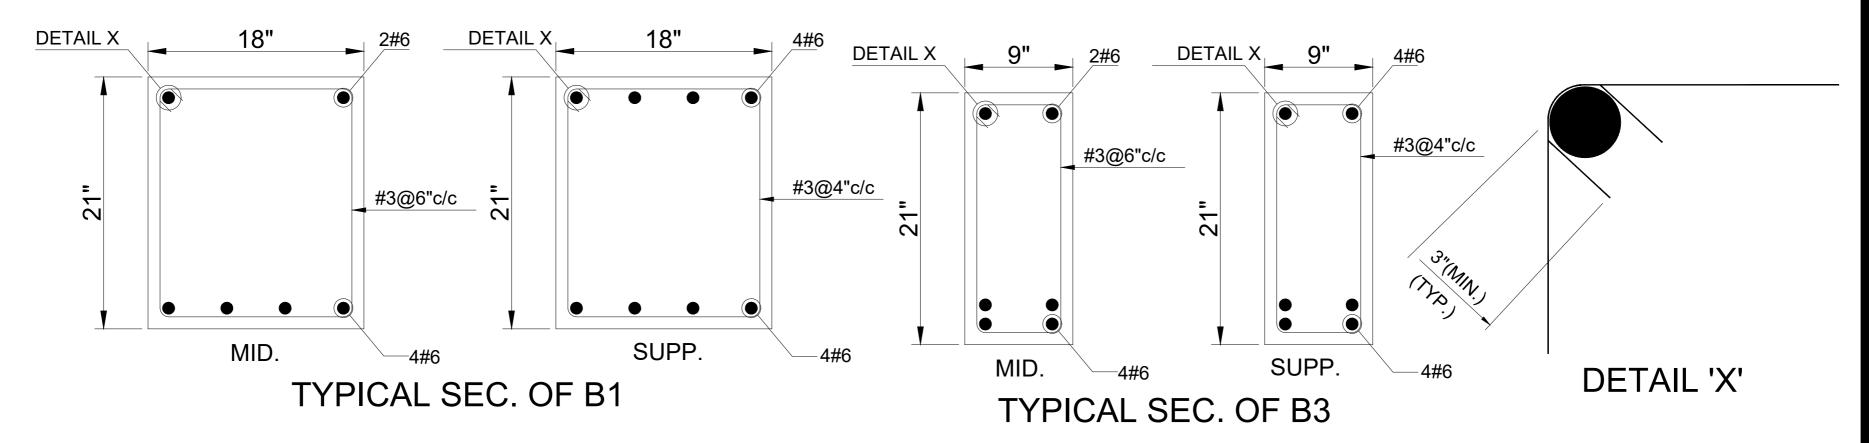

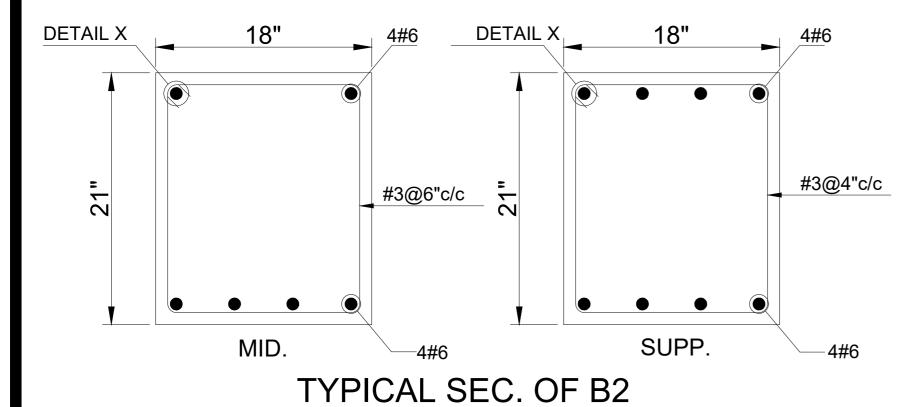

TYPICAL SEC. OF B4

NOTE

THE STRUCTURE IS DESIGNED AS COMPOSITE IN NATURE I.E. .

9" AND 13.5" WALLS ARE LOAD BEARING.THE CONSTRUCTION SHOULD BE CARRIED OUT PARALLEL FOR FRAME AND WALLS SO LOAD SHOULD BE DISTRIBUTED ON WALLS.

ADDITION & REVISION							
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ADD./REV. NO.	DATE	DESCRIPTION	DES. BY	CHK. BY	APP. BY		


NEW VISION ENGINEERING CONSULTANT Head Office: Office No.B-6 SECOND FLOOR Masood


Head Office: Office No.B-6 SECOND FLOOR Masood Arcade
IJP Road Islamabad.
Ph: +92-51-4848375, Fax: +92-51-4848375
Email: newvisionec@yahoo.com
Regional Office: 287-A Street # 6 Cayalry Ground Labore


Regional Office: 287-A Street # 6, Cavalry Ground ,Lahore Ph: +92-42-37250130


PROJECT: UPGRADATION AND IMPROVEMENT OF PEOPLE NURSING SCHOOL, LIAQUAT UNIVERSITY OF MEDICIAL & HEALTH SCIENCE JAMSHORO


LUMHS ACADEMIC BLOCK GROUND FLOOR BEAM SECTION LIAQUAT UNIVERSITY OF MEDICIAL & HEALTH SCIENCE JAMSHORO

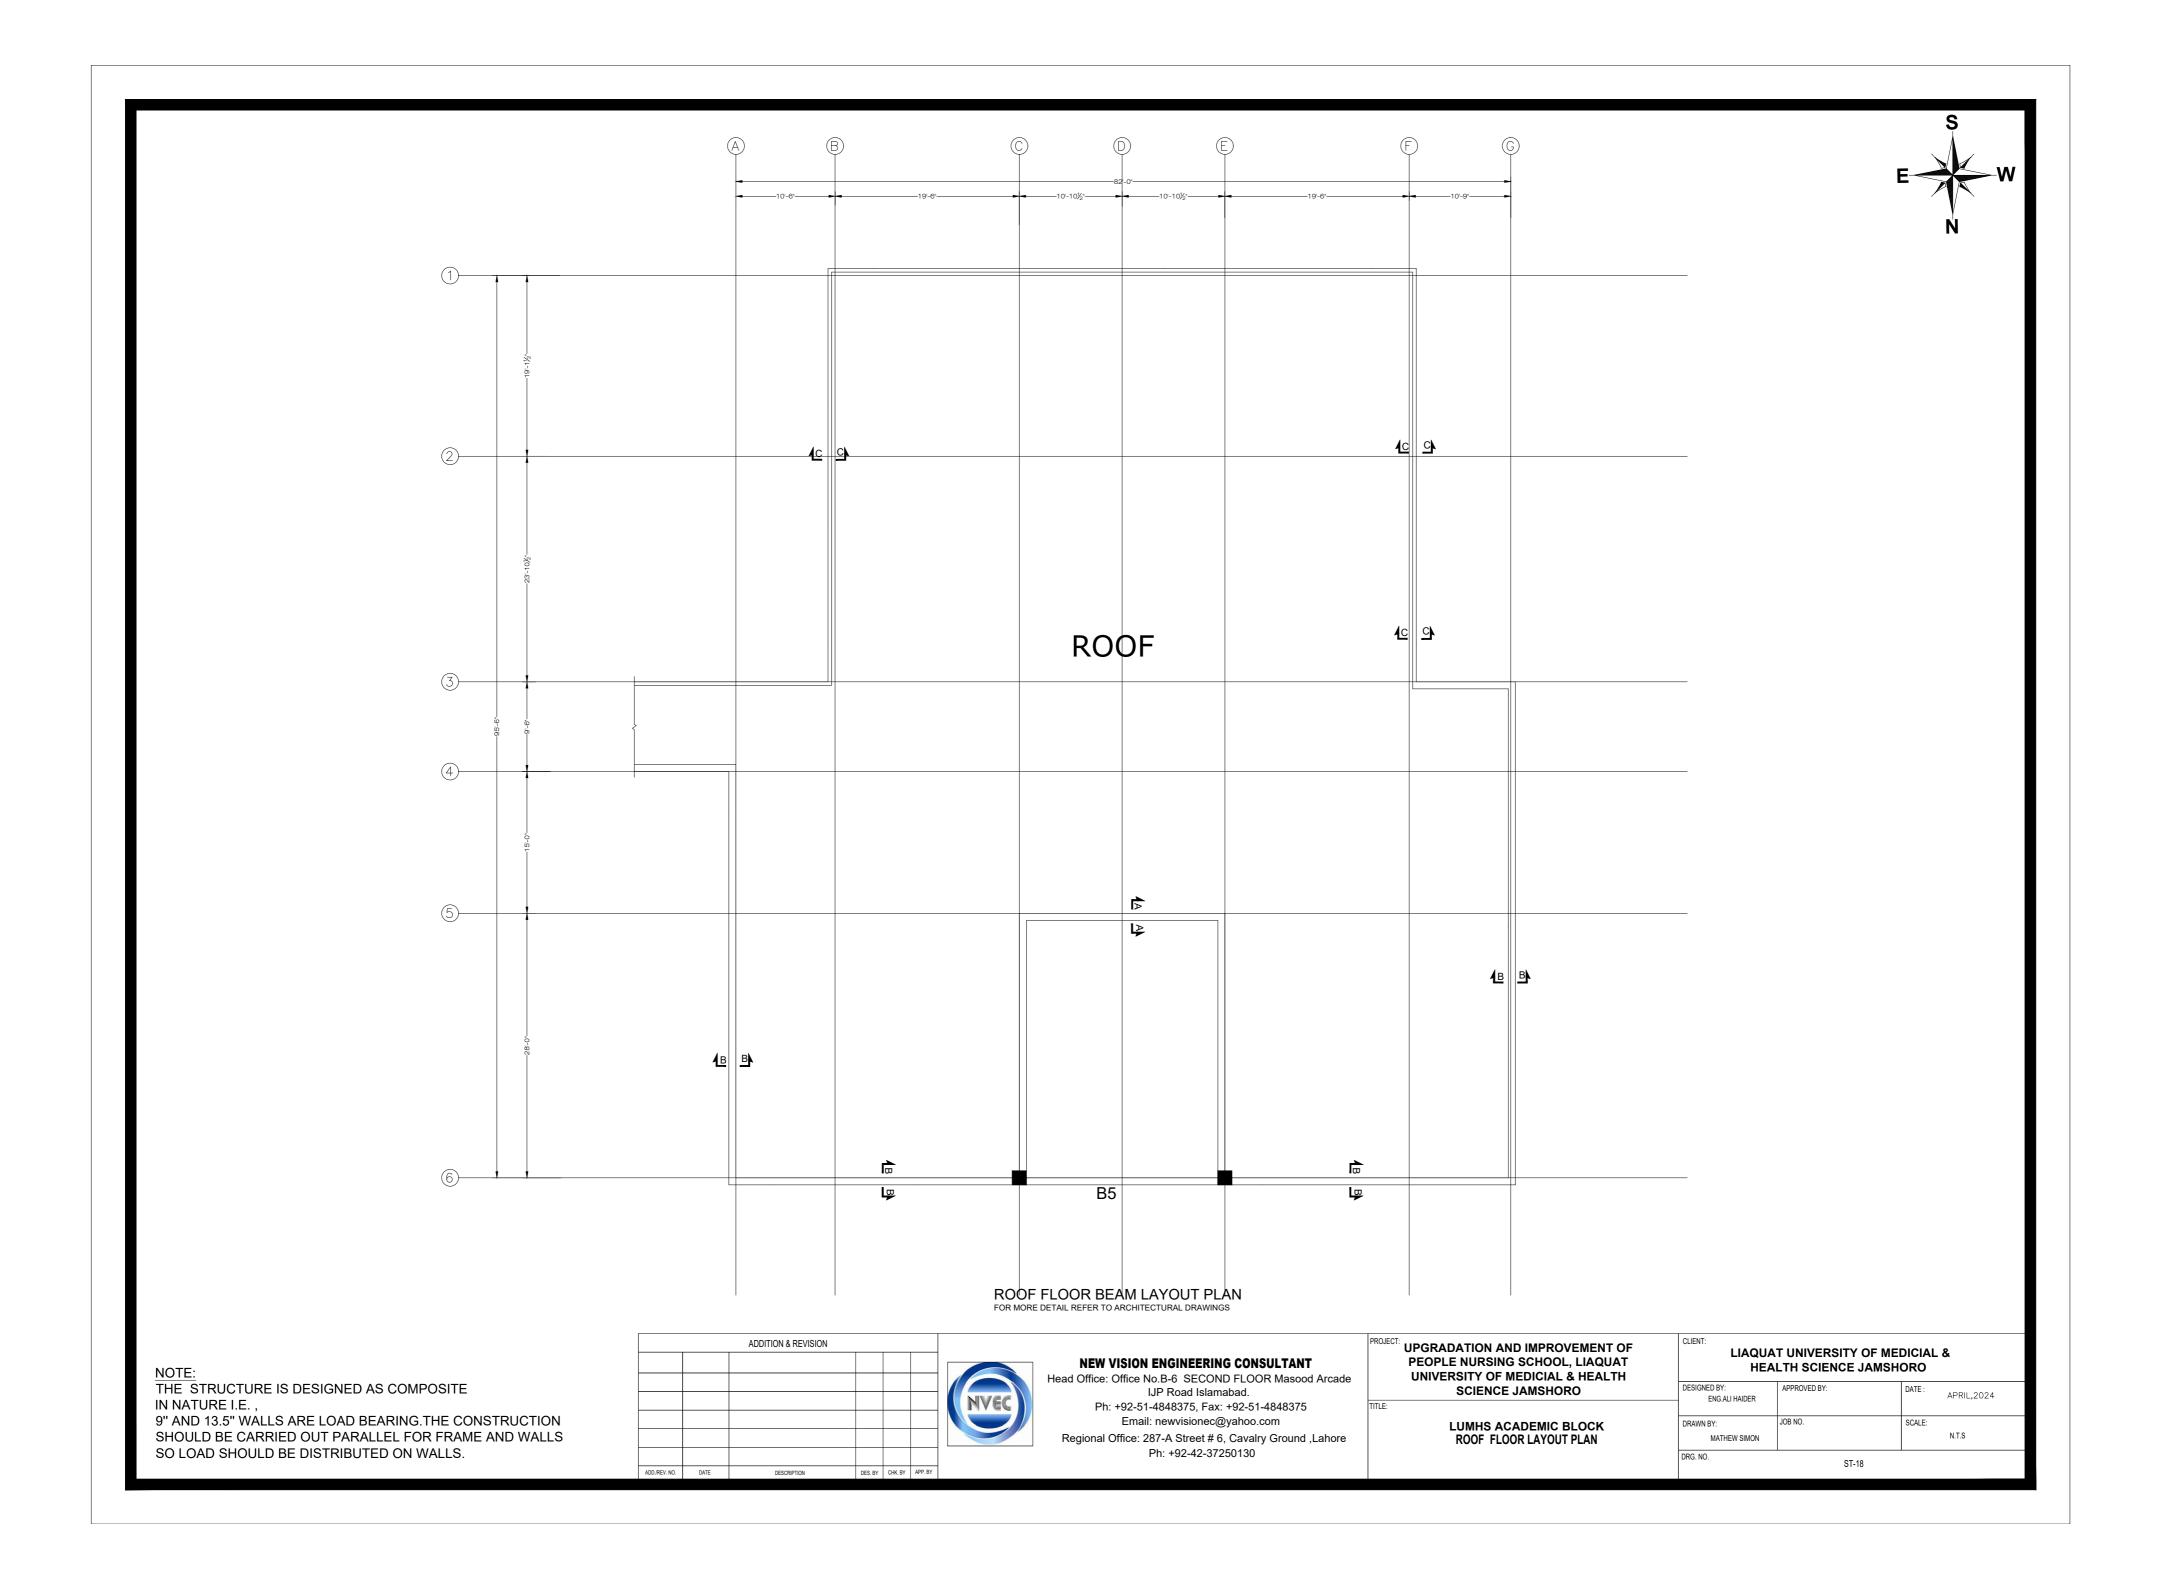


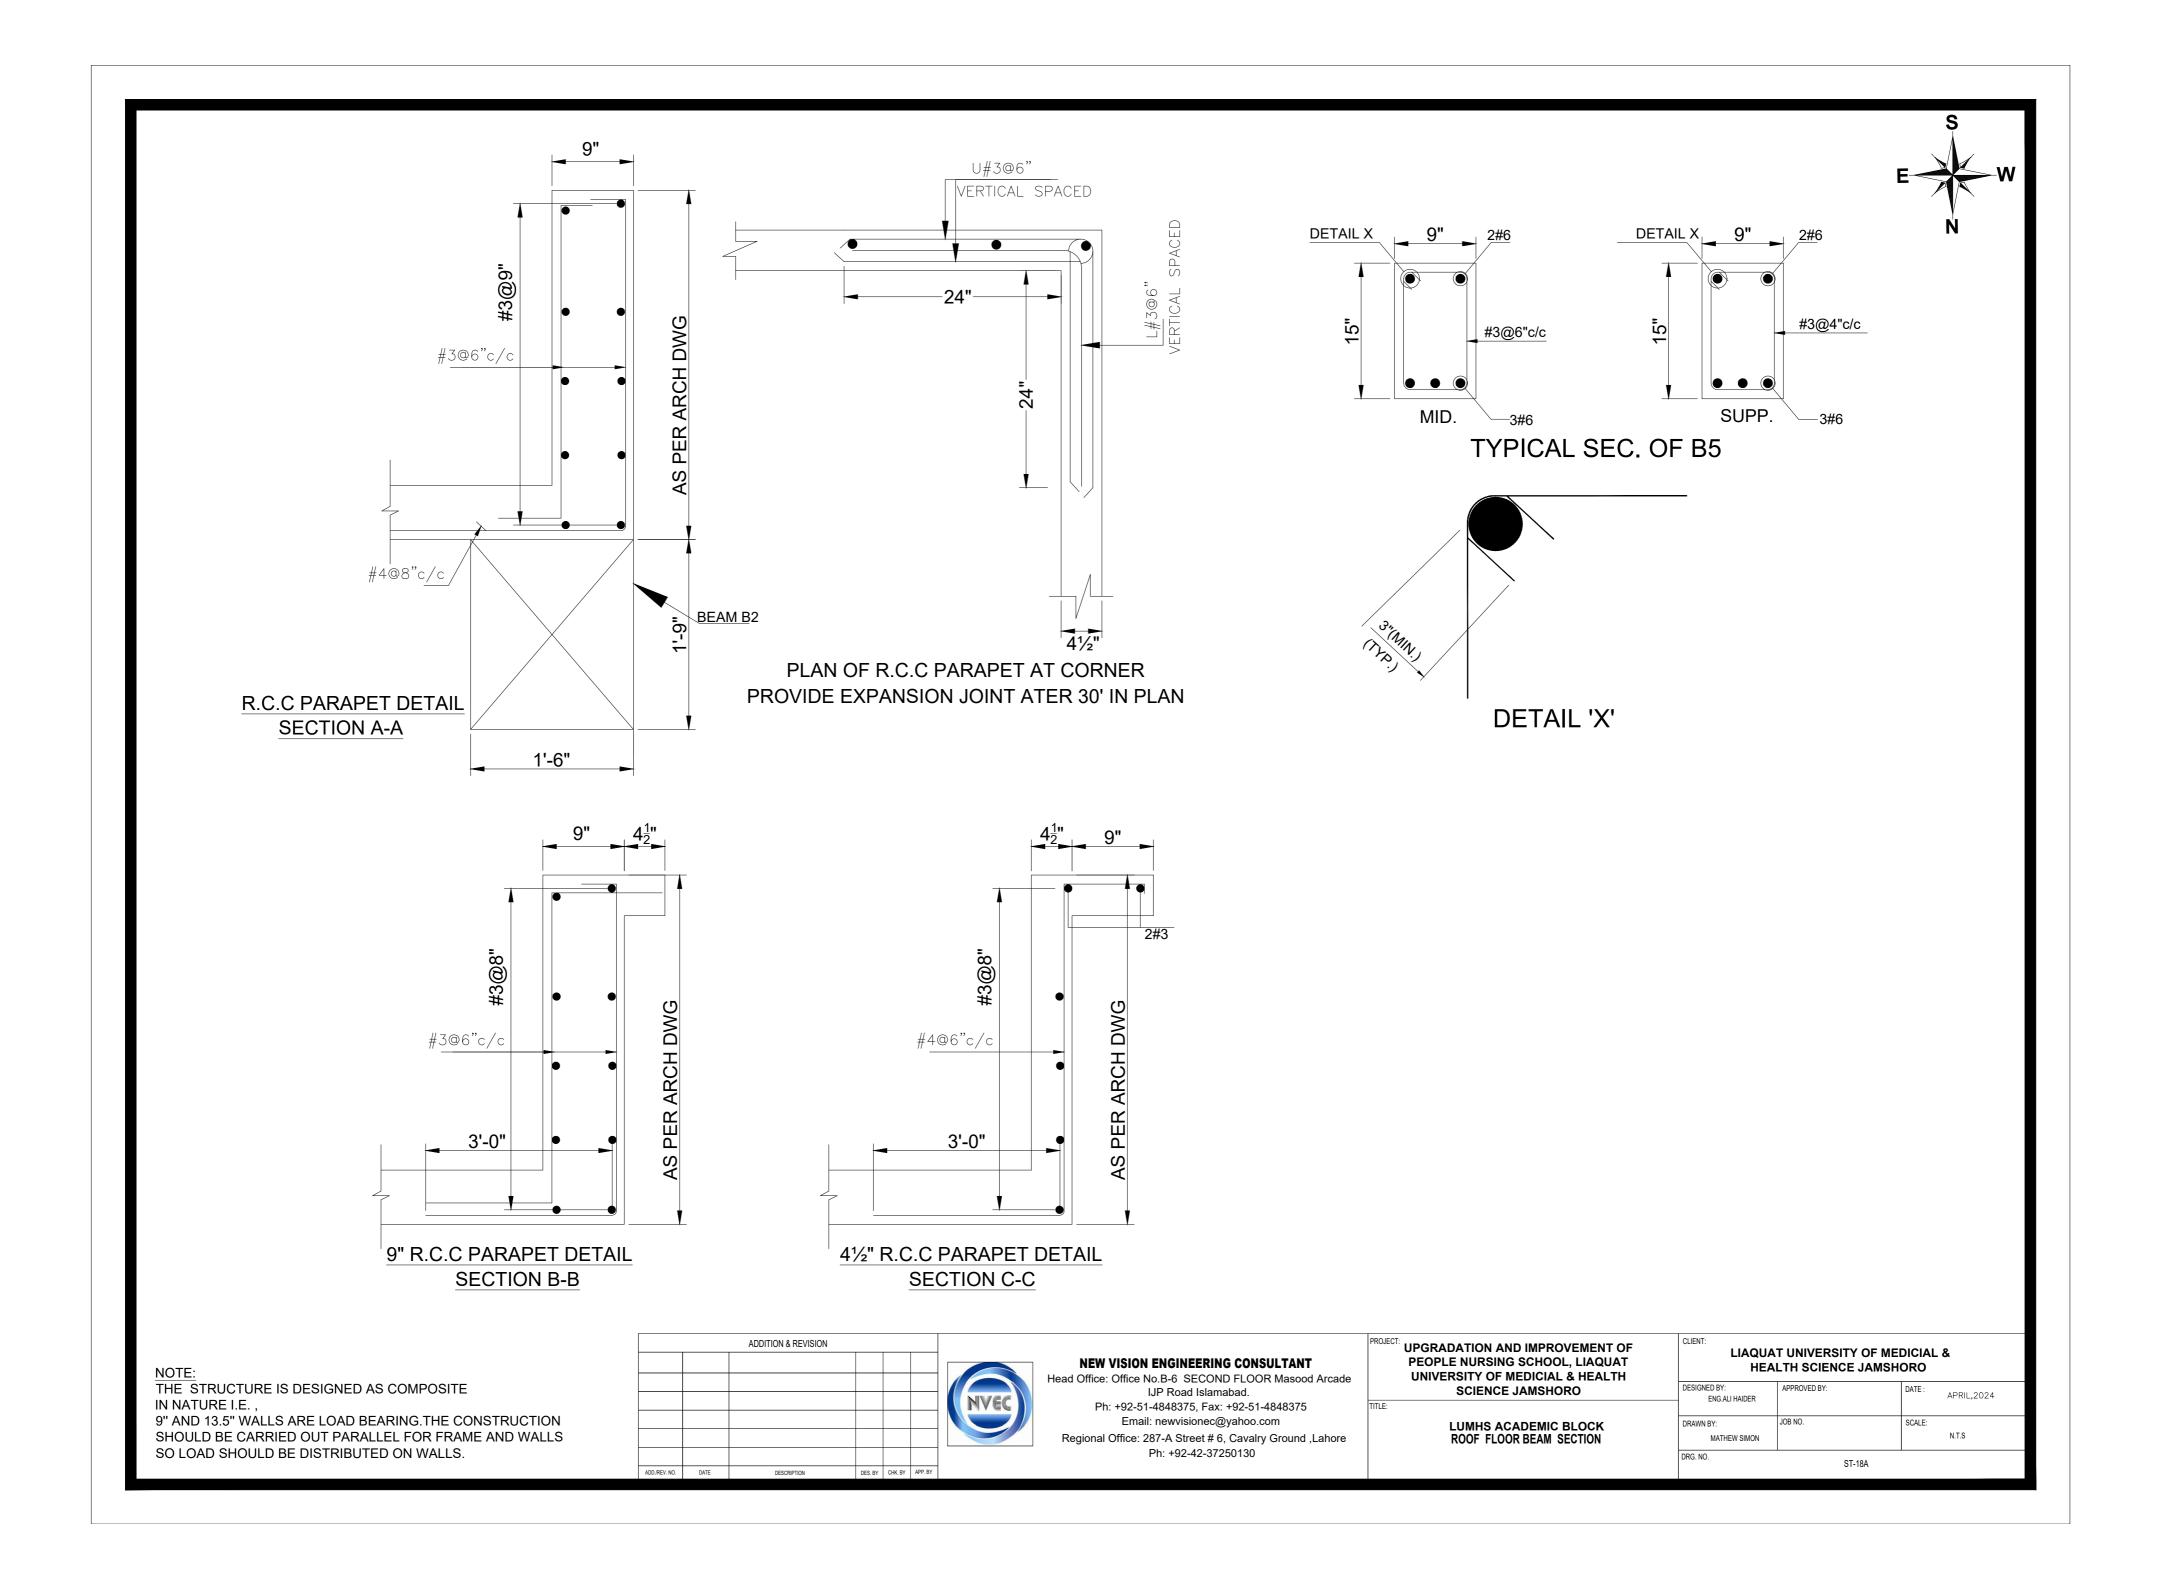


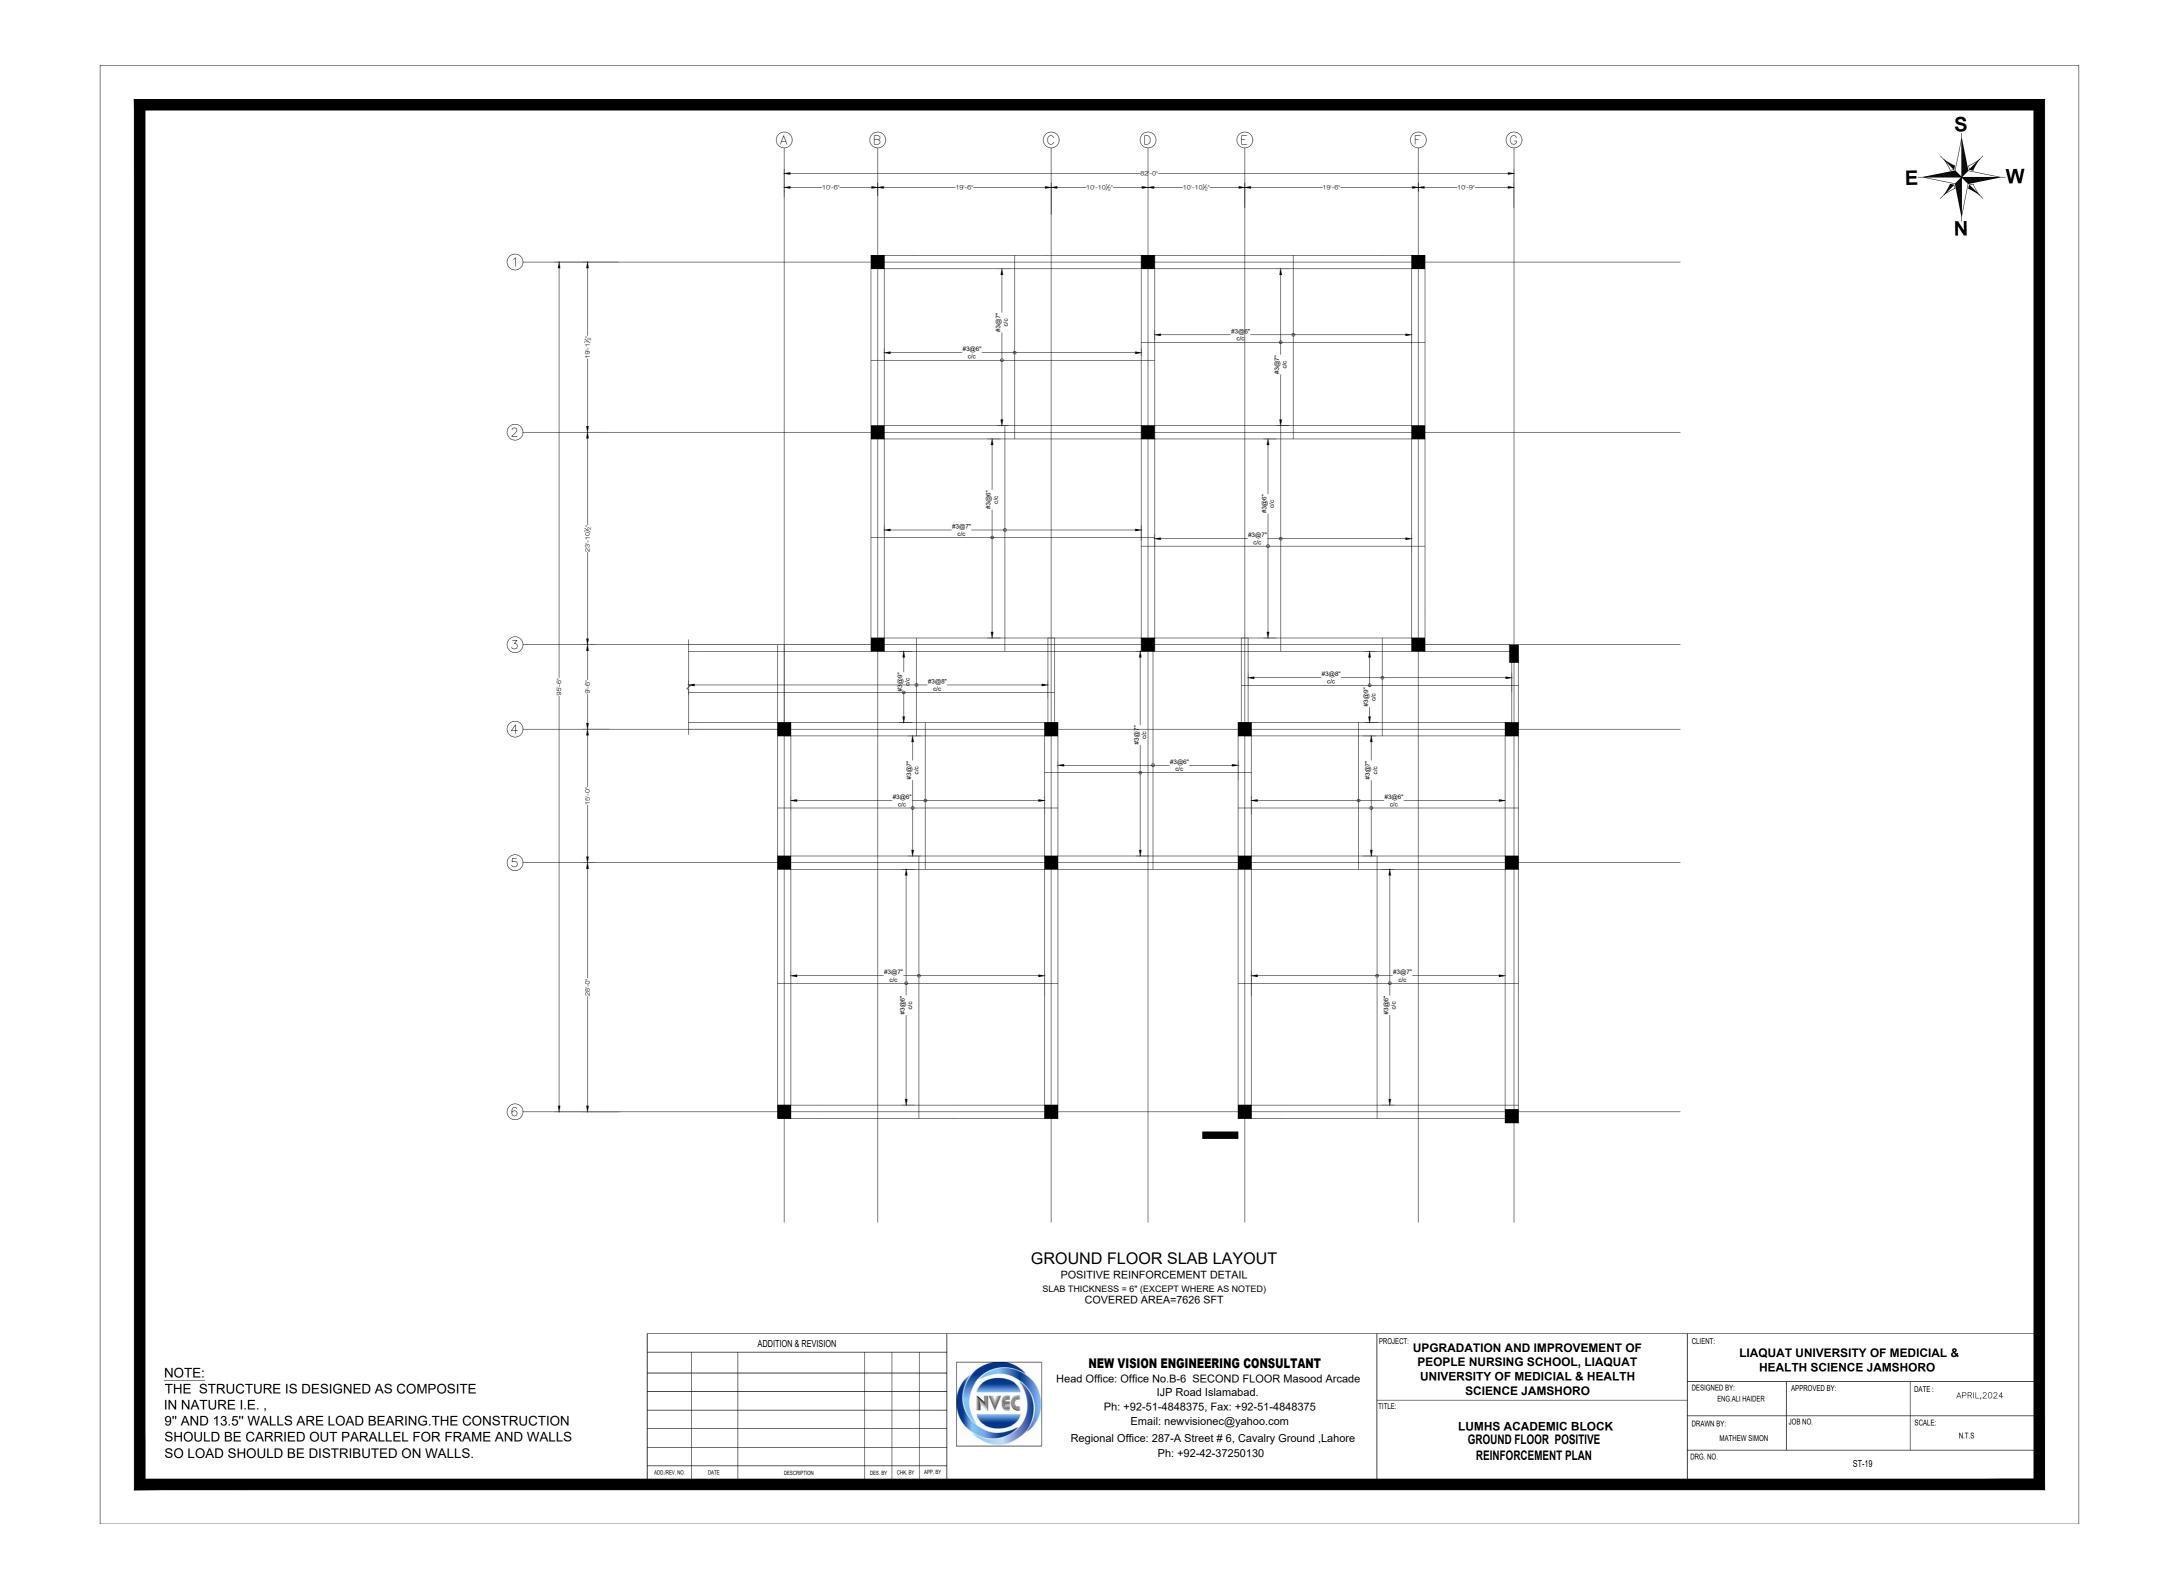

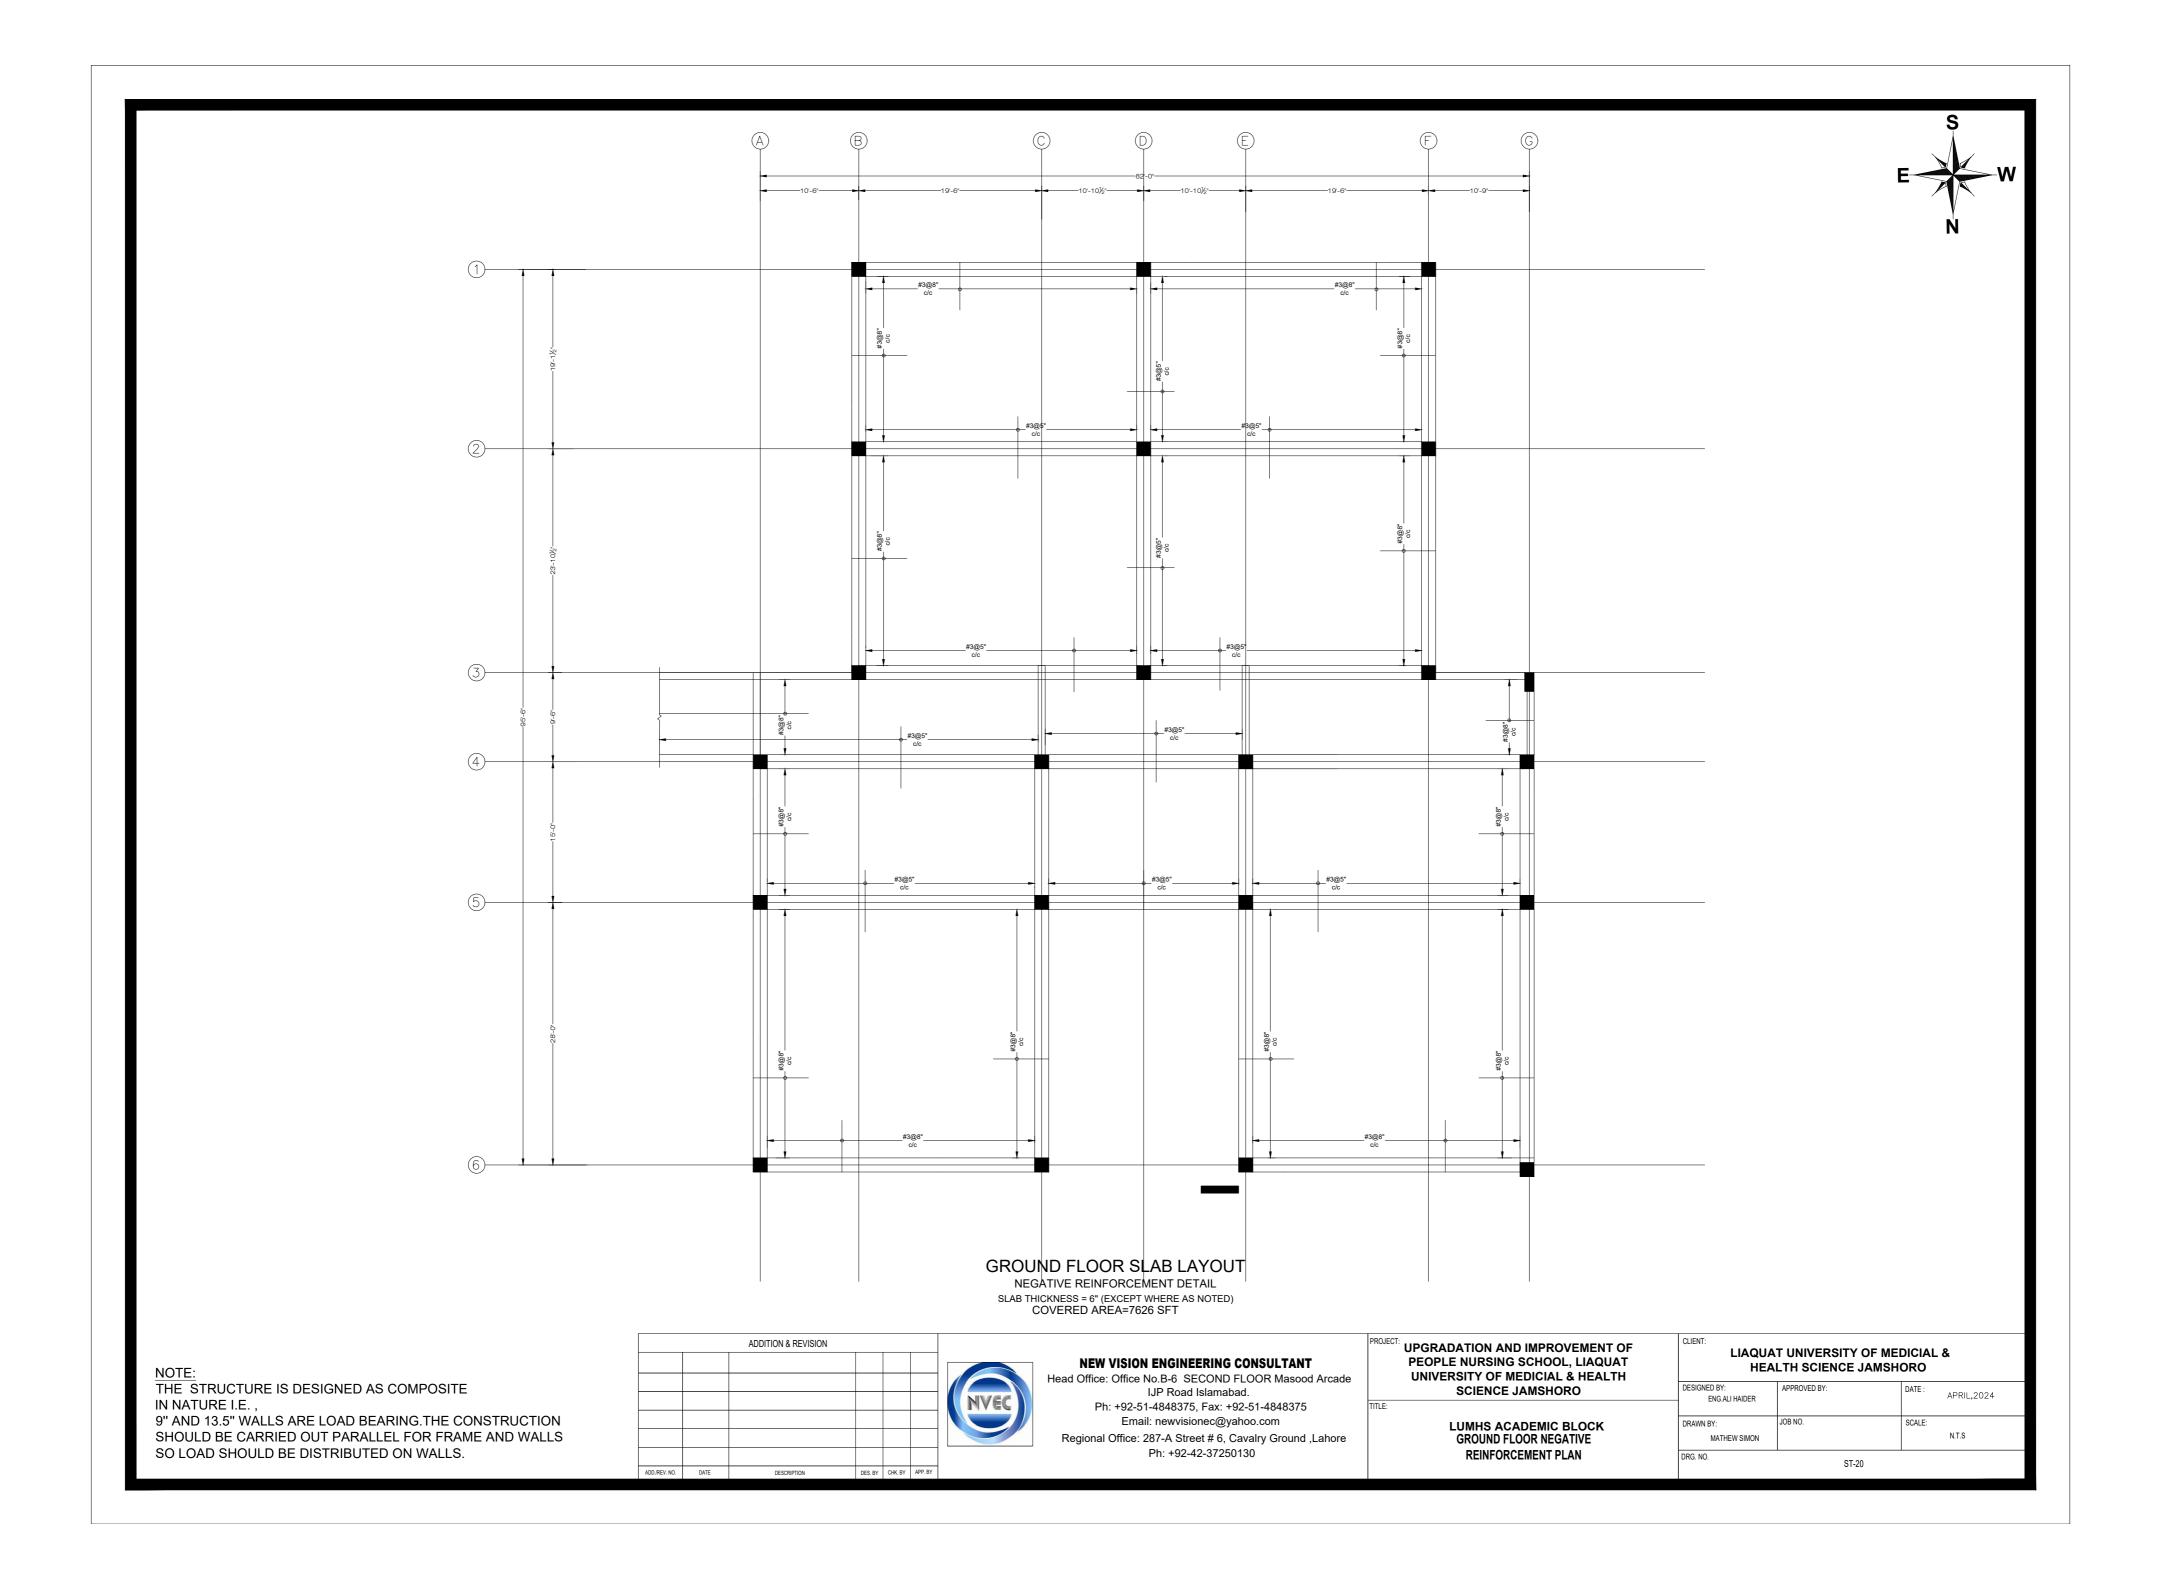

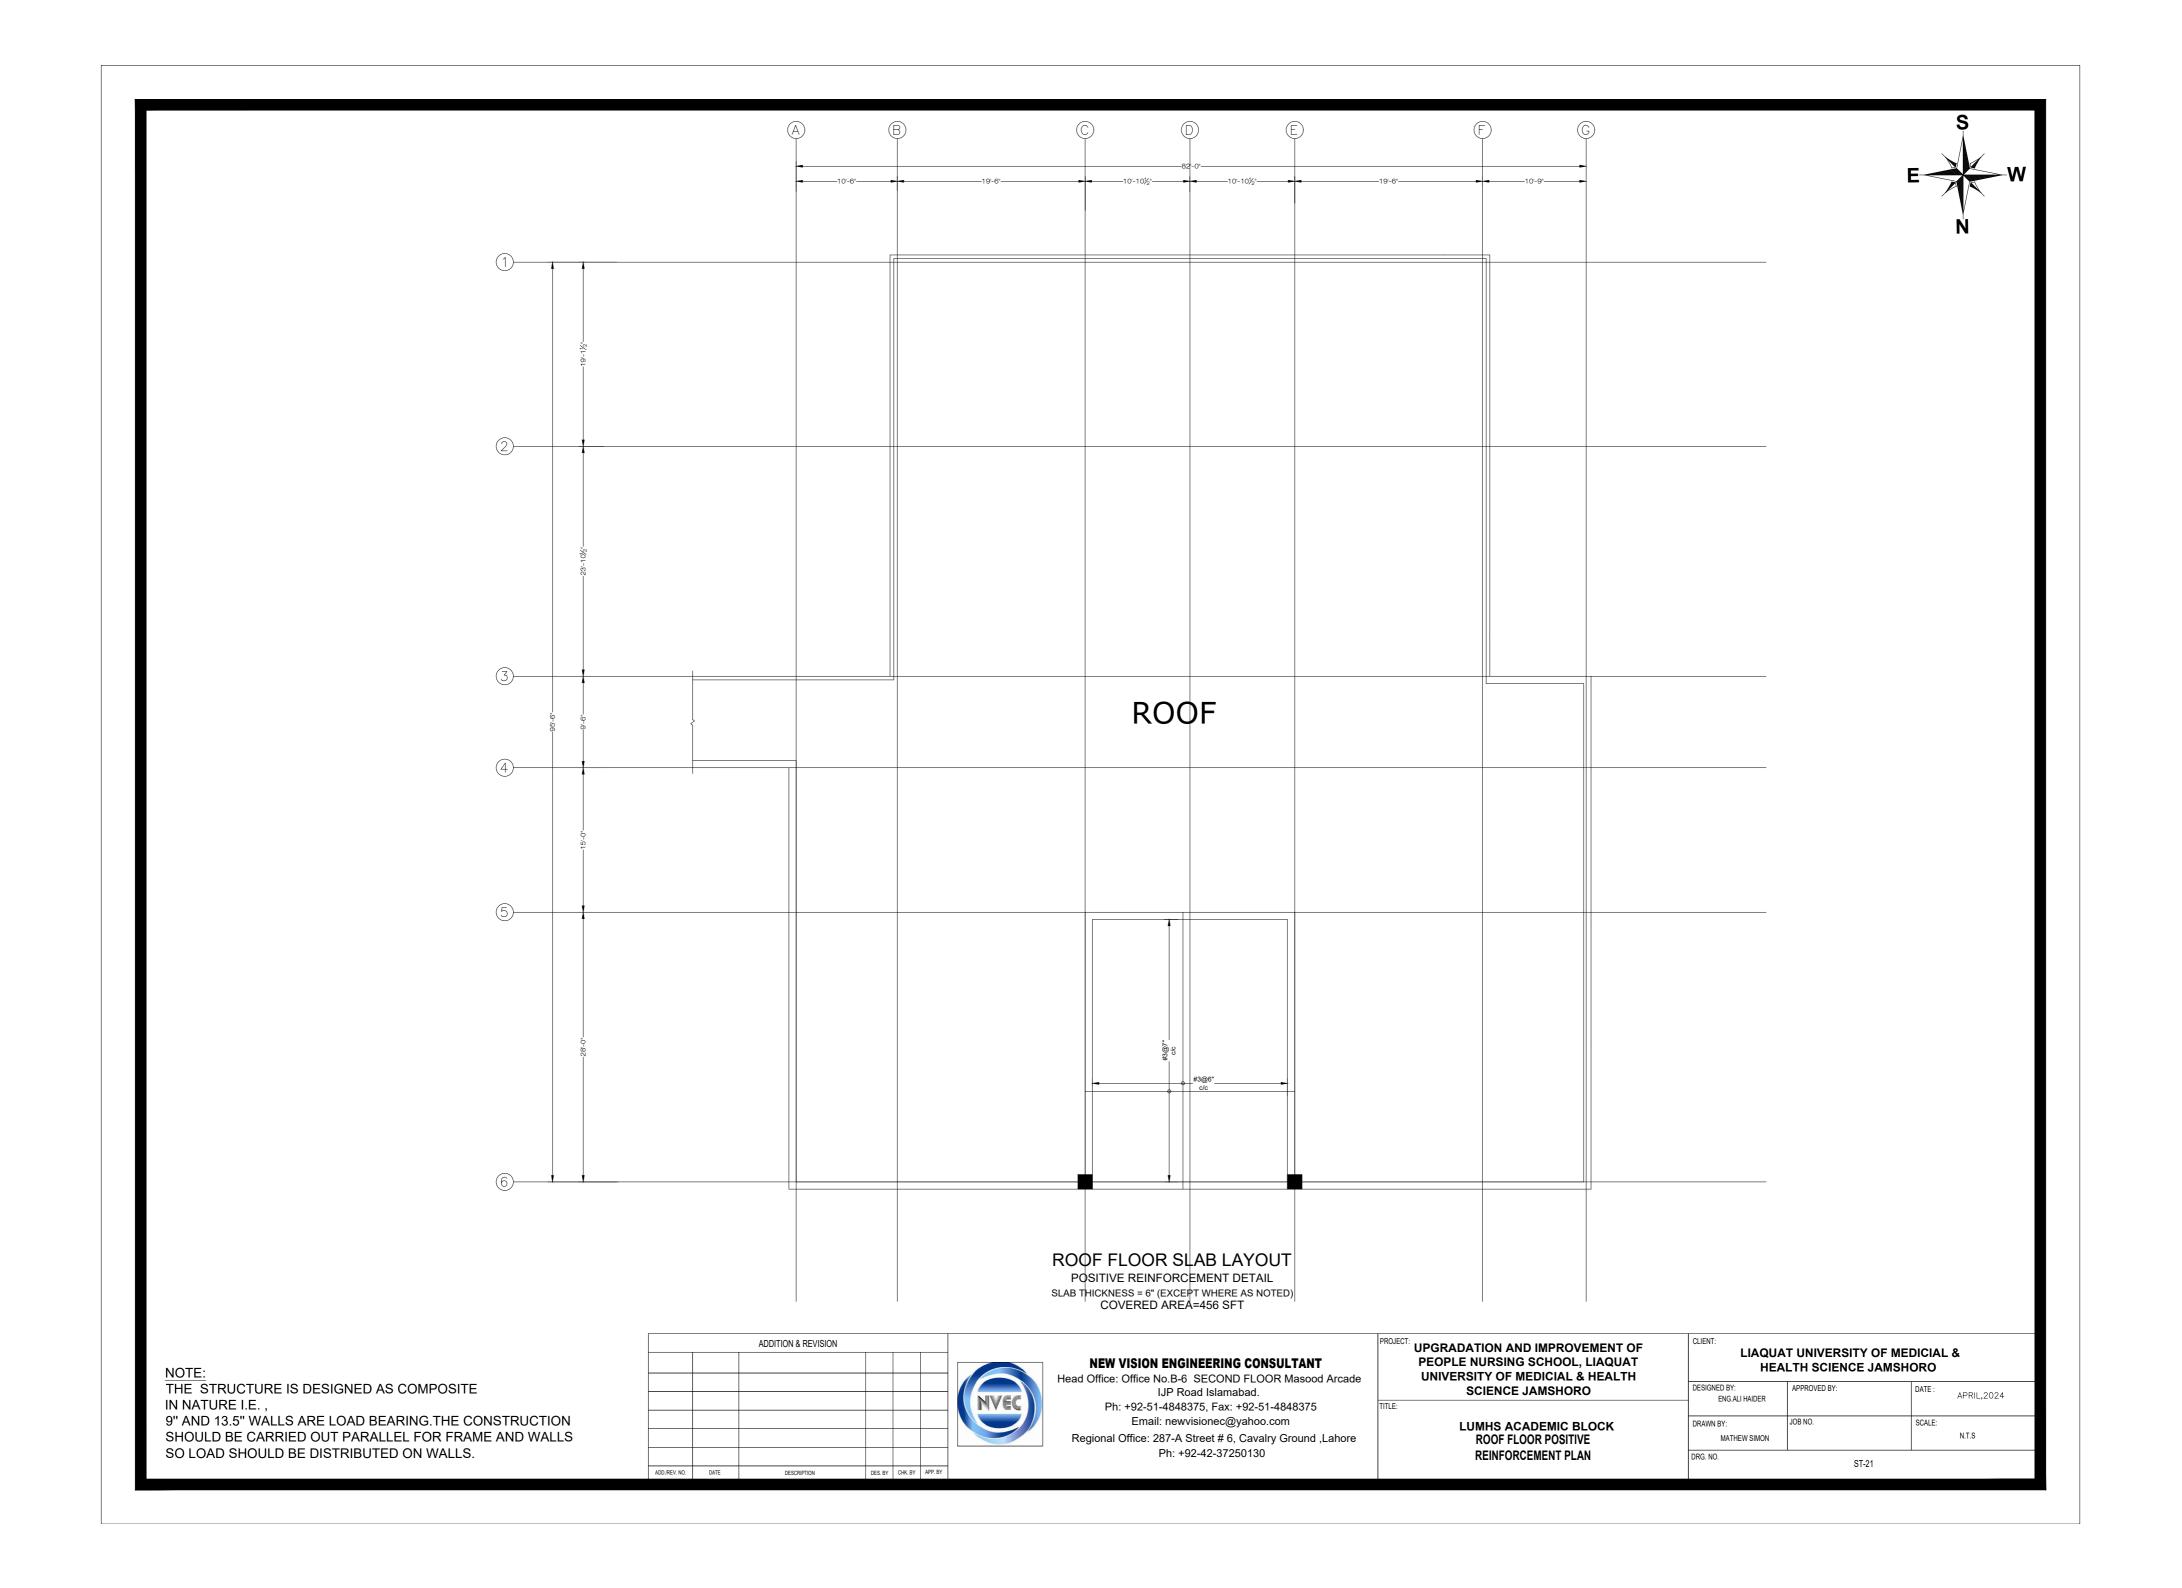

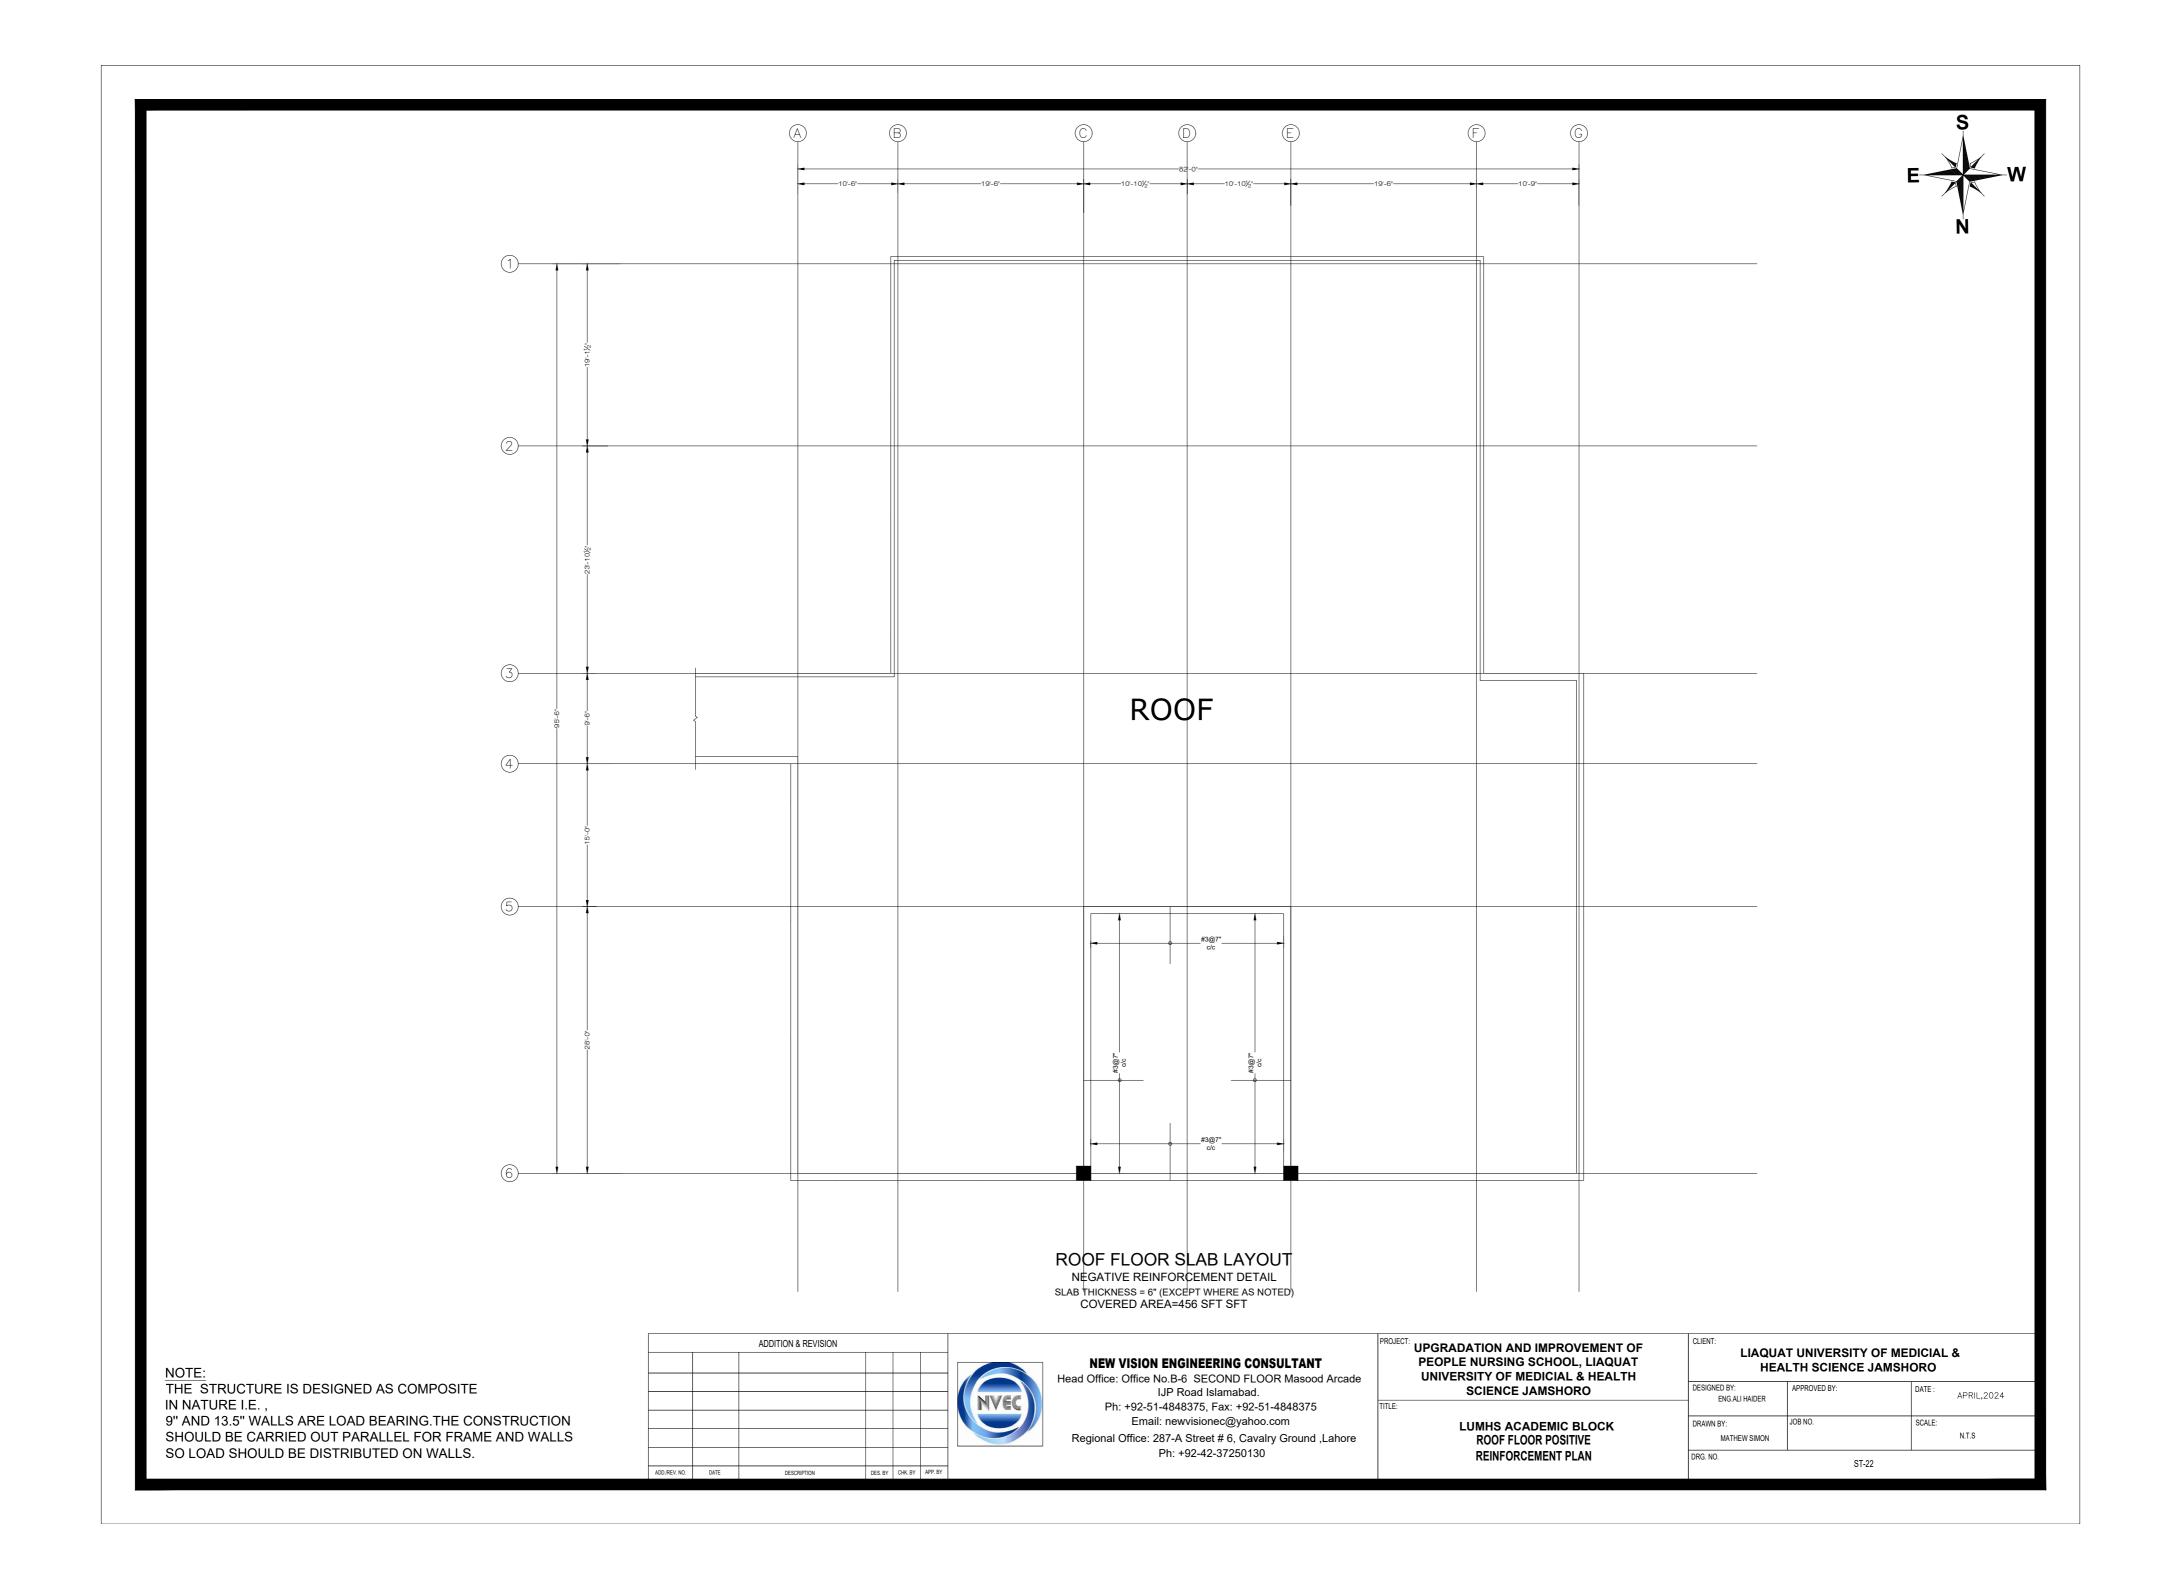

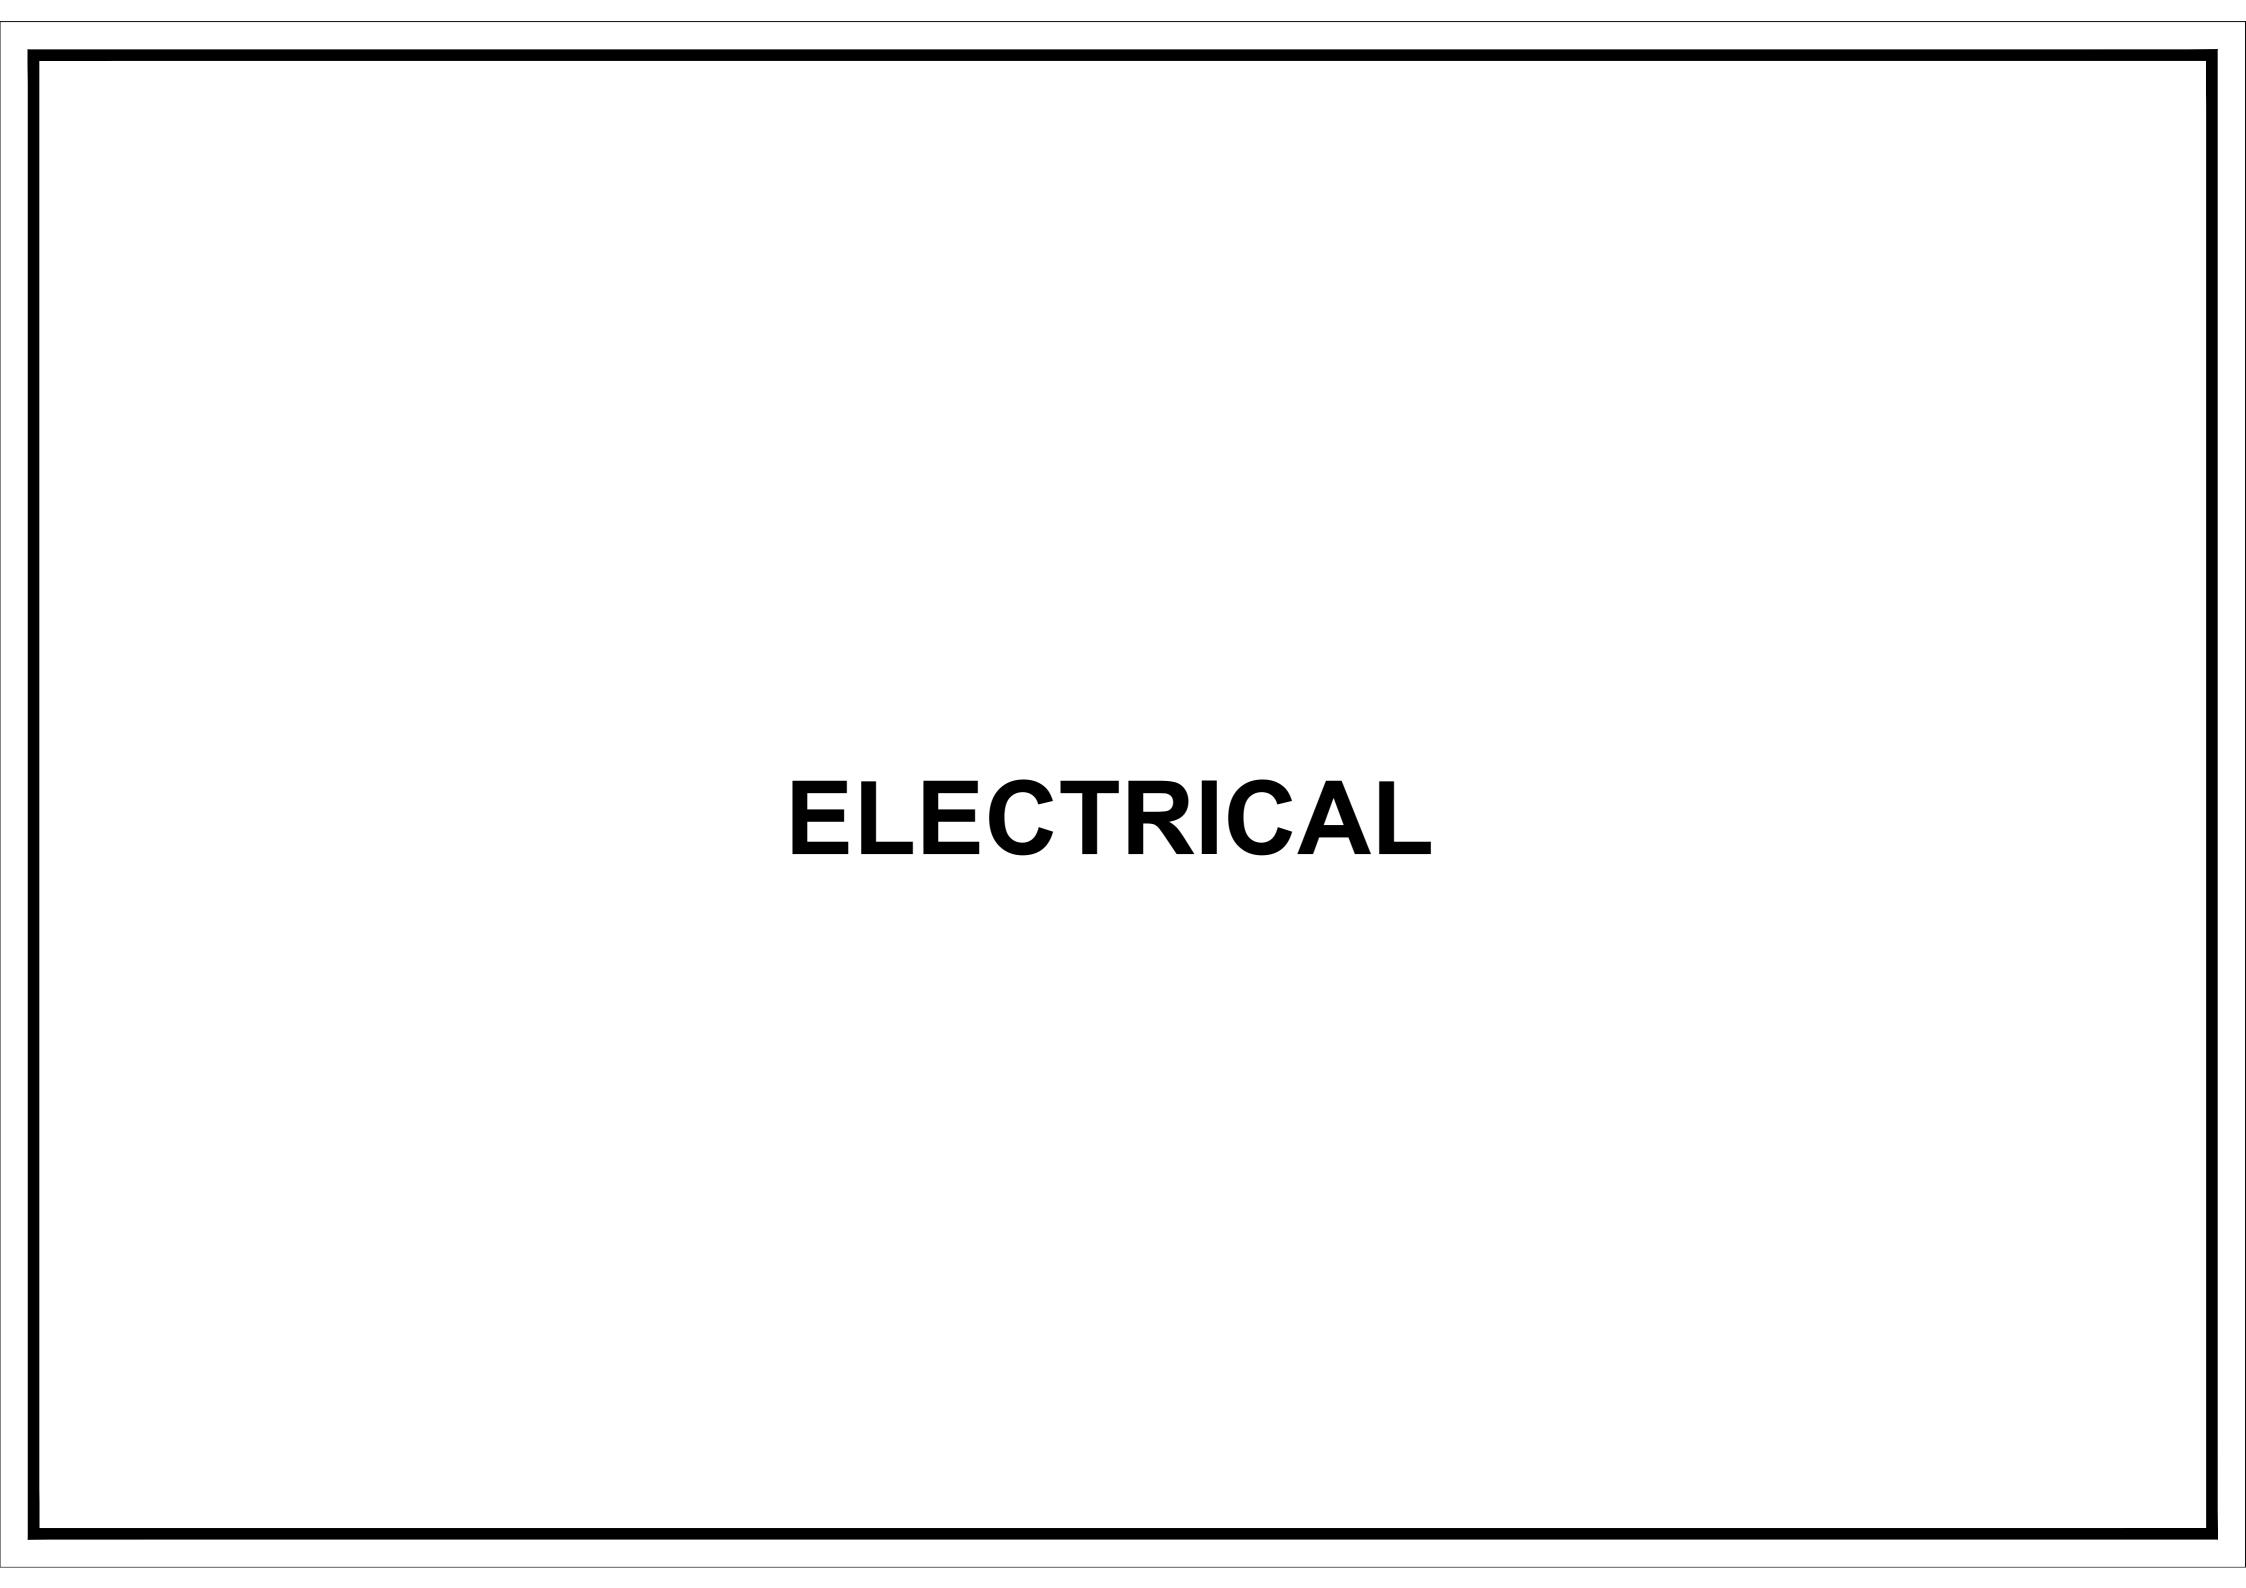

LIST OF DRAWINGS

S.NO.	S.NO. DRAWING TITLE							
	ELECTRICAL DRAWINGS							
1	1 LIST OF DRAWING							
2	2 GENERAL NOTES							
3	FIRE ALARM TYPICAL DETAIL	EL-02						
4	MOUNTING HEIGHT OF FIXTURE DETAIL	EL-03						
5	LEGEND AND SYMBOLS	EL-04						
6	EARTHING DETAIL	EL-05						
7	DISTRIBUTION BOARD DB-LIGHTING & POWER	EL-06						
8	LIGHTING LAYOUT	EL-07						
9 POWER LAYOUT		EL-08						
10	FIRE ALARM SYSTEM LAYOUT	EL-09						

ADDITION & REVISION						
ADD./REV. NO.	DATE	DESCRIPTION	DES. BY	CHK. BY	APP. BY	

Head Office: Office No.B-6 Second Floor Masood Arcade IJP Road Islamabad. Ph: +92-51-4848375, Fax: +92-51-4848375 Email: newvisionec@yahoo.com

Regional Office: 287-A Street # 6, Cavalry Ground ,Lahore Ph: +92-42-37250130

	PROJECT:	CLIENT:
T	UPGRADATION AND IMPROVEMENT OF PEOPLE NURSING SCHOOL, LIAQUAT UNIVERSITY OF	LIA
	MEDICIAL & HEALTH SCIENCE JAMSHORO	DESIGNED
	TITLE: LUMHS ACADEMIC BLOCK	ENGR
	LIST OF DRAWING	DRAWN B
	LIST OF DRAWING	ENGR

LIAQUAT UNIVERSITY OF MEDICIAL & HEALTH SCIENCE JAMSHORO						
DESIGNED BY:	APPROVED BY:	DATE:	APRIL. 2024			
ENGR. SHADAB	A.S		711 1112, 2024			
DRAWN BY:	JOB NO.	SCALE:				
ENGR. AHMAD			N.T.S			

CAD filename:

EL-00

GENERAL NOTES

ELECTRICAL SYSTEMS

- FOLLOWING NOTES SHALL IN GENERAL APPLY TO ALL ELECTRICAL DRAWINGS. THE INSTRUCTIONS IN THESE NOTES SHALL BE FOLLOWED UNLESS STATED OTHERWISE.
- 2. THESE NOTES SHALL BE APPLICABLE TO THE ENTIRE ELECTRICAL WORKS. IF THE SITE CONDITIONS NECESSITATE ANY ALTERATIONS OR DEVIATIONS THE DIRECTIONS OF THE ENGINEER SHALL BE OBSERVED AS FINAL INSTRUCTIONS.
- 3. ALL ELECTRICAL DRAWINGS SHALL BE READ IN CONJUNCTION WITH BOQ. TECHNICAL SPECIFICATIONS, ARCHITECTURAL, STRUCTURAL, PLUMBING AND HVAC DRAWINGS & ALL OTHER RELEVANT DETAILS.
- 4. DIMENSIONS/MEASUREMENTS GIVEN IN LAYOUT AND DETAILED DRAWINGS ARE APPROXIMATE. THE CONTRACTOR SHALL BE RESPONSIBLE TO CALCULATE THE ACTUAL DIMENSIONS/ MEASUREMENTS ACCORDING TO STRUCTURAL AND ARCHITECTURAL DRAWINGS.
- 5. THE CONTRACTOR SHALL SUBMIT SHOP DRAWINGS WITH ALL RELEVANT DETAILS TO THE ENGINEER FOR APPROVAL ACCORDING TO THE GENERAL CONDITIONS OF CONTRACT WELL IN TIME BEFORE COMMENCEMENT OF THAT WORK.
- 6. PROPER CO-ORDINATION OF ELECTRICAL WORKS WITH OTHER SERVICES SHALL BE CARRIED OUT AT SITE.
- 7. ALL NON CURRENT CARRYING PARTS i.e. OUTER CASINGS OF EQUIPMENT SUCH AS HT & LT PANELS. DISTRIBUTIONS BOARDS. CABLE TRAYS, AUXILIARY CONSTRUCTIONS FOR EQUIPMENT ETC. SHALL BE CONNECTED TO THE GROUNDING/ EARTHING SYSTEM AT REQUIRED NUMBER OF POINTS WITH SPECIFIED SIZES OF CONDUCTORS. WATER PIPES ALONG ELECTRICAL LINE SHALL BE BONDED TO THE EARTHING SYSTEM WITH 10 sq.mm. SINGLE CORE, COPPER CONDUCTOR PVC CABLE.
- 8. ELECTRICAL POINTS FOR EQUIPMENT SHALL BE INSTALLED IN CO-ORDINATION WITH THE RELEVANT DRAWINGS OF OTHER SERVICES, SUCH AS COMMUNICATION SYSTSMS, HVAC, PLUMBING ETC. THE LOCATION ON ELECTRICAL DRAWINGS IS ONLY INDICATIVE.
- 9. ARRANGEMENT OF ELECTRICAL EQUIPMENTS ON ELECTRICAL DRAWINGS ARE TENTATIVE. EXACT ARRANGEMENT OF EQUIPMENTS SHALL BE MADE IN VIEW OF ITS PHYSICAL DIMENSIONS AND EASE OF MAINTENANCE. AND AS PER SITE REQUIREMENTS.
- 10. LOADS ON ALL PHASES SHALL BE BALANCED AT THE TESTING/ COMMISSIONING STAGE.
- 11. CONDUIT/DUCT RUN UNDER FLOOR SHALL HAVE A MINIMUM COVER OF TWO INCHES FROM TOP OF CONDUIT/DUCT TO FINISH FLOOR LEVEL.
- 12. RUN GREEN-YELLOW OR GREEN SINGLE CORE PVC INSULATED COPPER CONDUCTOR CABLE OF SPECIFIED SIZES AS PROTECTIVE EARTH CONDUCTOR (ECC) ALL ALONG LIGHT AND POWER WIRING. WHEREVER THE SIZE IS NOT SPECIFIED THE FOLLOWING CRITERIA SHALL BE OBSERVED TO DETERMINE MINIMUM CROSS SECTIONAL AREA OF EARTH CONTINUITY CONDUCTOR (ECC) IN RELATION TO THE AREA OF ITS PHASE CONDUCTORS. RUN SEPARATE ECC FOR EACH CIRCUIT.
- FCC & PHASE CONDUCTOR OF SAME SIZE FOR UPTO AND INCLUDING 16 SQMM CABLES
- 16 SQMM ECC FOR PHASE CONDUCTOR OF 16 SQMM, 25SQMM & 35 SQMM CABLES

- MAXIMUM SIZE OF ECC IS 70 SQMM.

- FOR CABLES OF 50 SQMM AND ABOVE SIZES, ECC IS HALF SIZE OF PHASE CONDUCTOR.

ELECTRICAL SYSTEMS

13. THE MAXIMUM CAPACITY OF PVC CONDUITS FOR SIMULTANEOUS DRAWING OF PVC INSULATED CABLES SHALL BE DETERMINED AS PER BS 4607. THE FOLLOWING TABLE SHALL BE USED TO DETERMINE THE MAXIMUM NUMBER OF CABLES.

S. #	NOMINAL CONDUCTOR SIZE(SQMM)	NO. & DIA OF WIRES	NOMINAL OVERALL DIA	20 MM DIA (3/4" DIA)	25 MM DIA (1" DIA)	32 MM DIA (11/ " DIA)
1	1.5	1/1.38	3.1	10	18	30
2	2.5	1/1.78	3.5	8	14	23
3	2.5	7/0.67	3.8	7	12	20
4	4	7/0.85	4.3	5	9	15
5	6	7/1.04	4.9	4	7	12
6	10	7/1.35	6.2	2	4	7
7	16	7/1.70	7.3	-	3	5
8	25	7/2.14	9.0	-	2	3
9	35	19/1.53	10.3	-	-	2

- 14. NORMAL & EMERGENCY CIRCUITS SHALL RUN IN SEPARATE CONDUITS.
- 15. ALL WIRING FOR CONTROLS SHALL BE CARRIED OUT WITH 1 CORE PVC CABLES OF SPECIFIED VOLTAGE GRADE AND SIZES.
- 16. THE WIRING SHALL BE CONTINUOUS LOOPING-IN TYPE AND NO JOINT IN WIRES SHALL BE ALLOWED.
- 17. THE WIRING SYSTEM SHALL BE CARRIED OUT ONLY AFTER THE CONDUIT SYSTEM IS COMPLETELY INSTALLED AND ALL OUTLET BOXES. ETC. ARE FIXED IN POSITION.
- 18. MOUNTING HEIGHTS OF ELECTRICAL FITTINGS WHEN MEASURED FROM FINISHED FLOOR LEVEL (F.F.L.) TO THE BOTTOM OF FITTINGS SHALL BE AS UNDER, UNLESS OTHERWISE SHOWN OR INSTRUCTED.

MAIN SWITCH BOARD	48 INCHES
DISTRIBUTION BOARD	48 INCHES
CONTROL PANEL	48 INCHES
ON/OFF PUSH BUTTON STATION	48 INCHES
DIMMER CONTROL UNIT	48 INCHES
LIGHT CONTROL SWIT(CINE WAY/TWO WAY)	48 INCHES
5A SOCKET OUTLETS IN GENERAL AREAS	10 INCHES
15A SOCKET OUTLETS IN GENERAL AREAS	10 INCHES
20A SOCKET OUTLETS IN GENERAL AREAS	10 INCHES
15A SOCKET OUTLETS IN KITCHEN (ABOVE COUNTER)	10 INCHES
15A SOCKET OUTLETS IN TOILETS	66 INCHES
16A TP 5PIN INDUSTRIAL SOCKET OUTLETS IN LABS.	48 INCHES
32A TP 5PIN INDUTRIAL SOCKET OUTLETS IN LABS	48 INCHES
63A TP 5PIN INDUTRIAL SOCKET OUTLETS IN LABS.	48 INCHES
CEILING FAN	96 INCHES
WALL FAN	84 INCHES

1. FOLLOWING NOTES SHALL IN GENERAL APPLY TO ALL COMMUNICATION SYSTEMS DRAWINGS. THE INSTRUCTIONS IN THESE NOTES SHALL BE

COMMUNICATION SYSTEMS

FOLLOWED UNLESS STATED OTHERWISE. 2. THESE NOTES SHALL BE APPLICABLE TO THE ENTIRE COMMUNICATION SYSTEMS WORKS. IF THE SITE CONDITIONS NECESSITATE ANY

SHALL BE OBSERVED AS FINAL INSTRUCTIONS.

3. ALL COMMUNICATION SYSTEMS DRAWINGS SHALL BE READ IN CONJUNCTION WITH TECHNICAL SPECIFICATIONS, ITEMS OF B.O.Q., ARCHITECTURAL STRUCTURAL, HVAC, PLUMBING DRAWINGS AND ALL OTHER RELEVANT DETAILS.

ALTERATIONS OR DEVIATIONS THE DIRECTIONS OF THE ENGINEER

- 4. DIMENSIONS/MEASUREMENTS GIVEN IN LAYOUT AND DETAILED DRAWINGS ARE APPROXIMATE. THE CONTRACTOR SHALL BE RESPONSIBLE TO CALCULATE THE ACTUAL DIMENSIONS/MEASUREMENTS ACCORDING TO STRUCTURAL AND ARCHITECTURAL DRAWINGS.
- 5. THE CONTRACTOR SHALL SUBMIT SHOP DRAWINGS WITH ALL RELEVANT DETAILS TO THE ENGINEER FOR APPROVAL ACCORDING TO THE GENERAL CONDITIONS OF CONTRACT WELL IN TIME BEFORE COMMENCEMENT OF THAT WORK.
- 6. PROPER CO-ORDINATION OF COMMUNICATION SYSTEMS WORKS WITH OTHER SERVICES SHALL BE CARRIED OUT AT SITE.
- TELEPHONE SYSTEM SHALL BE COMPLETE WITH INSTRUMENTS, EQUIPMENT AND INTERCONNECTING WIRING, TELEPHONE EXCHANGE, TELEPHONE OUTLETS, JUNCTION BOXES, CONDUITS OF SPECIFIED SIZES IN THE BUILDING, AND UNDERGROUND PIPES OF SPECIFIED SIZES SHOWN ON DRAWINGS SHALL BE PROVIDED. WHERE SIZE OF CONDUIT/PIPE IS NOT SPECIFIED SUITABLE SIZE SHALL BE INSTALLED AS DIRECTED BY THE ENGINEER.
- 8. POINTS FOR COMMUNICATION SYSTEMS EQUIPMENT SHALL BE INSTALLED IN CO-ORDINATION WITH THE RELEVANT DRAWINGS OF OTHER SERVICES, SUCH AS ELECTRICAL, HVAC, PLUMBING ETC. THE LOCATION ON COMMUNICATION SYSTEMS DRAWINGS IS ONLY INDICATIVE.
- 9. ARRANGEMENT OF COMMUNICATION SYSTEMS EQUIPMENTS ON DRAWINGS ARE TENTATIVE EXACT ARRANGEMENT OF EQUIPMENTS SHALL BE MADE IN VIEW OF ITS PHYSICAL DIMENSIONS AND EASE OF MAINTENANCE.
- 10. CONDUIT/DUCT RUN UNDER FLOOR SHALL HAVE A MINIMUM COVER 2 INCHES FROM TOP OF CONDUIT/DUCT TO FINISH FLOOR LEVEL.
- 11. RUN GREEN-YELLOW OR GREEN SINGLE CORE PVC INSULATED COPPER CONDUCTOR CABLE OF SPECIFIED SIZES AS PROTECTIVE EARTH CONDUCTOR (ECC) ALL ALONG COMMUNICATION SYSTEMS WIRING.
- 12. ALL WIRING FOR CONTROLS SHALL BE CARRIED OUT WITH 1 CORE PVC CABLES OF SPECIFIED VOLTAGE GRADE AND SIZES.
- 13. THE WIRING SHALL BE CONTINUOUS LOOPING-IN TYPE AND NO JOINT IN WIRES SHALL BE ALLOWED.
- 14. THE WIRING SYSTEM SHALL BE CARRIED OUT ONLY AFTER THE CONDUIT SYSTEM IS COMPLETELY INSTALLED AND ALL OUTLET BOXES. ETC. ARE FIXED IN POSITION.
- 15. MOUNTING HEIGHTS OF ELECTRICAL FITTINGS WHEN MEASURED FROM FINISHED FLOOR LEVEL (F.F.L.) TO THE BOTTOM OF FITTINGS SHALL BE AS UNDER, UNLESS OTHERWISE SHOWN OR INSTRUCTED.

TELEPHONE JUNCTION BOX	10 INCHES
TELEPHONE OUTLET	10 INCHES
INTERCOM CONTROL PACK	10 INCHES
INTERCOM STATION (WALL MOUNTED)	36 INCHES
FA SYSTEM CONTROL PANEL	36 INCHES
FA SYSTEM JUNCTION BOX	10 INCHES
MANUAL CALL STATION	42 INCHES
AUDIO ALARM	100 INCHES

ADDITION & REVISION

EXHAUST FAN

NEW VISION ENGINEERING CONSULTANT Head Office: Office No.B-6 Second Floor Masood Arcade IJP Road Islamabad. Ph: +92-51-4848375, Fax: +92-51-4848375 Email: newvisionec@yahoo.com


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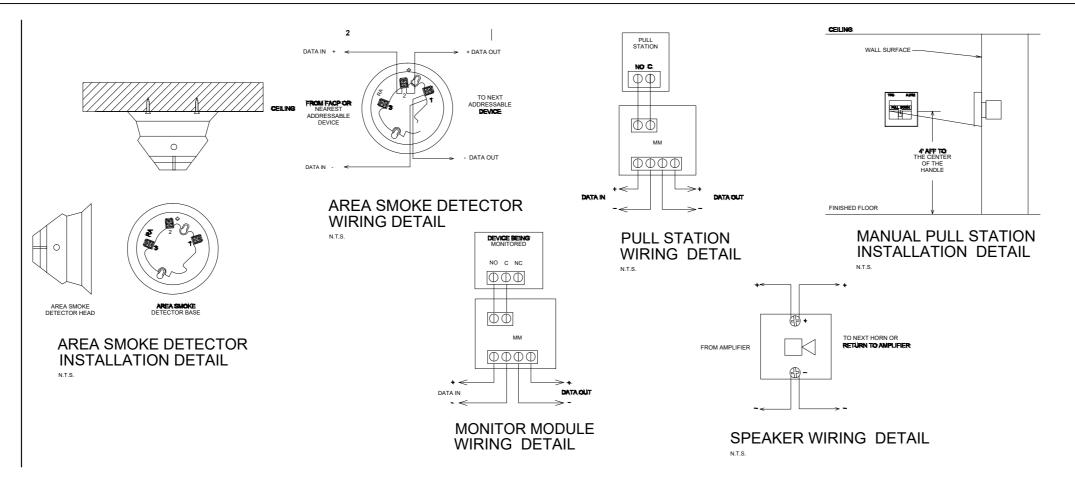
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Ph: +92-42-37250130	


PROJECT: UPGRADATION AND IMPROVEMENT OF PEOPLE NURSING SCHOOL, LIAQUAT UNIVERSITY OF	CLIENT: LIAQUAT UNIVERSITY OF MEDICIAL & HEALTH SCIENCE JAMSHORO			
MEDICIAL & HEALTH SCIENCE JAMSHORO TITLE: LUMHS ACADEMIC BLOCK	DESIGNED BY: ENGR. SHADAB	APPROVED BY: A.S	DATE : APRIL, 2024	
GENERAL NOTES	DRAWN BY: ENGR. AHMAD	JOB NO.	SCALE: N.T.S	
CAD filename:	DRG. NO.	EL-01		

DETAIL : A-2(a)

FIRE ALARM AND PUBLIC ADDRESS SYSTEM COMPONENT CONNECTION DETAIL.



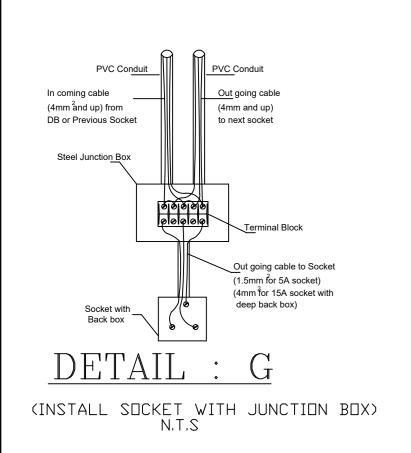


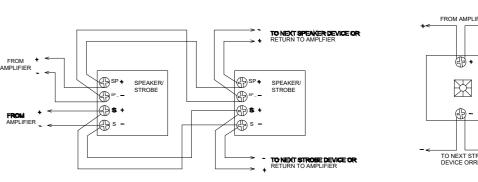

SPEAKER/STROBE WIRING DETAIL


STROBE WIRING DETAIL

DETAIL: H

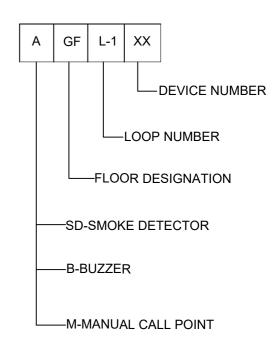

NOTES:


Location of FACP & Integration with existing Fire Alarm System if existed to be decided as per site requirements & as per approval of the Client's Representative.

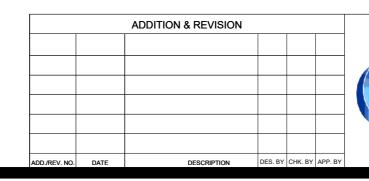



Regional Office: 287-A Street # 6, Cavalry Ground ,Lahore	
Ph: +92-42-37250130	

ROJECT: UPGRADATION AND IMPROVEMENT OF PEOPLE NURSING SCHOOL, LIAQUAT UNIVERSITY OF	CLIENT: LIAQUAT UNIVERSITY OF MEDICIAL & HEALTH SCIENCE JAMSHORO			
MEDICIAL & HEALTH SCIENCE JAMSHORO TLE: LUMHS ACADEMIC BLOCK	DESIGNED BY: ENGR. SHADAB	APPROVED BY: A.S	DATE : APRIL, 2024	
FIRE ALAM TYPICAL DETAIL	DRAWN BY: ENGR. AHMAD	JOB NO.	SCALE: N.T.S	
CAD filename:	DRG. NO.	EL-02		

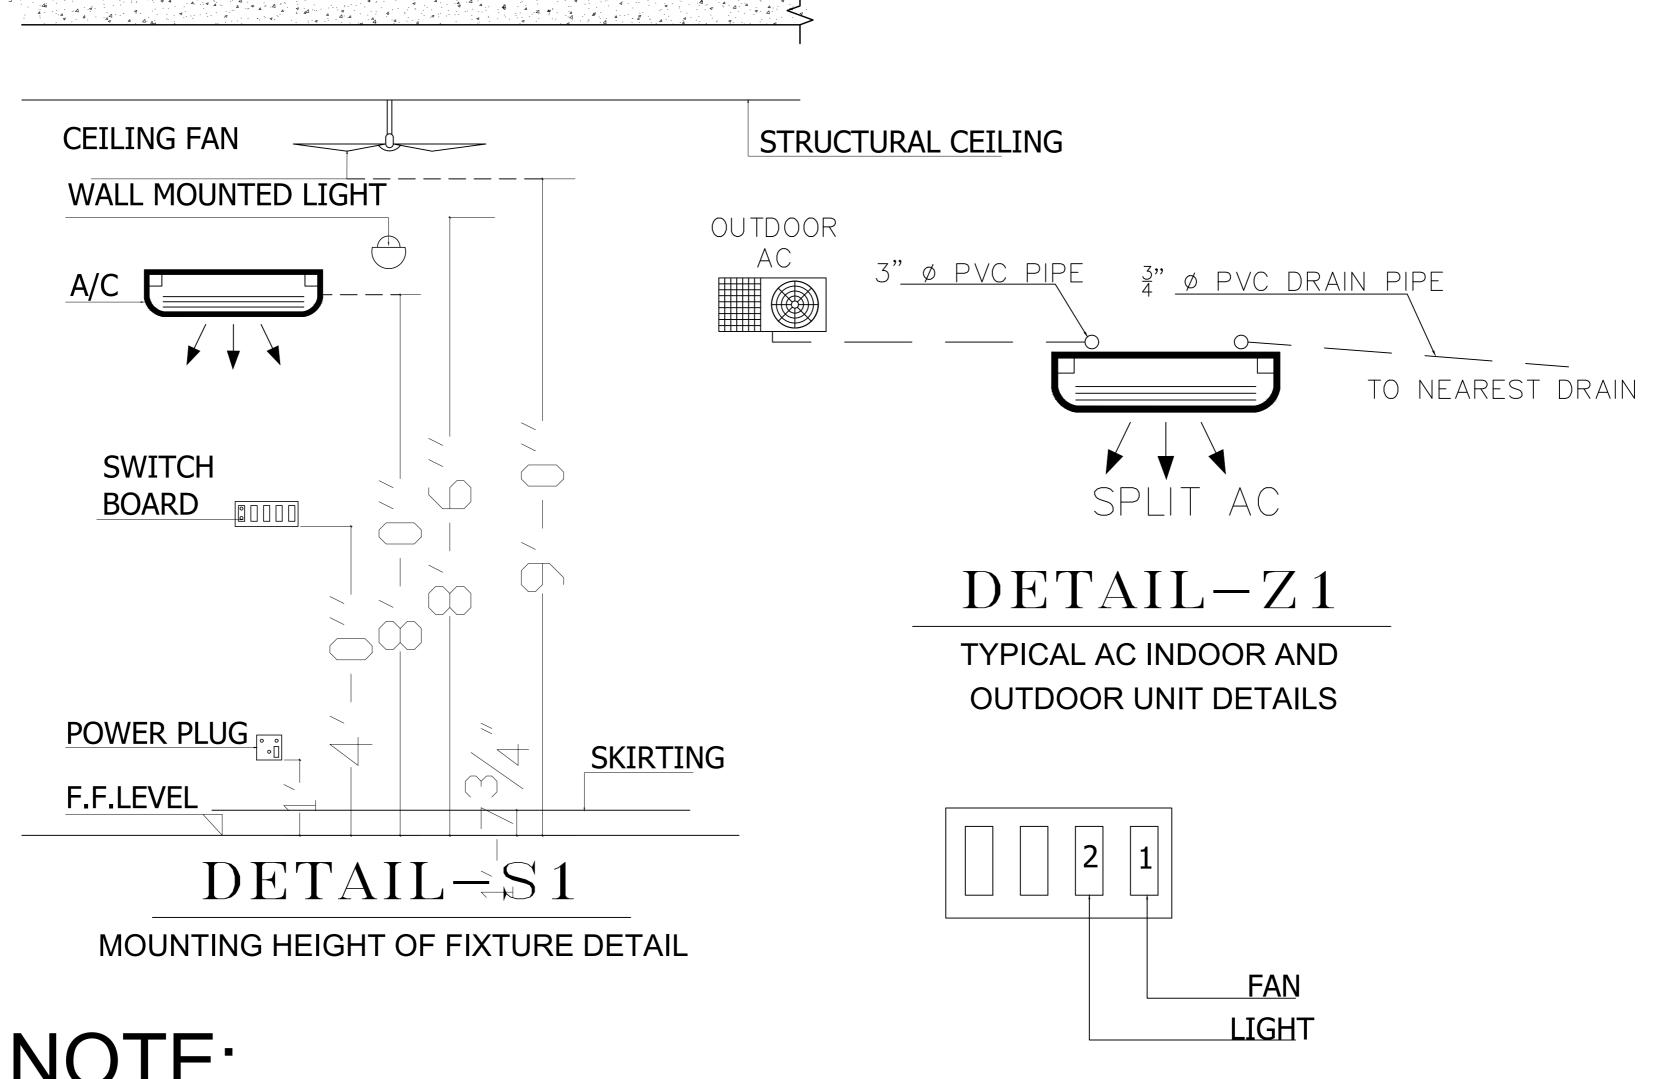

LOCATION OF ACs INDOOR, OUTDOOR UNIT AND ACs POWER SOCKETS IN APARTMENTS AREA ARE TENTATIVE SUBJECT TO FINAL FININSHING DETAIL DECIDED BY CLIENT, ARCHITECT IN CHARGE AND CONCERENED SITE ENGINEER

	ADDITION & REVISION							N	NEW VISION ENGINEERING CONSULTANT Head Office: Office No.B-6 Second Floor Masood Arcade		PROJECT: UPGRADATION AND IMPROVEMENT OF PEOPLE NURSING SCHOOL, LIAQUAT UNIVERSITY OF		CLIENT: LIAQUAT UNIVERSITY OF MEDICIAL & HEALTH SCIENCE JAMSHORO		
						NVEC		EC	IJP Road Islamabad.	MEDICIAL & HEALTH SCIENCE JAMSHORO TITLE: LUMHS ACADEMIC BLOCK MOUNTING HEIGHT OF FIXTURE DETAIL		DESIGNED BY: ENGR. SHADAB DRAWN BY: ENGR. AHMAD	APPROVED BY: A.S JOB NO.	SCALE:	PRIL, 2024 N.T.S
ADD./REV. N	NO. DATE	E	DESCRIPTION	DES. B	Y CHK.	BY APP. BY	(Ph: +92-42-37250130		ne:	DRG. NO.	,	EL-03	


LIGHTING AND POWER

s.NO	SYMBOLS	DESCRIPTION						
1		24 WATT LED/SMD LIGHT FIXTURE OR EQUIVALENT						
2	•	18 WATT LED LIGHT FIXTURE SURFACE/RECESSED MOUNTED OR EQUIVALE						
3	Ø	12 WATT LED LIGHT FIXTURE SURFACE/RECESSED MOUNTED, IP-44 RATED OR EQUIVALENT.						
4	lacktriangle	10 " DIA EXHAUST FAN WITH PLASTIC BODY, FAN BLADES AND LOUVERS						
5	48" OR 56" DIA CEILING FAN							
6	INDICATES GANG TYPE SWITCH 10 AMPS, INDICATES NUMBER OF SWITCHES ON SWITCH PLATE							
7	<u> </u>	INDICATES 3 PIN COMBINED SWITCH SOCKET 10-13 AMPS, ON PLASTIC BACK BOX						
8	Δ	COMPUTER SOCKET OUTLET RJ45						
9	\triangle	INDICATES ROUND PIN 15 AMPS SOCKET, ON PLASTIC BACK BOX						
10		20 Watt Flood Light						
11	DB-XXX	DISTRIBUTION BOARD(DB-XXX) XXX-DENOTES NAME						
12	D-	A.C 40 TP AMPS SWITCH & Unit (4 Ton)						
13	A II	A.C 20 SP AMPS SWITCH & unit(2 Ton)						
14	Data Cabinet	Data cabinet						

FIRE ALARM SYSTEM

S.NO	SYMBOLS	DESCRIPTION
1	FACP	FIRE ALARM CONTROL PANEL
2	SD	SMOKE DETECTOR NON IONISATION TYPE.
3	M & S	MANUAL STATION & ALARM SOUNDER


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ore	TITLE:	LUMHS ACADEMIC BLOCK LEGEND AND SYMBOLS
	CAD filename:	

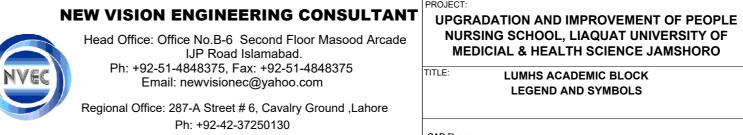NURSING SCHOOL, LIAQUAT UNIVERSITY OF MEDICIAL & HEALTH SCIENCE JAMSHORO

CLIENT: LIAQUAT UNIVERSITY OF MEDICIAL & HEALTH SCIENCE JAMSHORO								
	DESIGNED BY: ENGR. SHADAB	APPROVED BY: A.S	DATE :	APRIL, 2024				
	DRAWN BY: ENGR. AHMAD	JOB NO.	SCALE:	N.T.S				
	DRG. NO.	EL-04						



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ADD./REV. NO.	DATE	DESCRIPTION	DES. BY	CHK. BY	APP. BY		

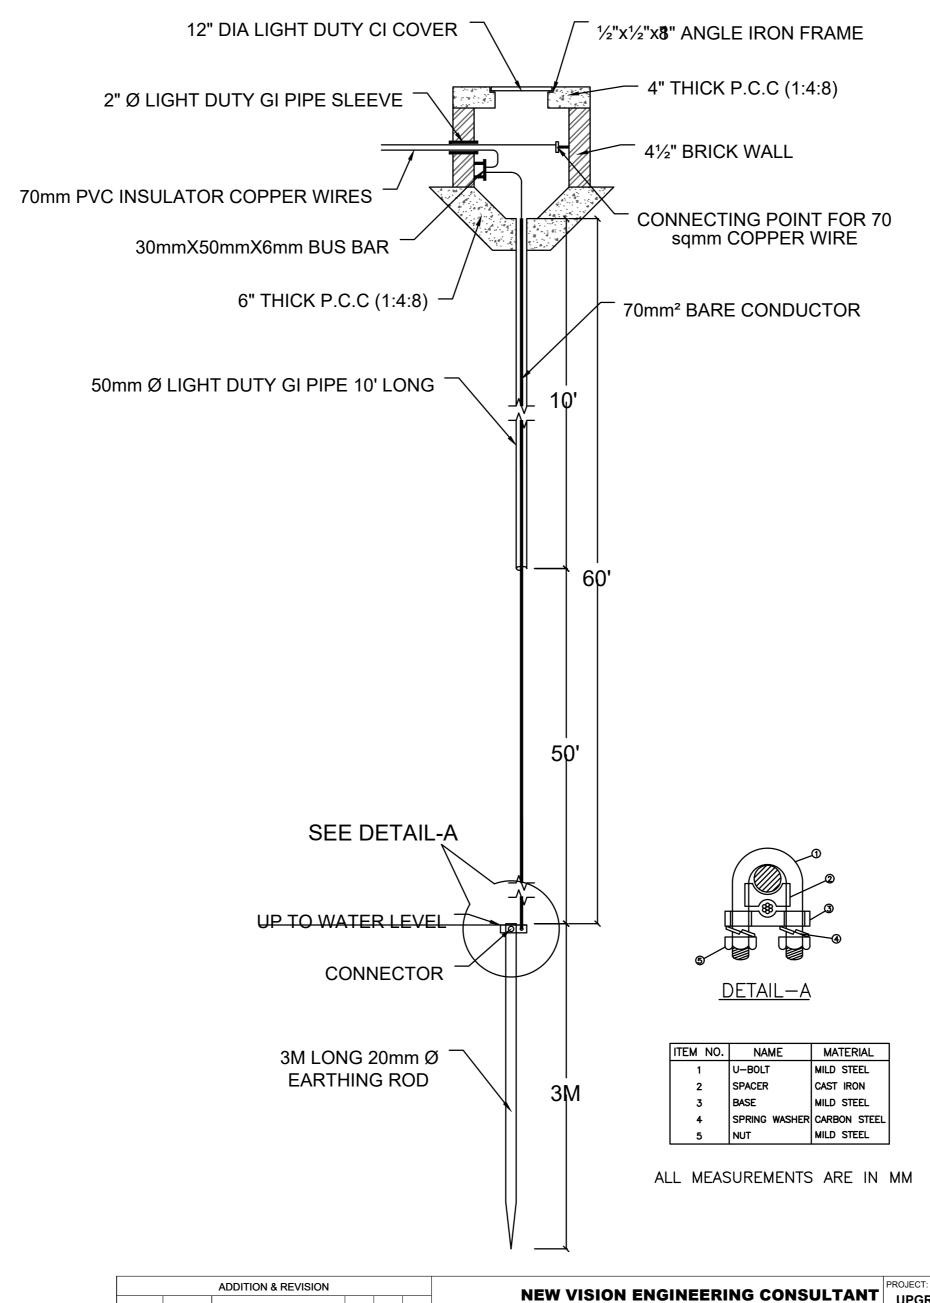Head Office: Office No.B-6 Second Floor Masood Arcade

IJP Road Islamabad. Ph: +92-51-4848375, Fax: +92-51-4848375 Email: newvisionec@yahoo.com

Regional Office: 287-A Street # 6, Cavalry Ground ,Lahore Ph: +92-42-37250130

PROJECT:
UPGRADATION AND IMPROVEMENT OF PEOPLE
NURSING SCHOOL, LIAQUAT UNIVERSITY OF
MEDICIAL & HEALTH SCIENCE JAMSHORO

NURSING SCHOOL, LIAQUAT UNIVERSITY OF MEDICIAL & HEALTH SCIENCE JAMSHORO					
ELUMHS ACADEMIC BLOCK	DESIGNED				
EARTHING DETAIL	DRAWN E				
	DRG. NO.				

CLIENT: LIAQUAT UNIVERSITY OF MEDICIAL & HEALTH SCIENCE JAMSHORO								
DESIGNED BY: ENGR. SHADAB	APPROVED BY: A.S	DATE :	APRIL, 2024					
DRAWN BY:	JOB NO.	SCALE:						

N.T.S EL-05 CAD filename:

